


# adisson Blu Telegraph Hotel

RUSTAVELI AVENUE , TBILISI , GEORGIA

# Electrical Power Block Diagram

HANDLING UNIT PANEL  
CURTAINS PANEL  
LER ROOM PANEL  
LLER POWER PANEL  
S PANEL  
E PUMPS PANEL  
E ALARM PANEL  
DOR DISTRIBUTION PANEL  
M DISTRIBUTION PANEL  
EST ELEVATOR PANEL  
ATING HOPPERS PANEL  
CHEN POWER PANEL  
RMAL LIGHTING PANEL  
ERGENCY LIGHTING PANEL  
TDOOR LIGHTING PANLE  
DIUM VOLTAGE PANEL (6kV)  
IN DISTRIBUTION PANEL (0.4kV)  
MP ROOM PANEL  
OM DISTRIBUTION PANEL  
CHNICAL ELEVATOR PANEL  
NTERRUPTABLE POWER SUPPLY  
ATER EQUIPMENT PANEL  
EAK CURRENT PANEL

ES:  
all and core according to drawings provided by client and  
e measurements.  
measurements to be checked on site prior to proceeding

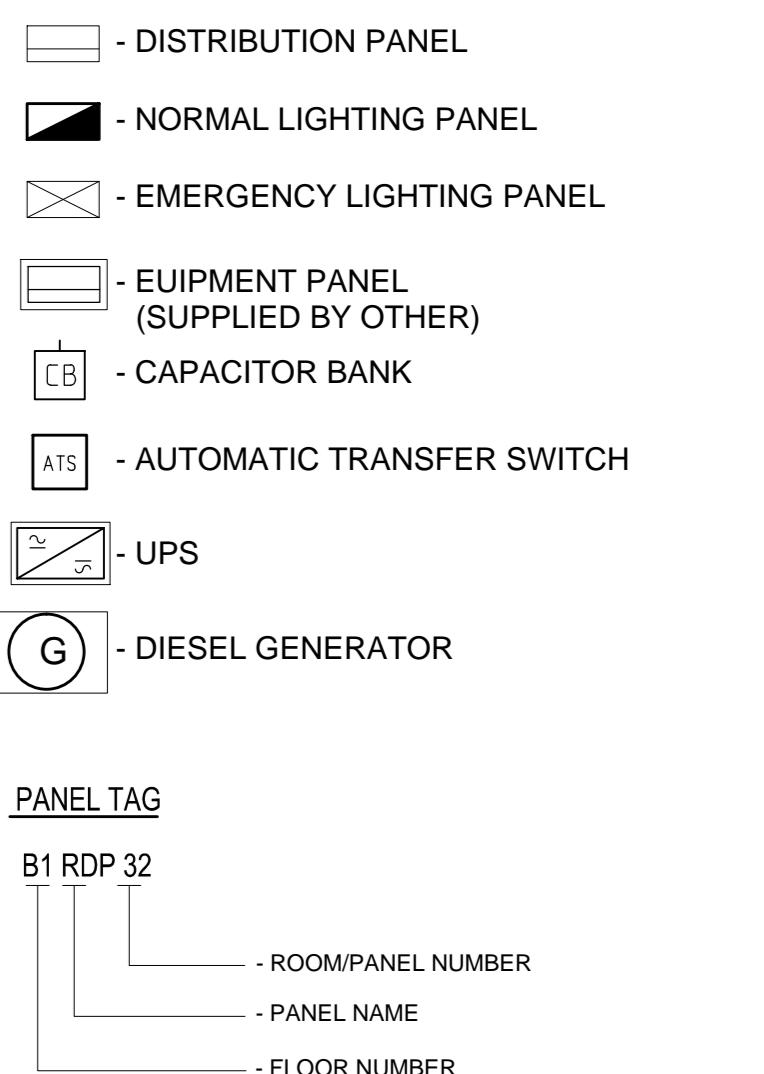

---

IT REVIEW STATUS

- A) REVIEWED  
Work may proceed
- B) REVIEWED WITH COMMENTS  
Revise and re-submit. Work may proceed subject to incorporation of comments
- C) OBJECTION  
Revise and re-submit. Work may not proceed
- D) REJECTED
- E) REVIEW NOT REQUIRED  
Work may proceed

Rock Road Business Center LLC

SIGN ENTITY (LDE) APPROVED BY LDE

AECOM DATE

SCALE	PAPER SIZE
1:100	A2

# PHASE II PER DOCUMENTO

# PER DOCUMENTS

R

AECOM

CKED BY	APPROVED BY
IE	NAME

F. A.S.  
E. 1/12/2015 DATE 2/12/2015

DATE 2/12/2013

# Telegraph Hotel


gram


gram


REVISION L


-GEN-003 TD0

16

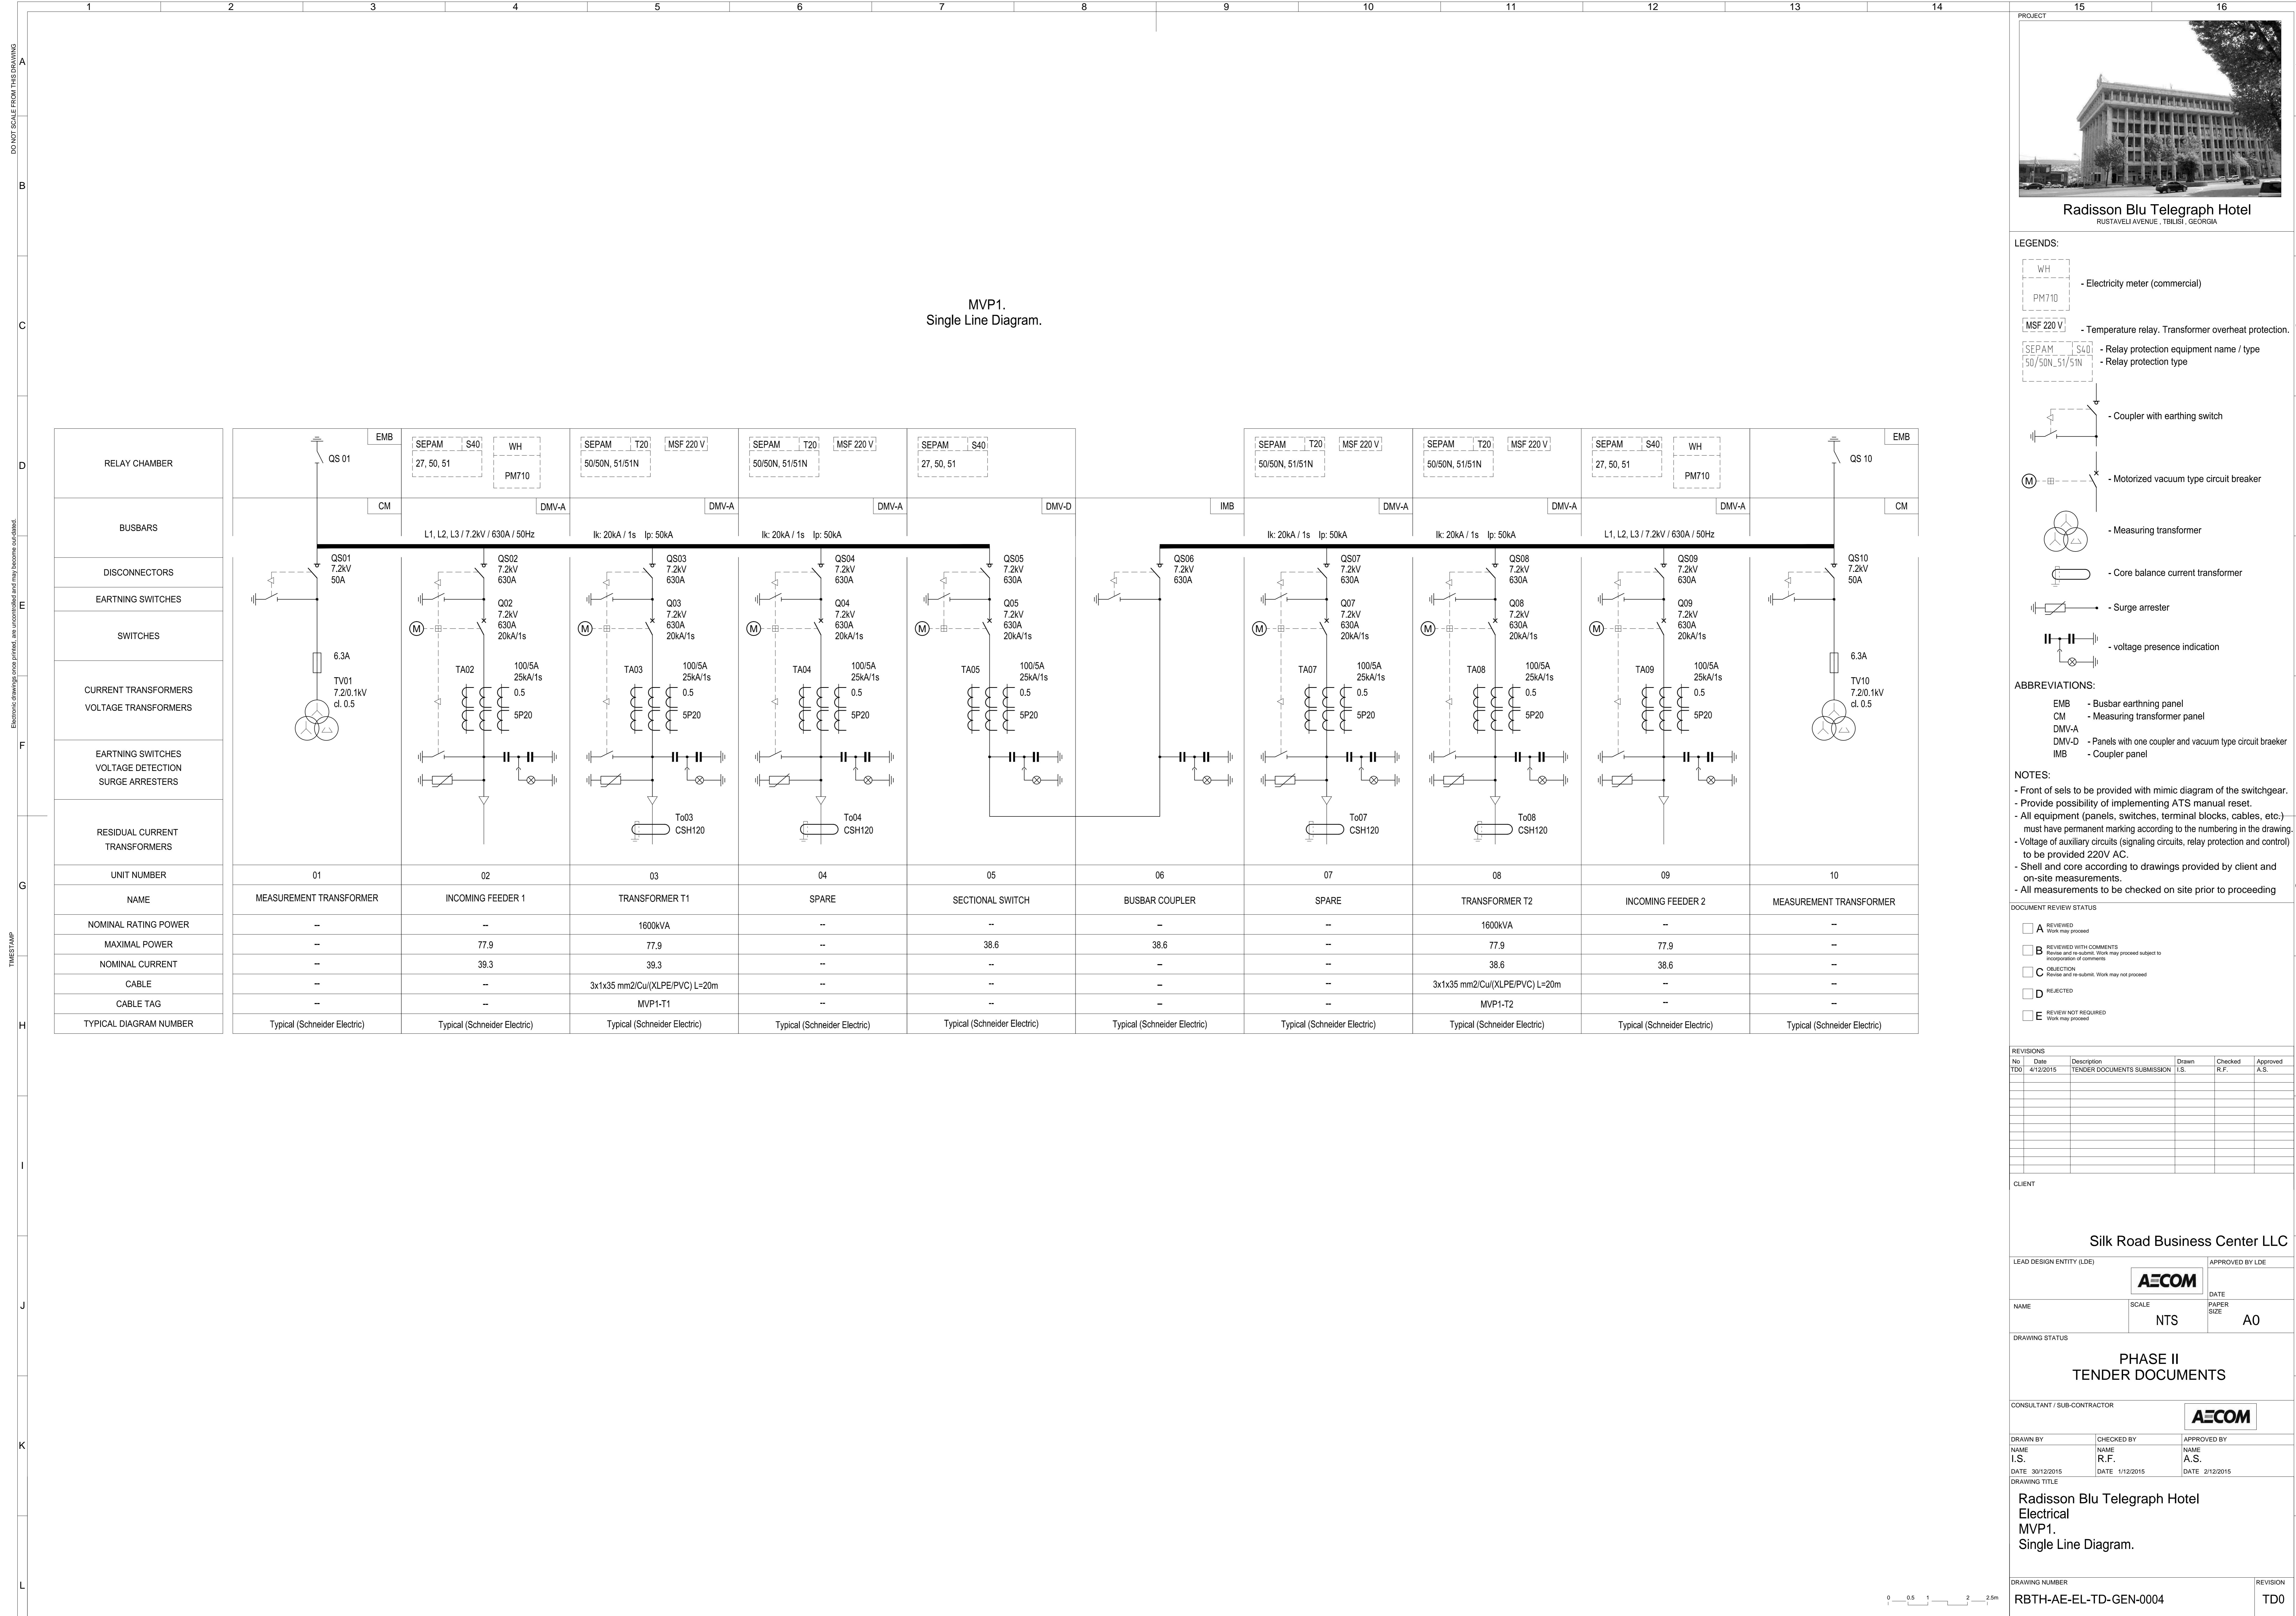

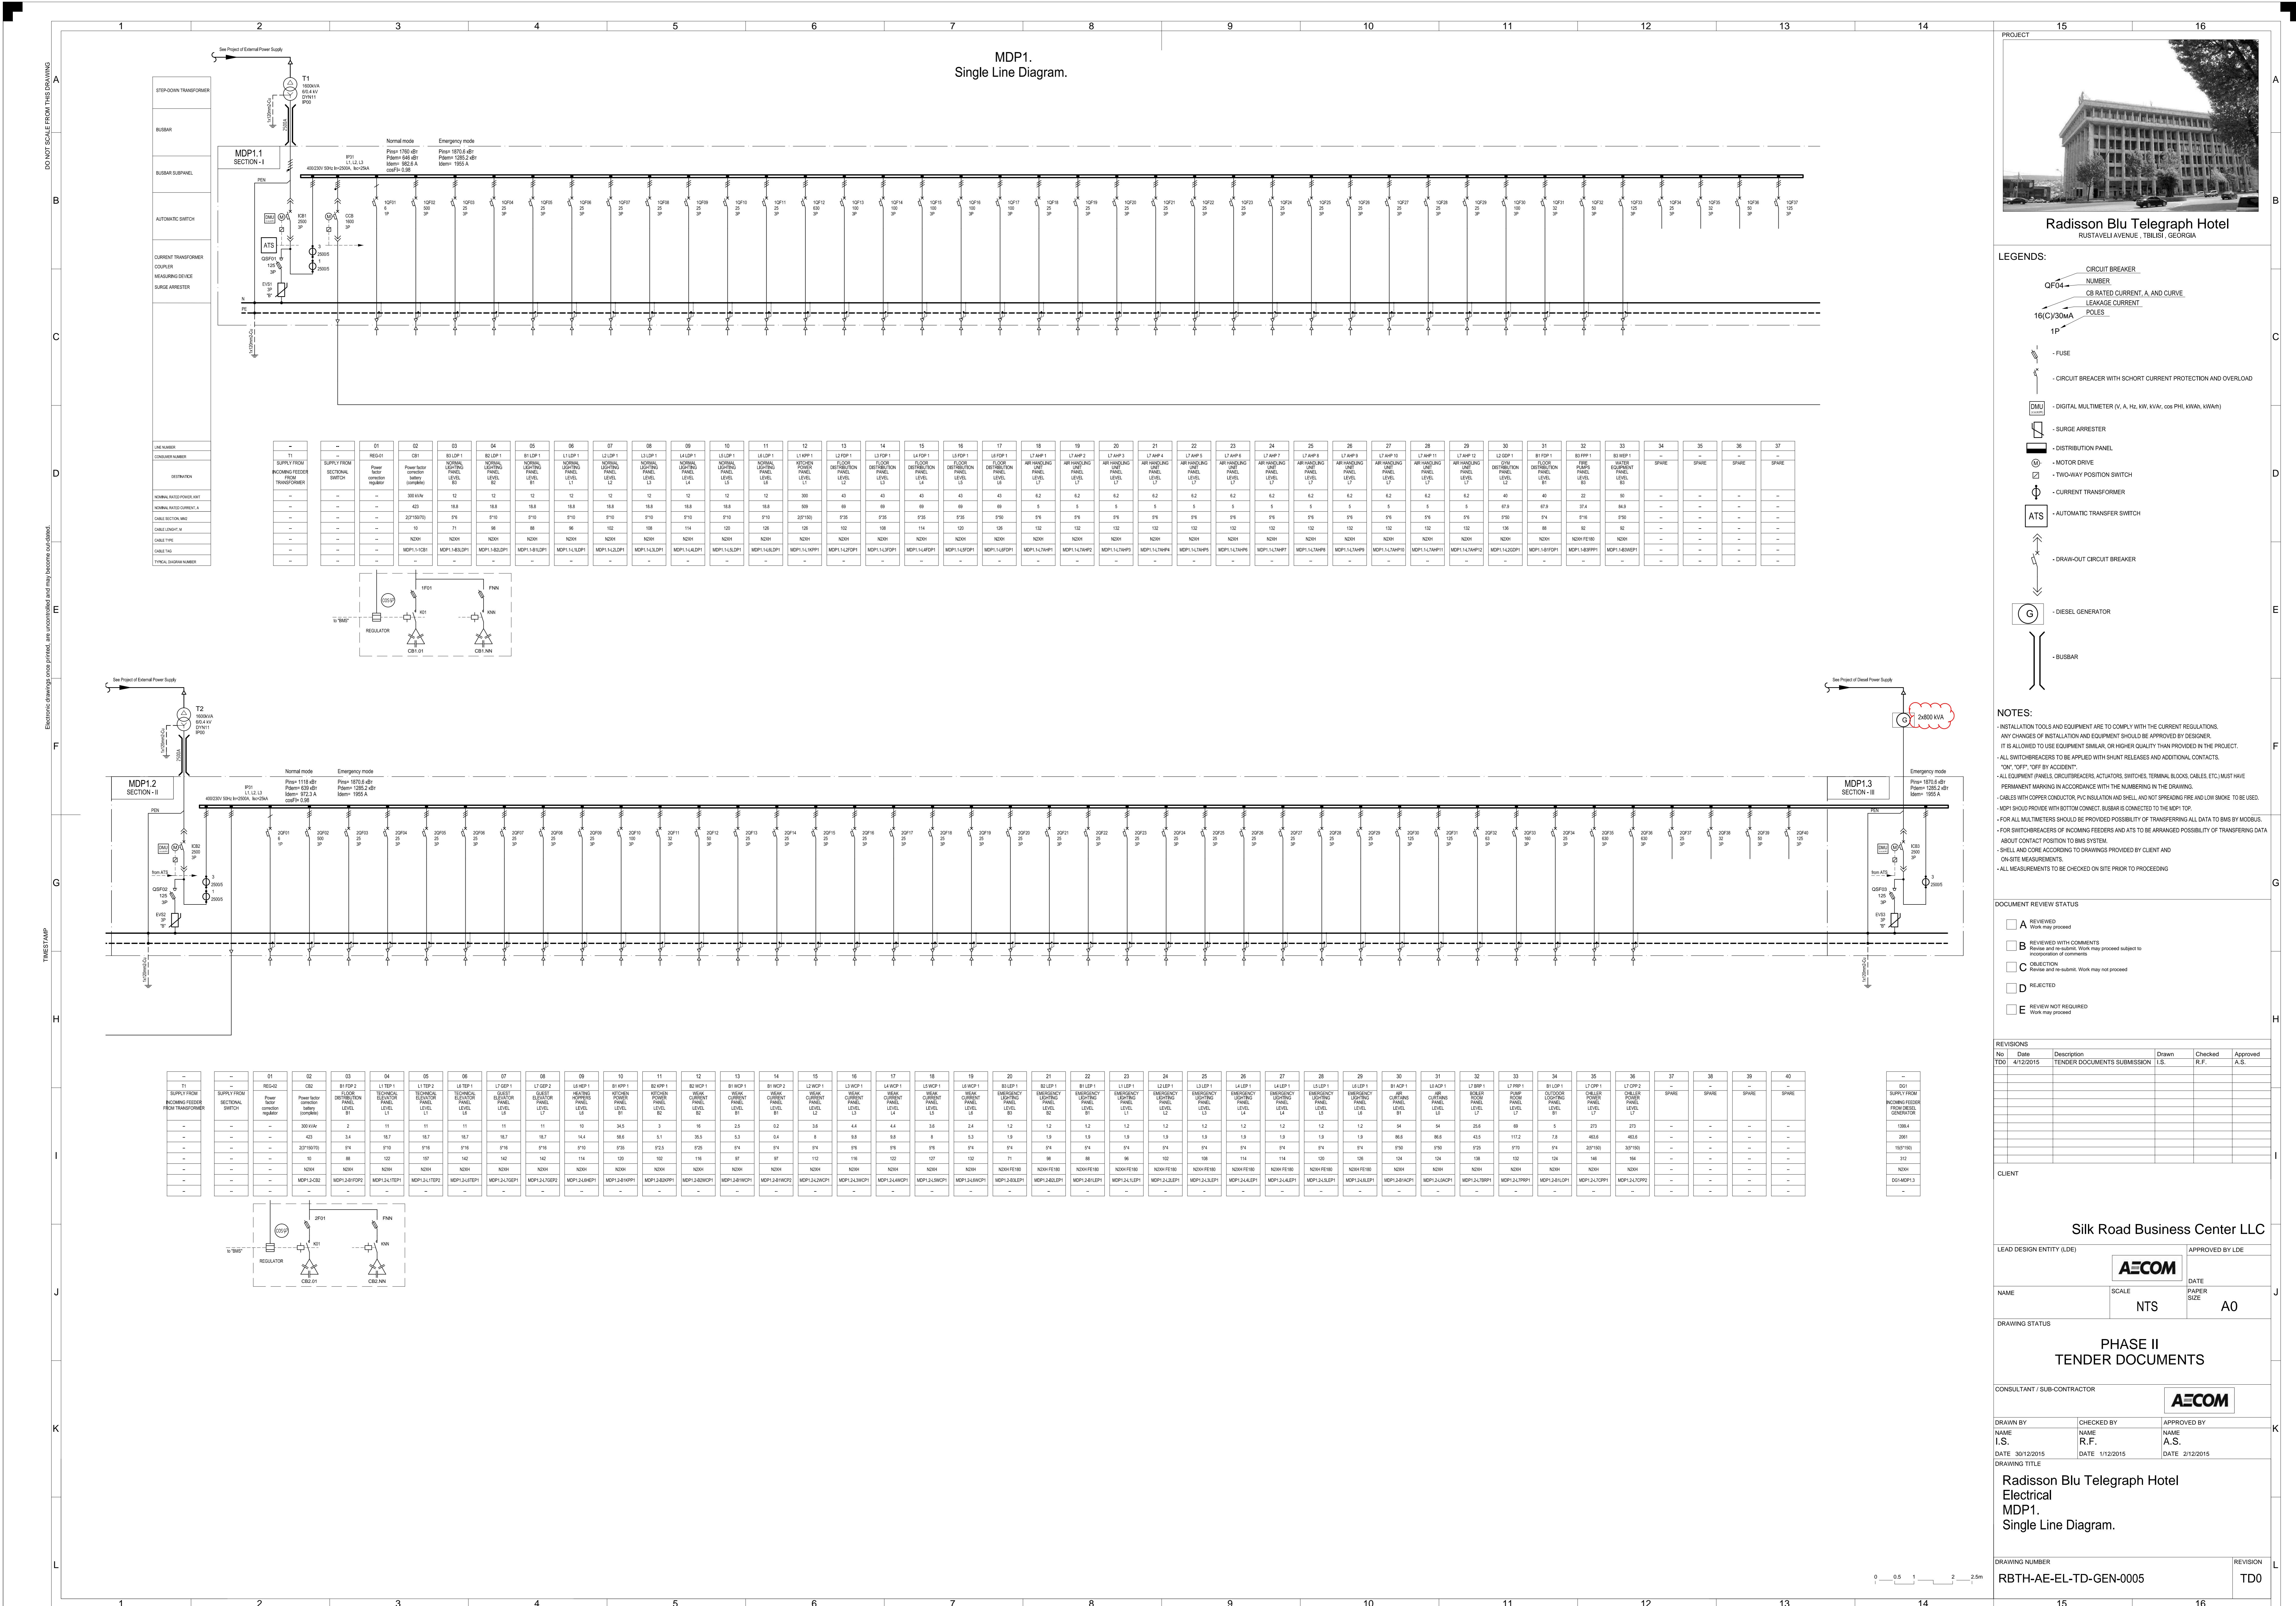

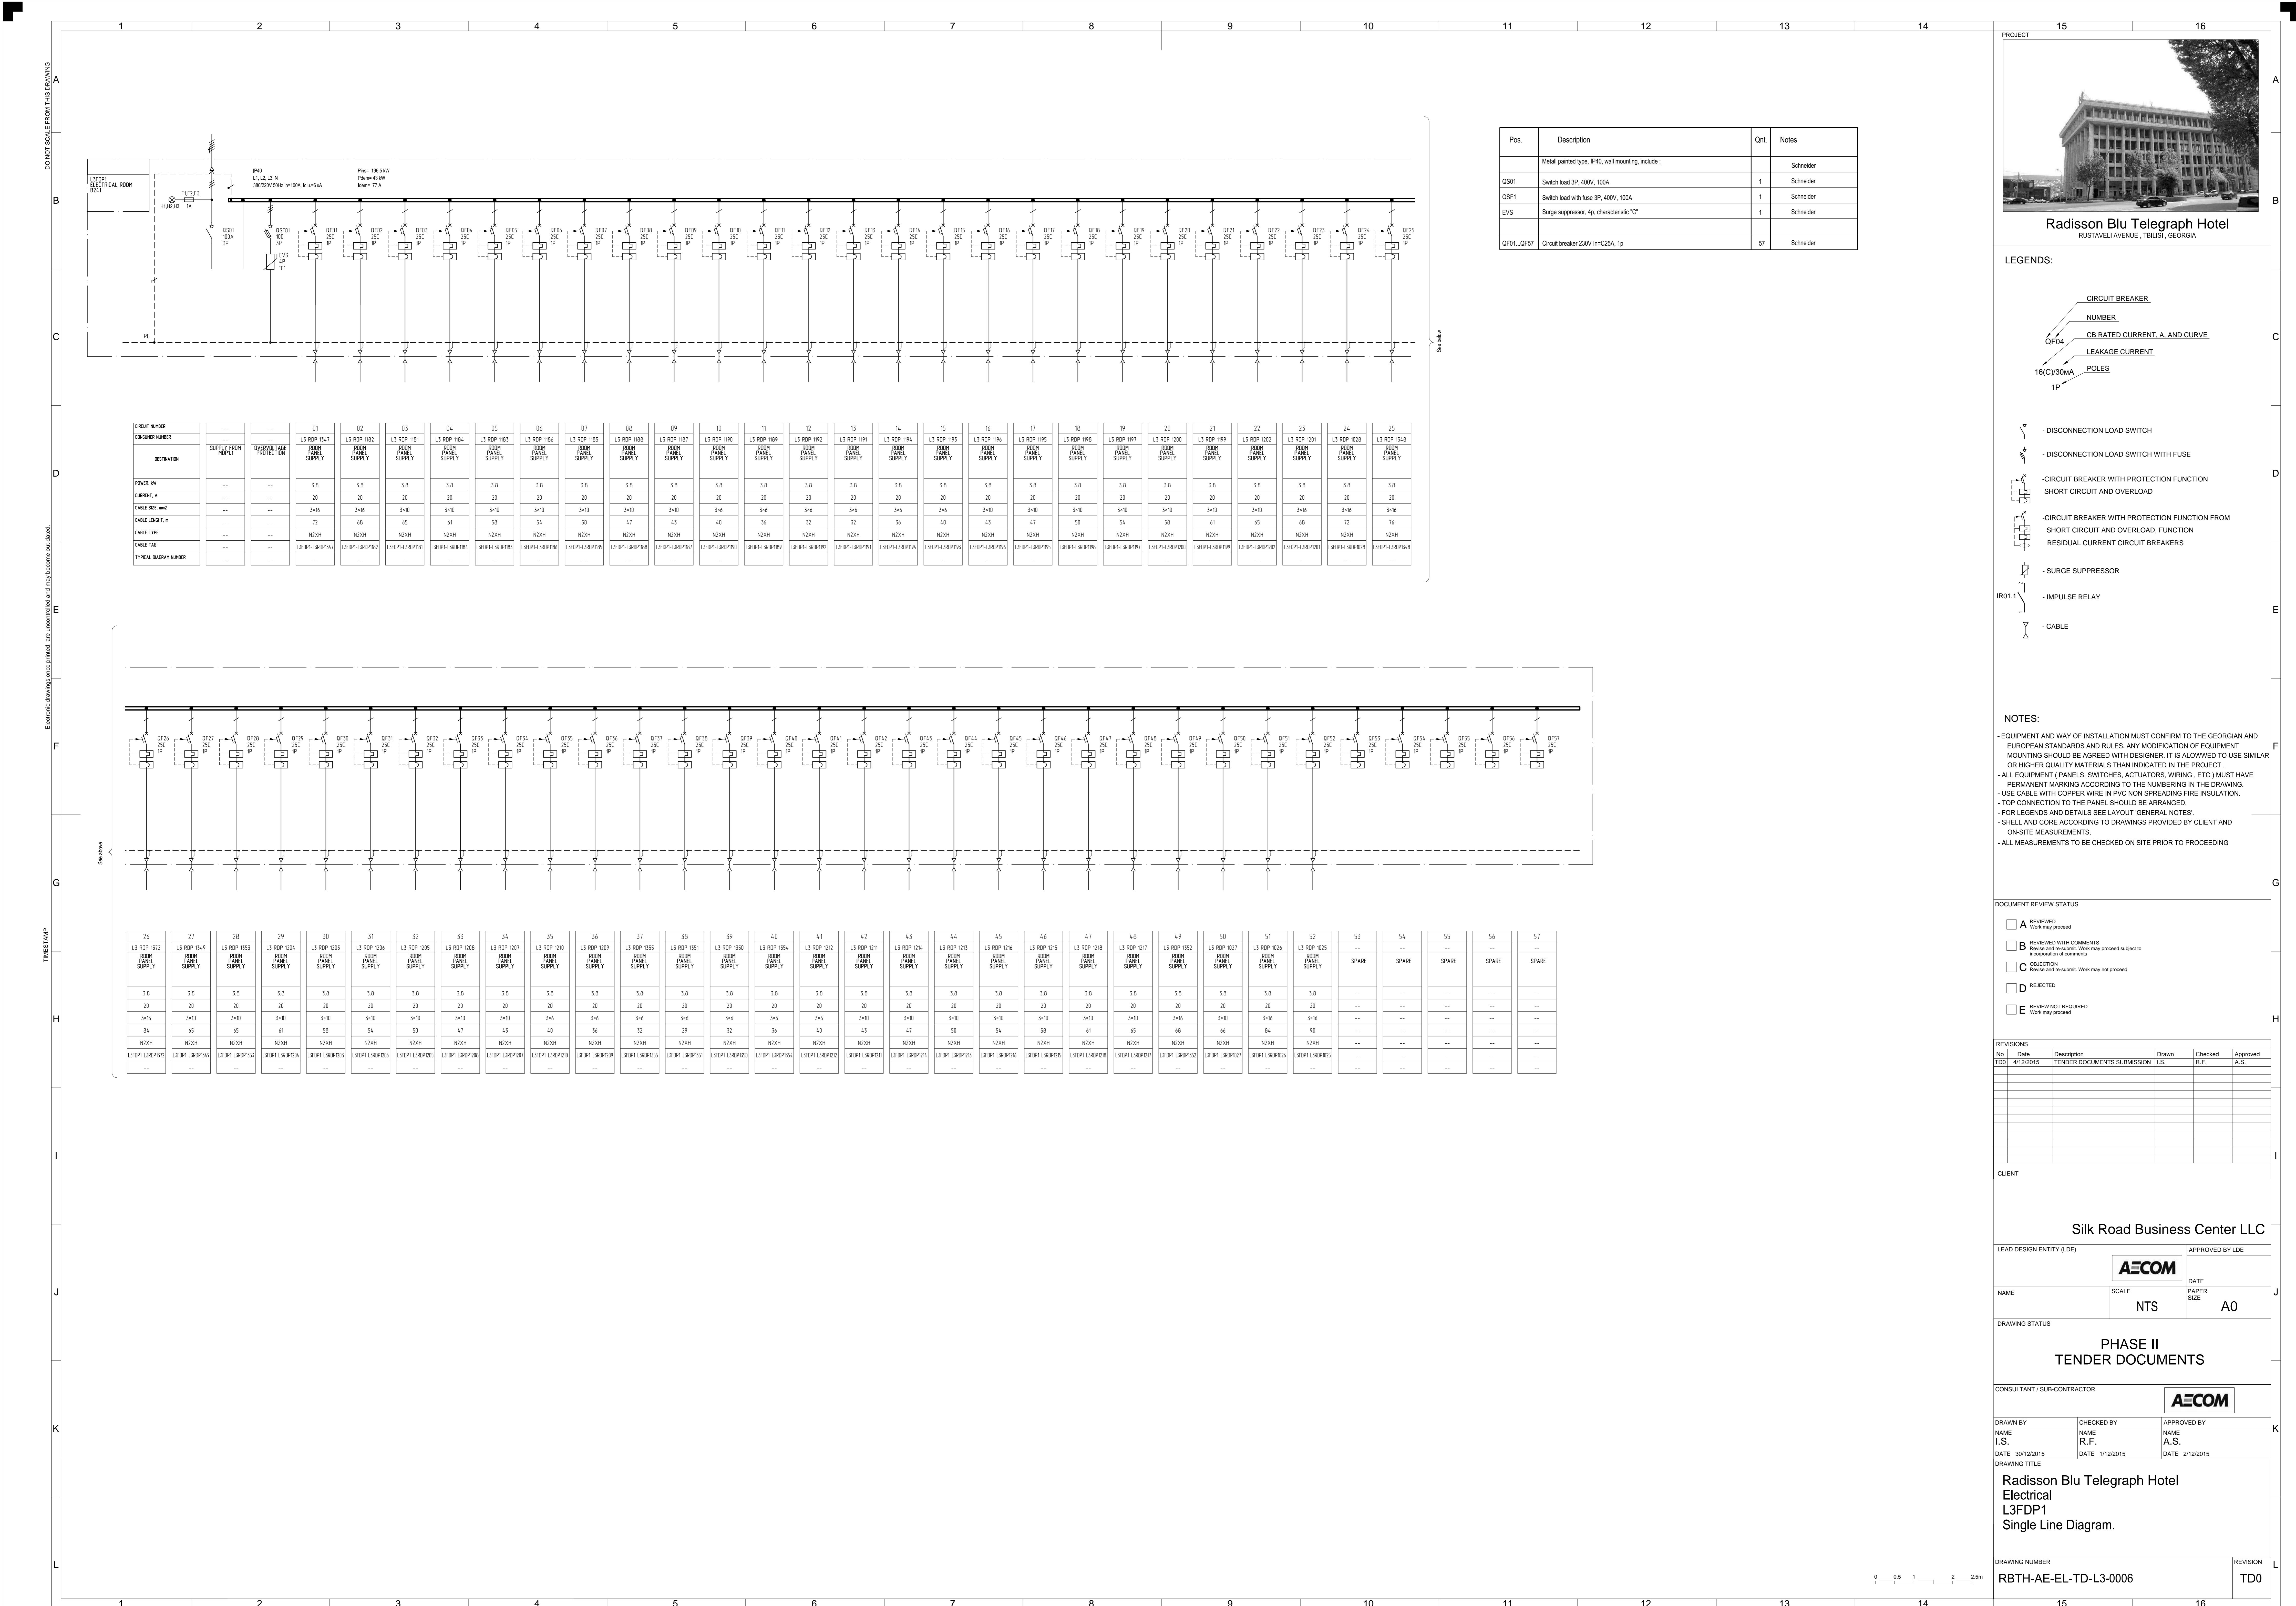

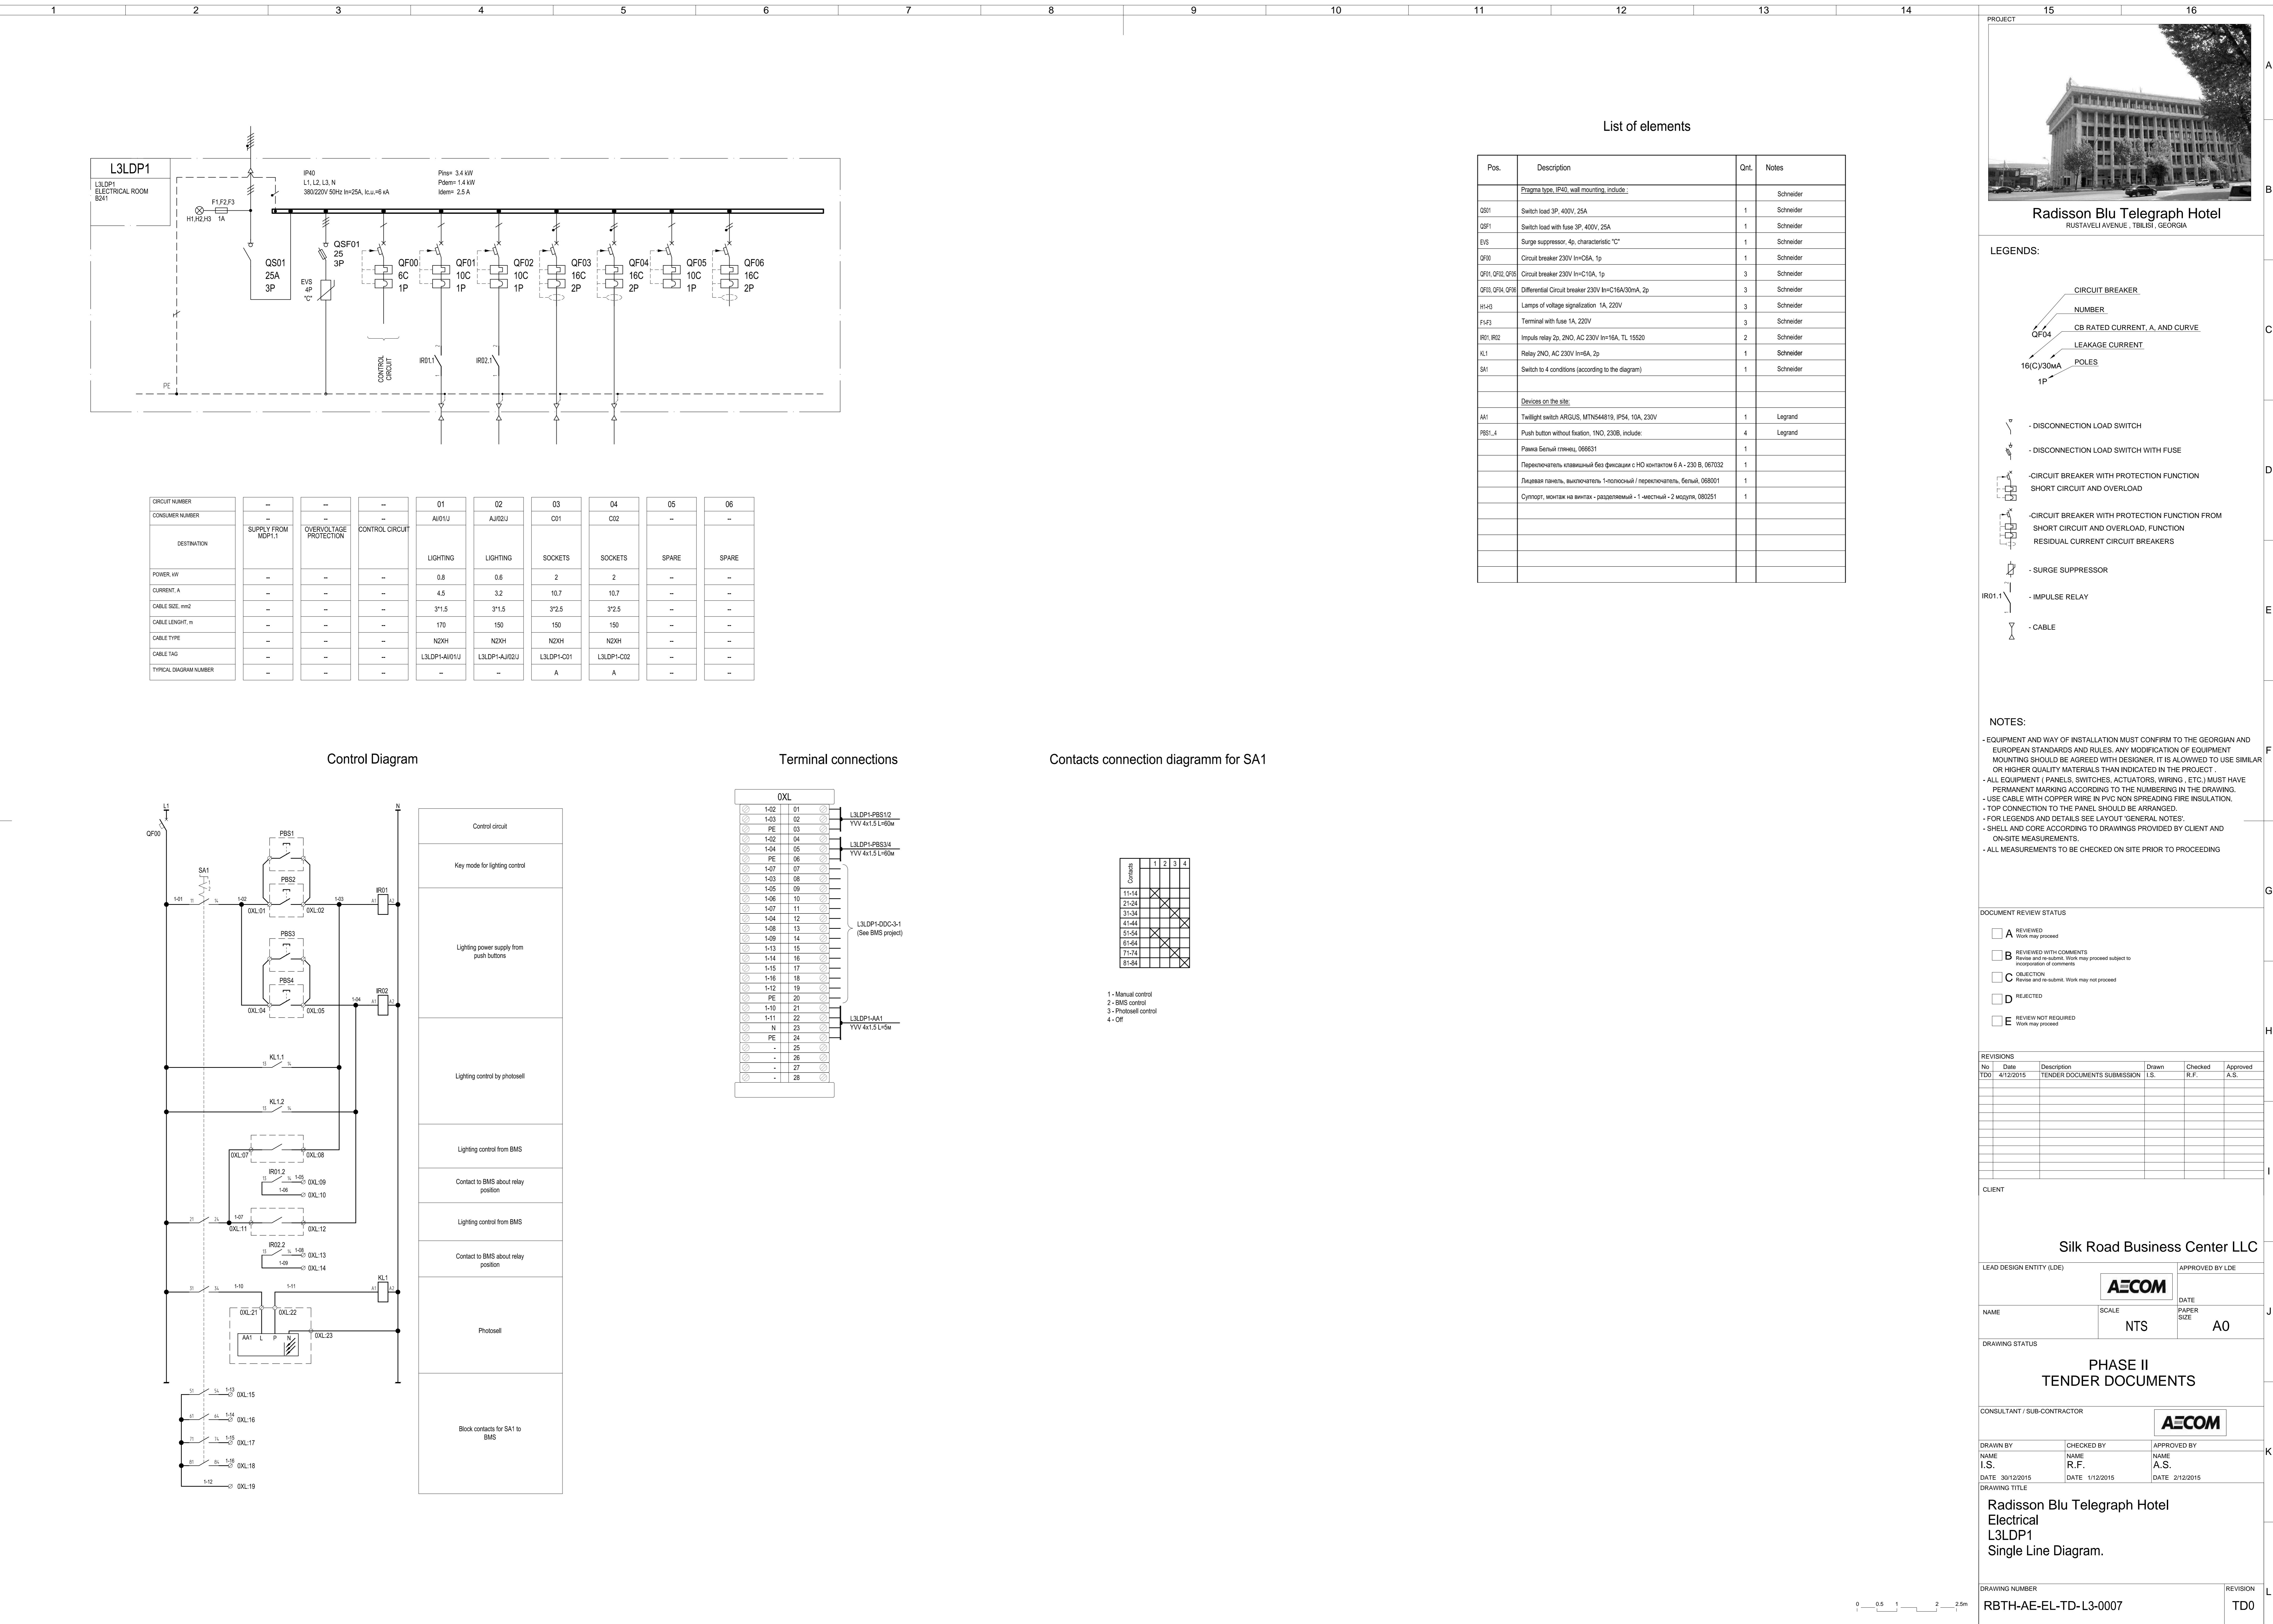

DO NOT SCALE FROM THIS DRAWING


Electronic drawings once printed, are understood and may become our cited.

TIMESTAMP

K

L


1 2 3 4 5 6 7 8 9 10 11 12 13 14 15 16

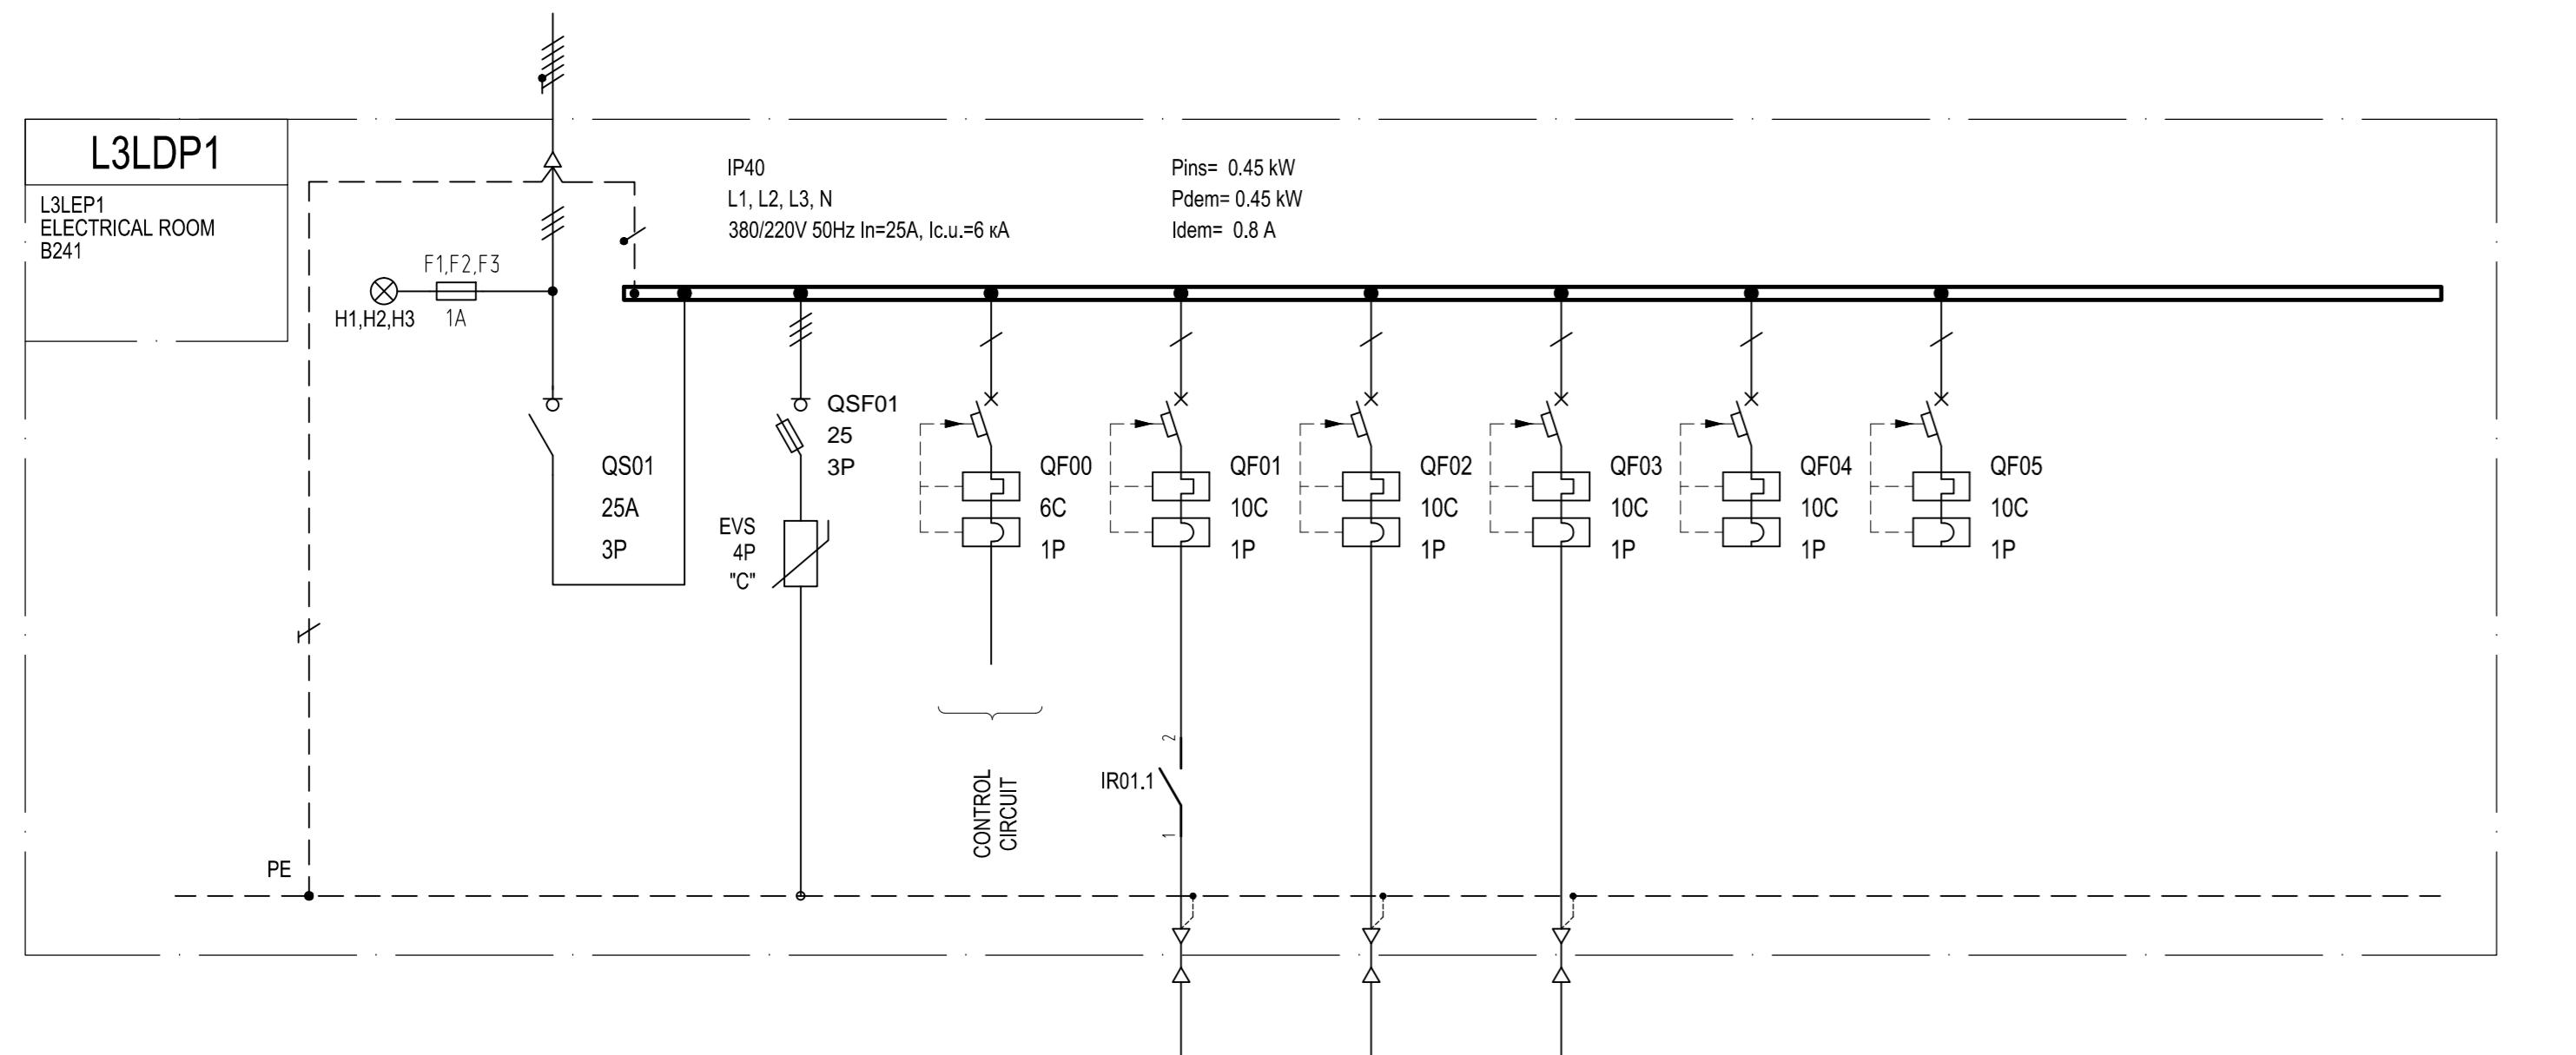

CIRCUIT NUMBER	CONSUMER NUMBER	—	—	—	—	—	01	02	03	—	05
POWER, kW	—	—	—	—	—	—	AJ01U-A	E02U-A	E03U-A	—	—
CURRENT, A	—	—	—	—	—	—	—	—	—	—	—
CABLE SIZE, mm <sup>2</sup>	—	—	—	—	—	—	0.15	0.15	0.15	—	—
CABLE LENGTH, m	—	—	—	—	—	—	0.8	0.8	0.8	—	—
CABLE TYPE	—	—	—	—	—	—	31.5	31.5	31.5	—	—
CABLE TAG	—	—	—	—	—	—	170	170	170	—	—
TYPICAL DIAGRAM NUMBER	—	—	—	—	—	—	N2XH.FE180	N2XH.FE180	N2XH.FE180	—	—
	—	—	—	—	—	—	L3LEP1-AJ01U-A	L3LEP1-E02U-A	L3LEP1-E03U-A	—	—

## List of elements

Pos.	Description	Qnt.	Notes
	Prags type IP40, wall mounting, include:		Schneider
QS01	Switch load 3P, 400V, 25A	1	Schneider
QSF1	Switch load with fuse 3P, 400V, 25A	1	Schneider
EV5	Surge suppressor, 4p, characteristic "C"	1	Schneider
QF00	Circuit breaker 230V In=6A, 1p	1	Schneider
QF01...QF05	Circuit breaker 230V In=10A, 1p	5	Schneider
H1-H3	Lamps of voltage signalization 1A, 220V	3	Schneider
F1-F3	Impulse relay 2p, 2NO, AC 230V In=6A, TL 15520	3	Schneider
IR01	Relay 2NO, AC 230V In=6A, 2p	1	Schneider
SA1	Switch to 4 conditions (according to the diagram)	1	Schneider
	Devices on the site:		
AA1	Twilight switch ARGUS, MTN544819, IP54, 10A, 230V	1	Legrand
PBS1..3	Push button without fixation, INO, 230V, include:	3	Legrand
	Рамка Белый глянец, 066631	1	
	Переключатель клавишный без фиксации с НО контактом 6 A - 230 V, 067032	1	
	Лицевая панель, выключатель 1-полюсный / переключатель, белый, 069001	1	
	Сумпрат, монтаж на винтах - разделительный - 1-местный - 2 модуля, 080251	1	

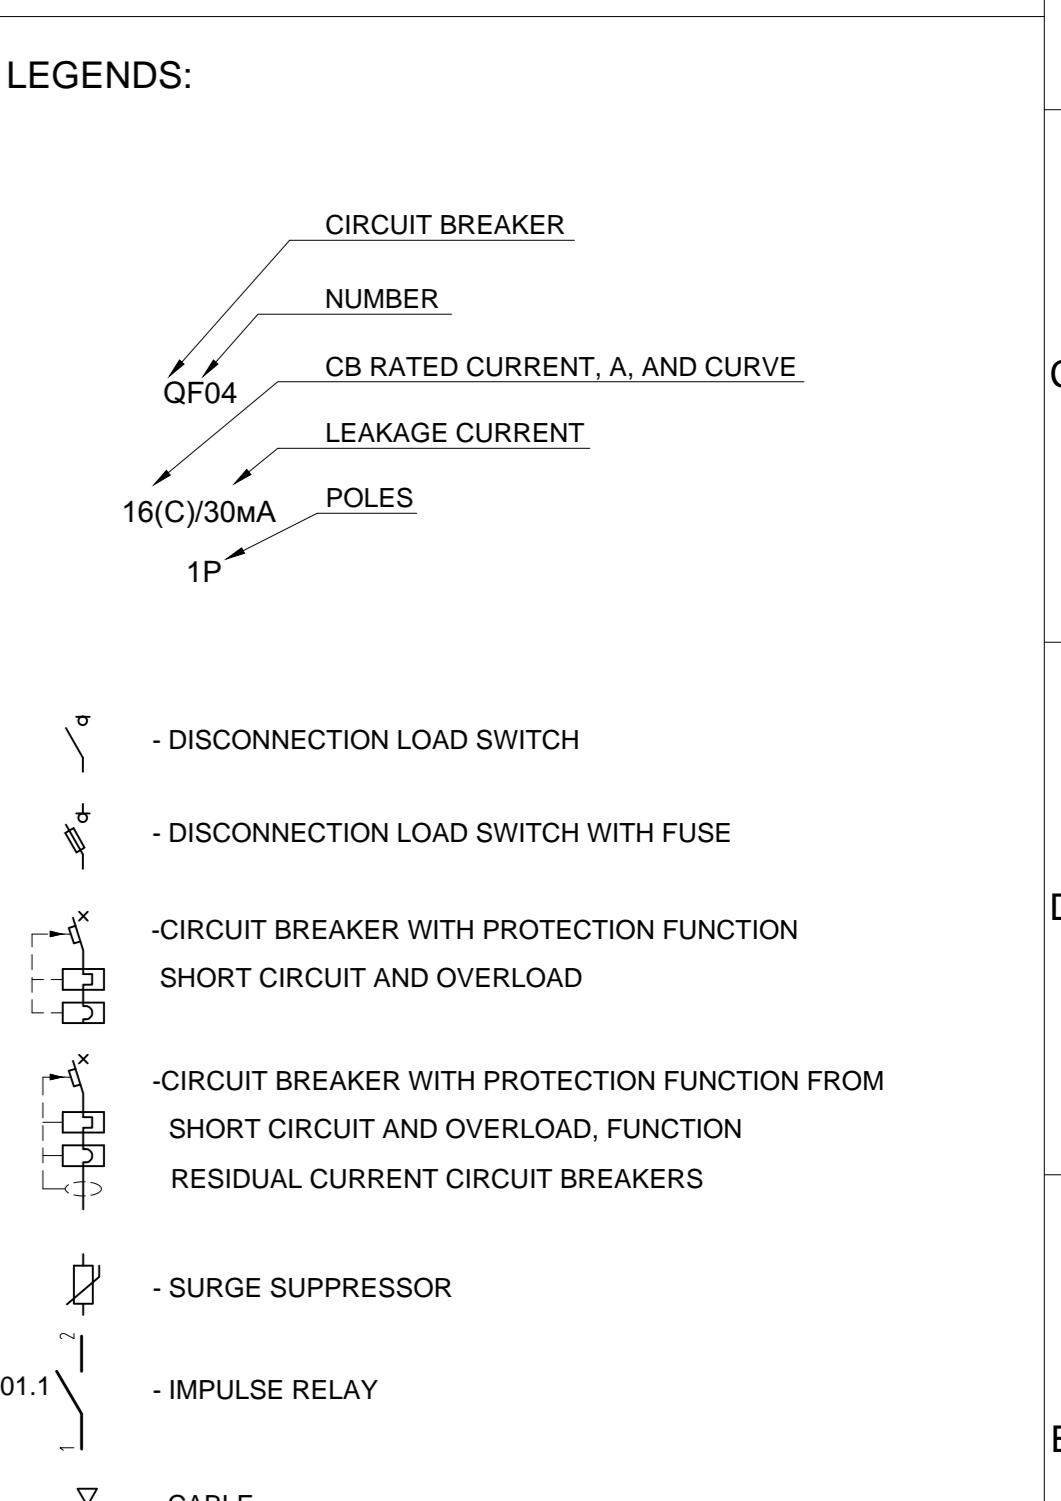

NOTES:

- EQUIPMENT AND WAY OF INSTALLATION MUST CONFIRM TO THE GEORGIAN AND EUROPEAN STANDARDS AND RULES. ANY MODIFICATION OF EQUIPMENT MOUNTING SHOULD BE AGREED WITH DESIGNER. IT IS ALLOWED TO USE SIMILAR OR HIGHER QUALITY MATERIALS THAN INDICATED IN THE PROJECT.
- ALL EQUIPMENT (PANELS, SWITCHES, ACTUATORS, WIRING, ETC.) MUST HAVE TOP CONNECTION TO THE PANEL.
- USE CABLE WITH COPPER WIRE IN PVC NON SPREADING FIRE INSULATION.
- TOP CONNECTION TO THE PANEL SHOULD BE ARRANGED.
- FOR LEGENDS AND DETAILS SEE LAYOUT/GENERAL NOTES.
- SHELL AND CORE ACCORDING TO DRAWINGS PROVIDED BY CLIENT AND ON-SITE MEASUREMENTS.
- ALL MEASUREMENTS TO BE CHECKED ON SITE PRIOR TO PROCEEDING

DOCUMENT REVIEW STATUS	
<input type="checkbox"/> A	REVIEWED Work may proceed
<input type="checkbox"/> B	REVIEWED WITH COMMENTS Revise and re-submit. Work may proceed subject to comments
<input type="checkbox"/> C	OBLIGATION Revise and re-submit. Work may not proceed
<input type="checkbox"/> D	REJECTED
<input type="checkbox"/> E	REVIEW NOT REQUIRED Work may proceed

REVIEWS		Date	Description	Drawn	Checked	Approved
No	Date		TENDER DOCUMENTS SUBMISSION	I.S.	R.F.	A.S.
T00	4/12/2015					

CLIENT

Silk Road Business Center LLC

LEAD DESIGN ENTITY (LDE) APPROVED BY LDE

AECOM DATE

NAME SCALE PAPER SIZE

NTS A0

DRAWING STATUS

PHASE II TENDER DOCUMENTS

CONSULTANT / SUB-CONTRACTOR

AECOM

DRAWN BY CHECKED BY APPROVED BY

NAME NAME NAME

I.S. R.F. A.S.

DATE 30/12/2015 DATE 1/12/2015 DATE 2/12/2015

DRAWING TITLE


Radisson Blu Telegraph Hotel  
Electrical  
L3LEP1  
Single Line Diagram.


DRAWING NUMBER

RBTH-AE-EL-TD-L3-0008

REVISION

T00

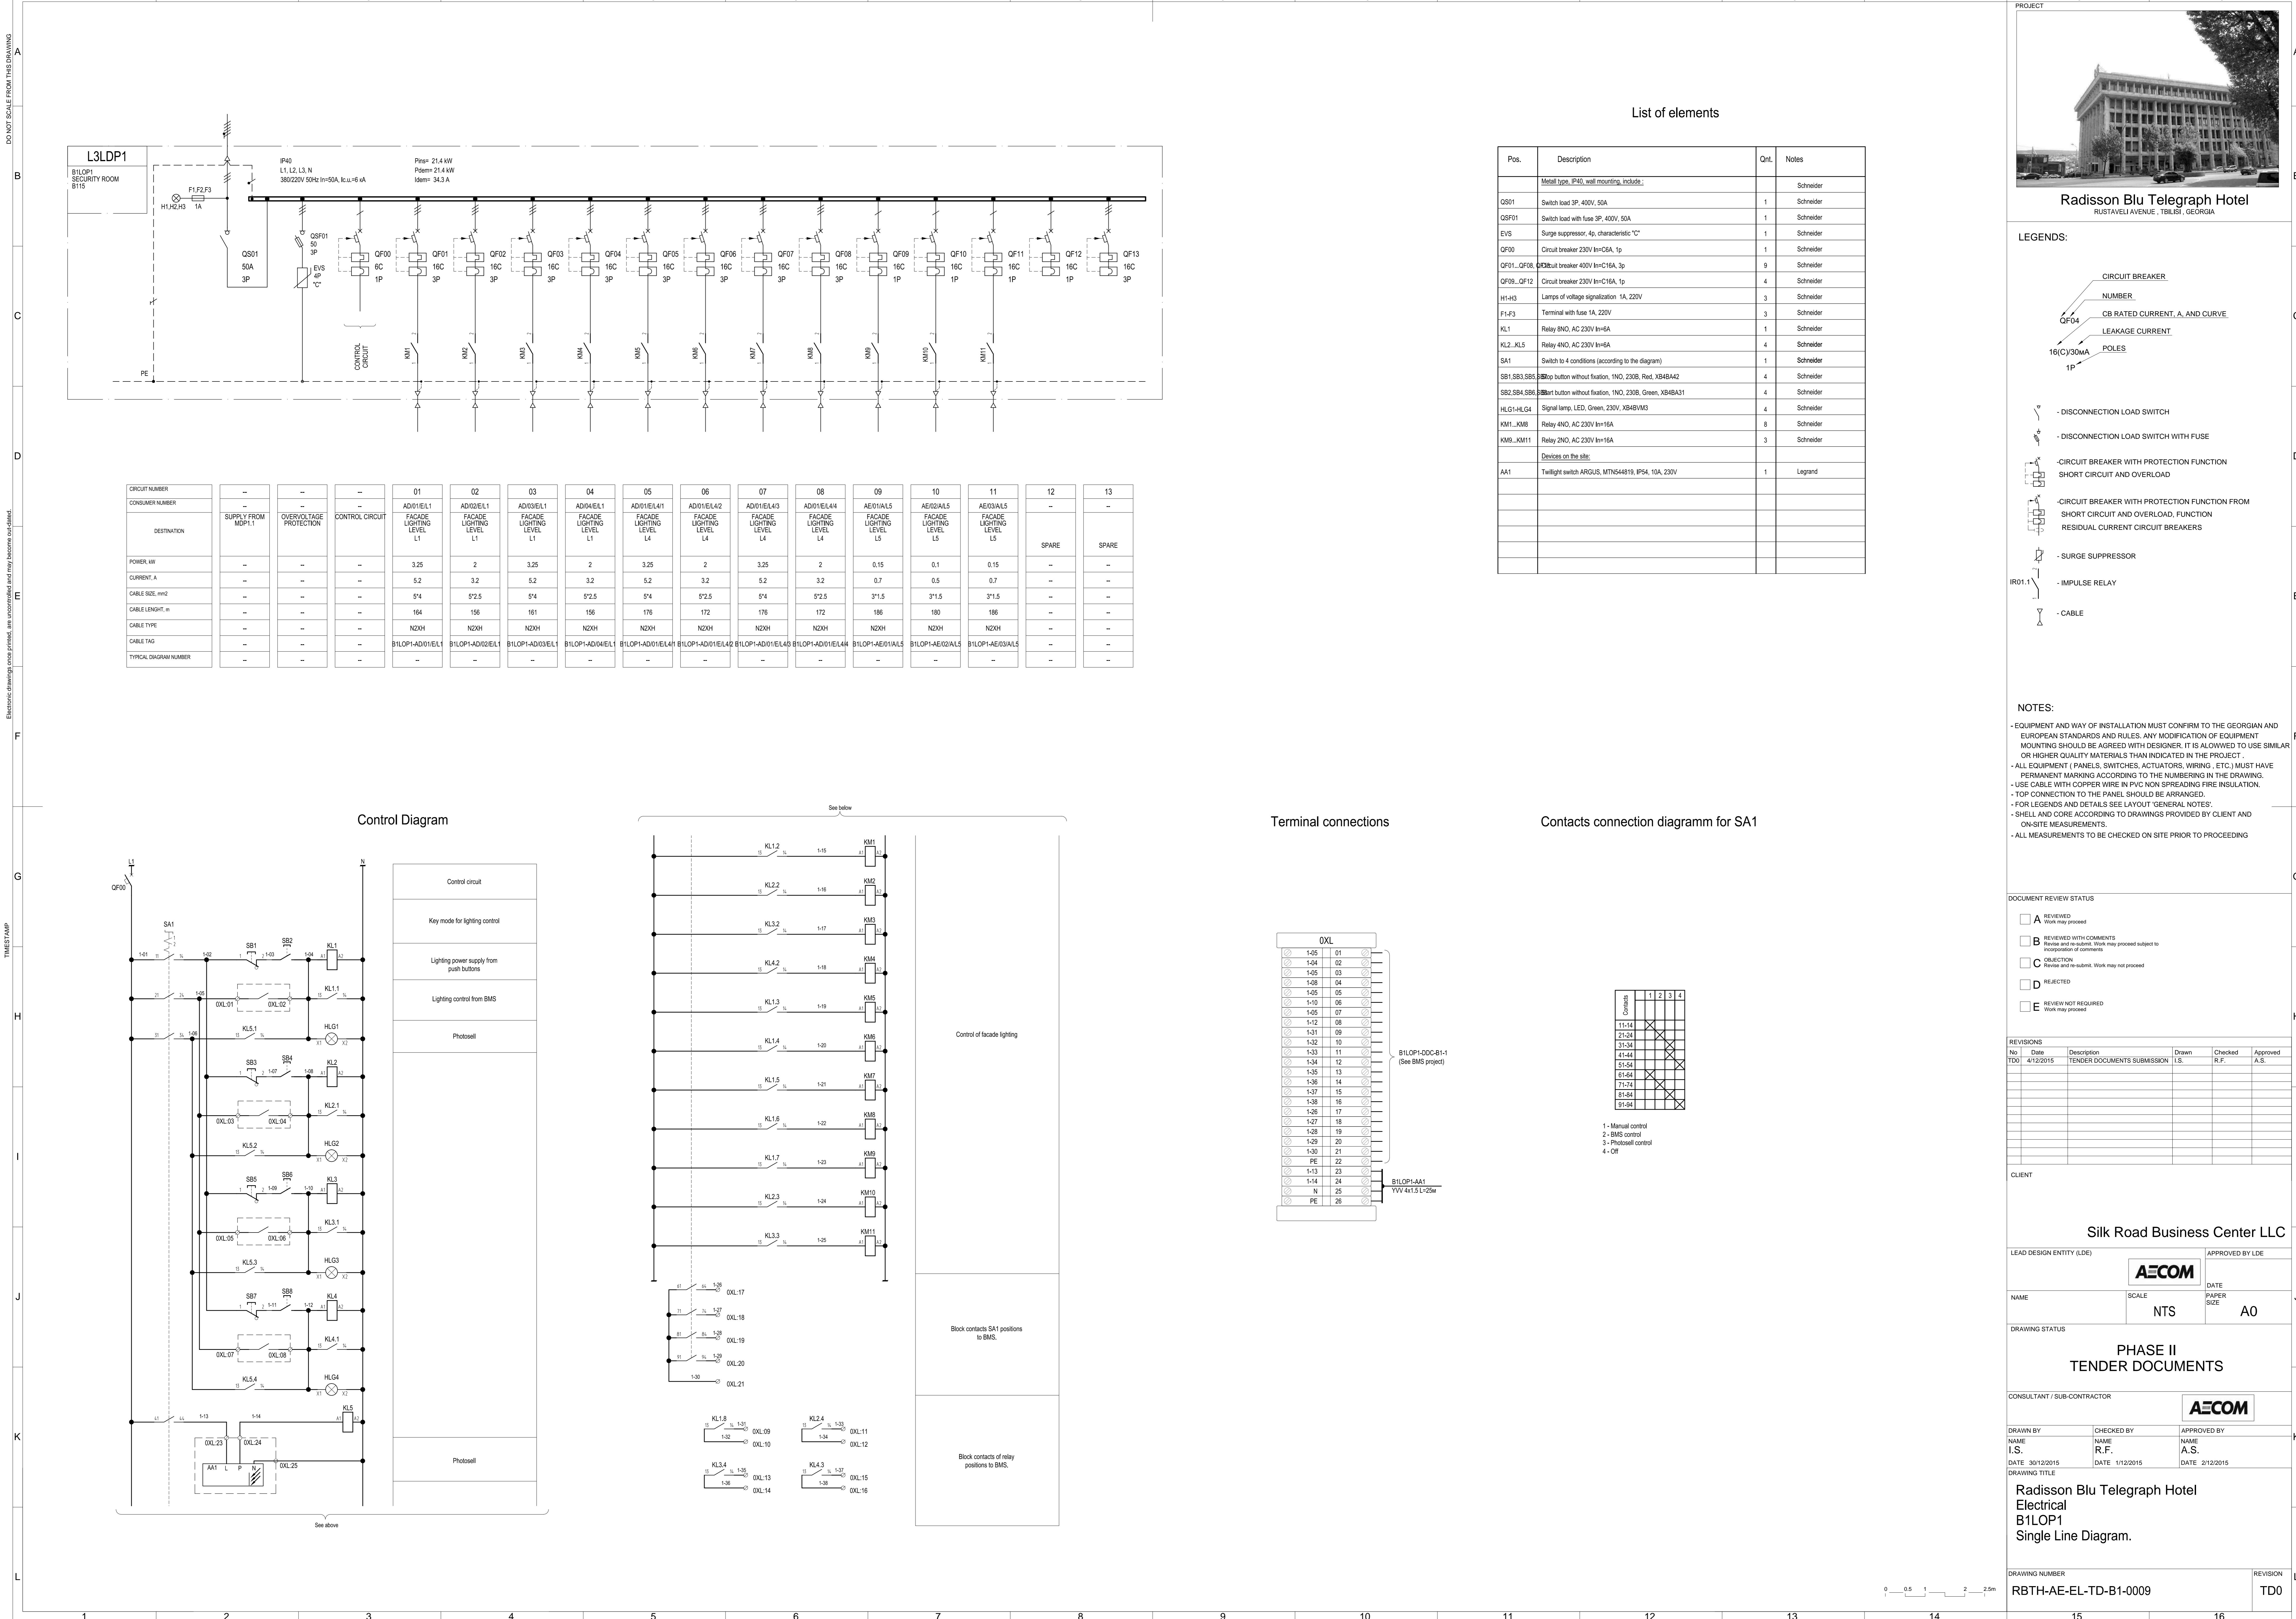

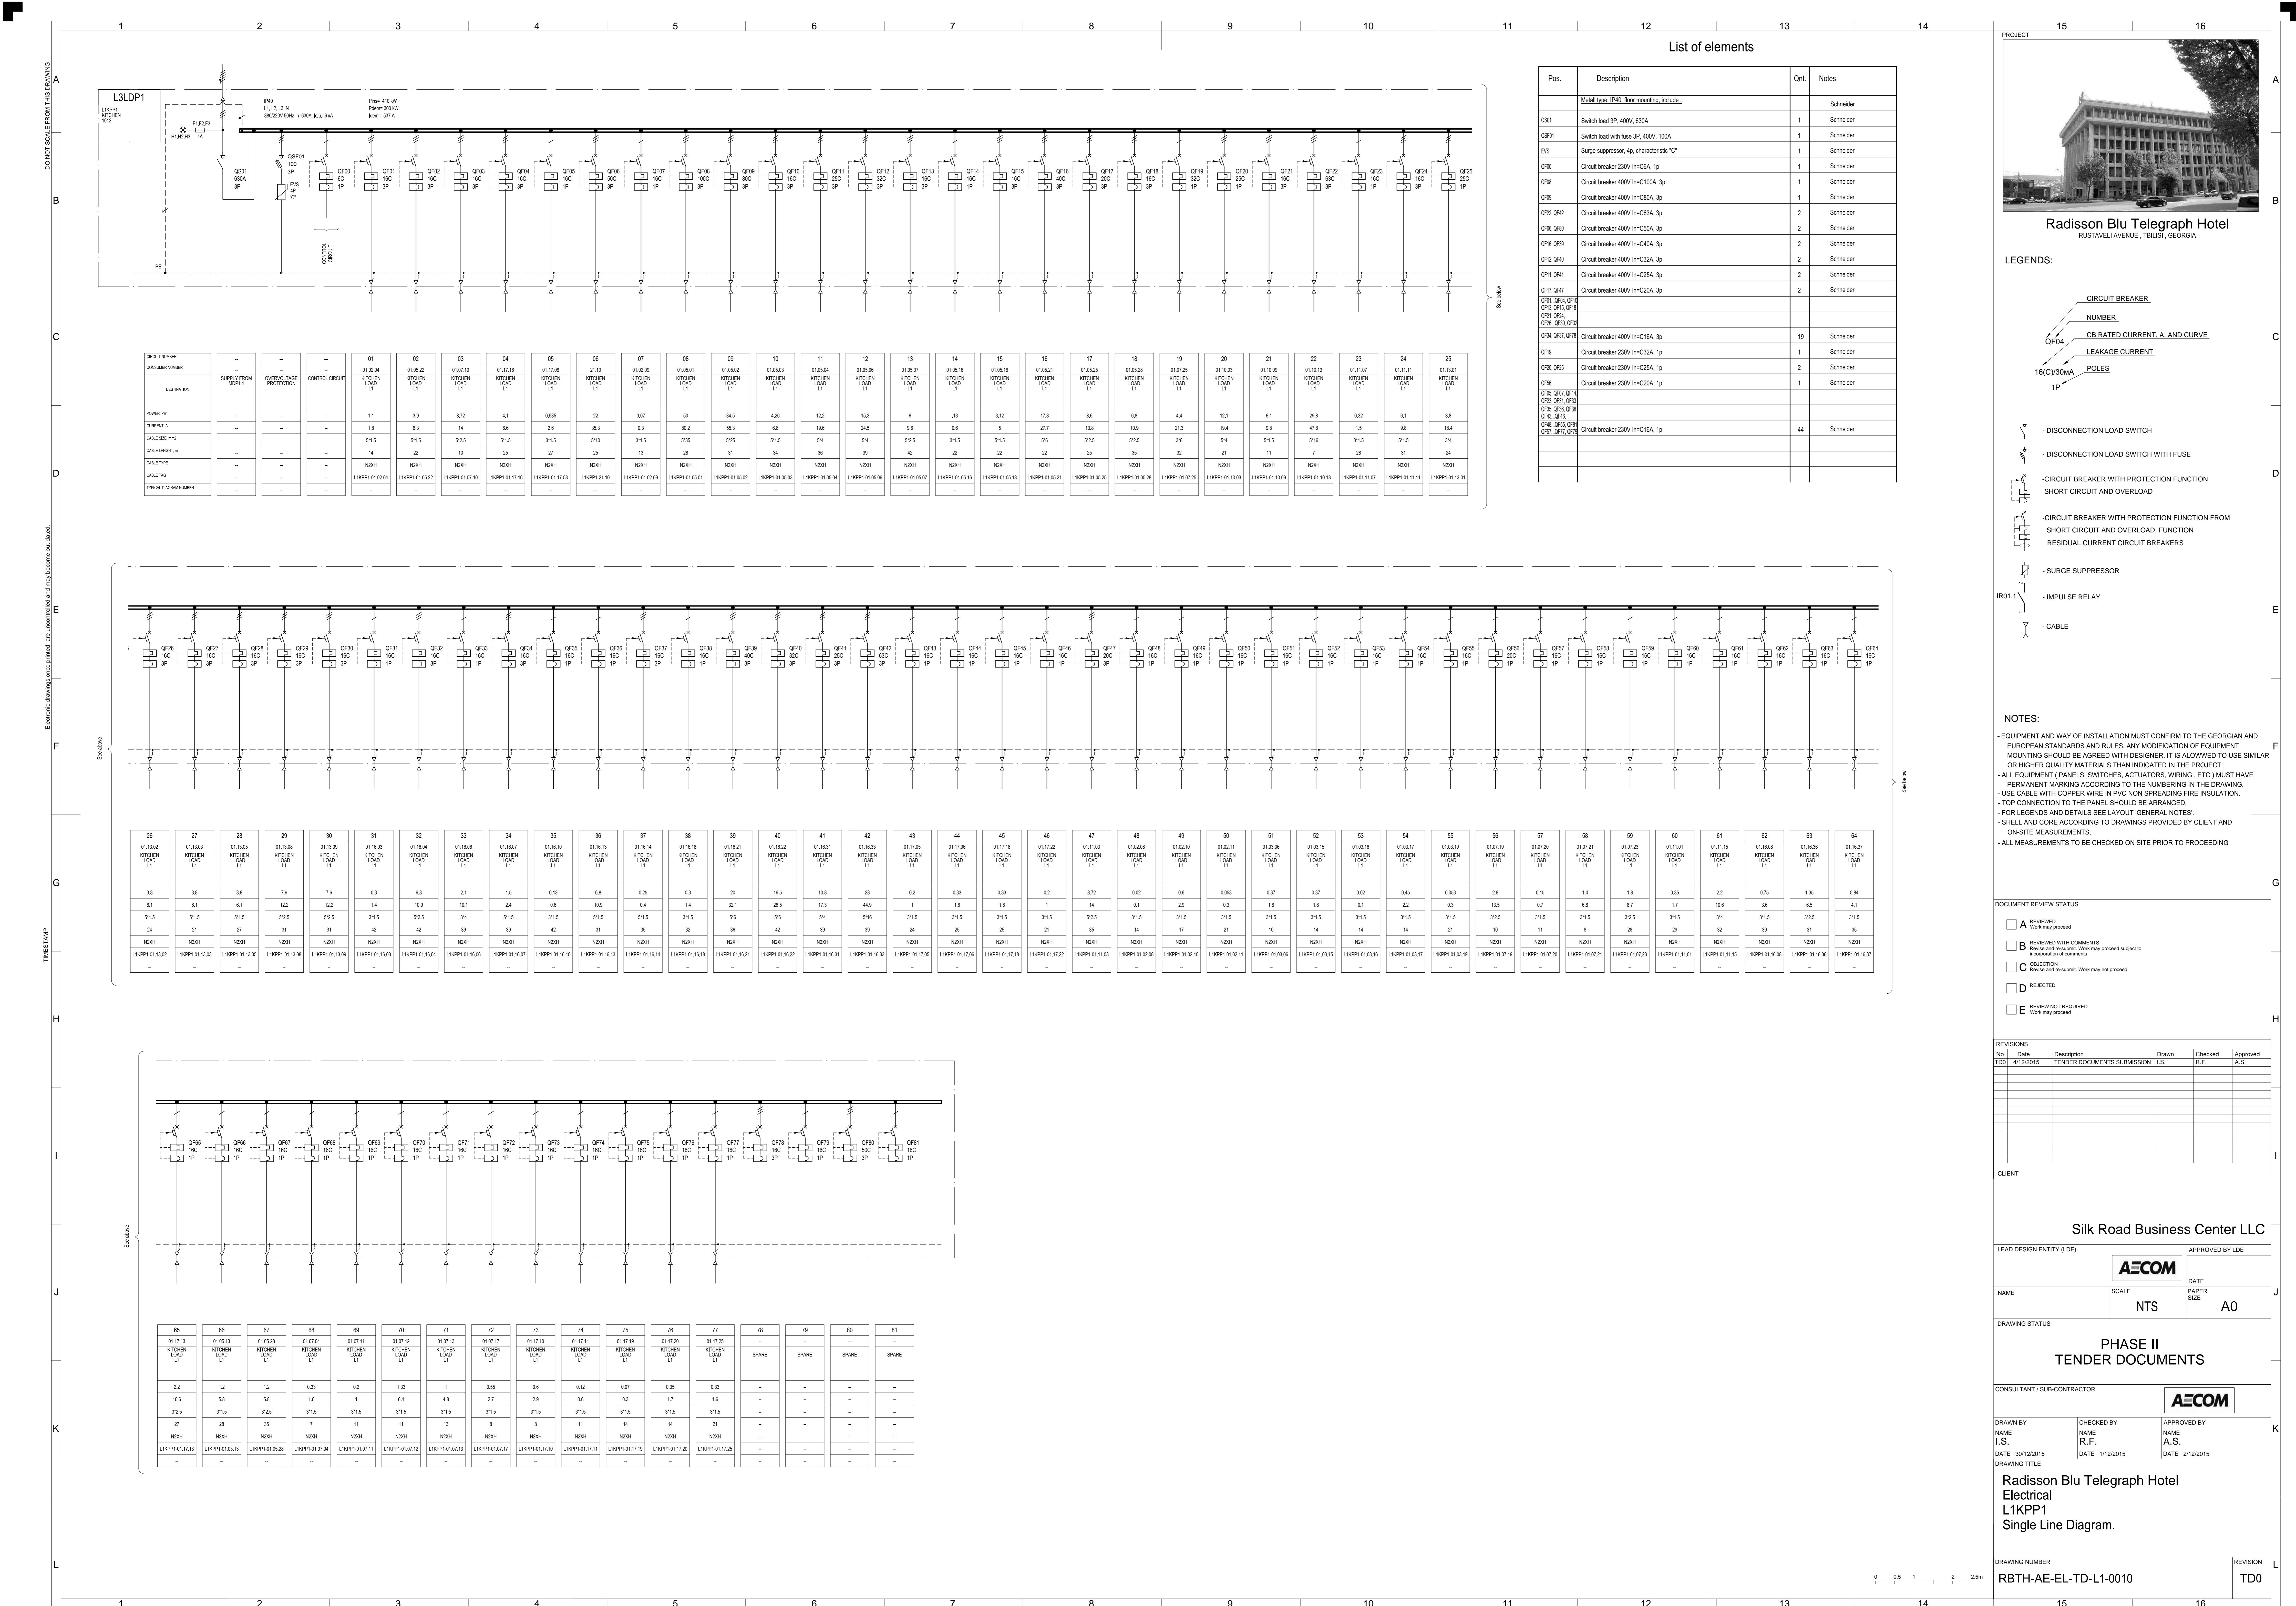

DO NOT SCALE FROM THIS DRAWING

B

D

F

E

D

G

H


A


J



K

L

1

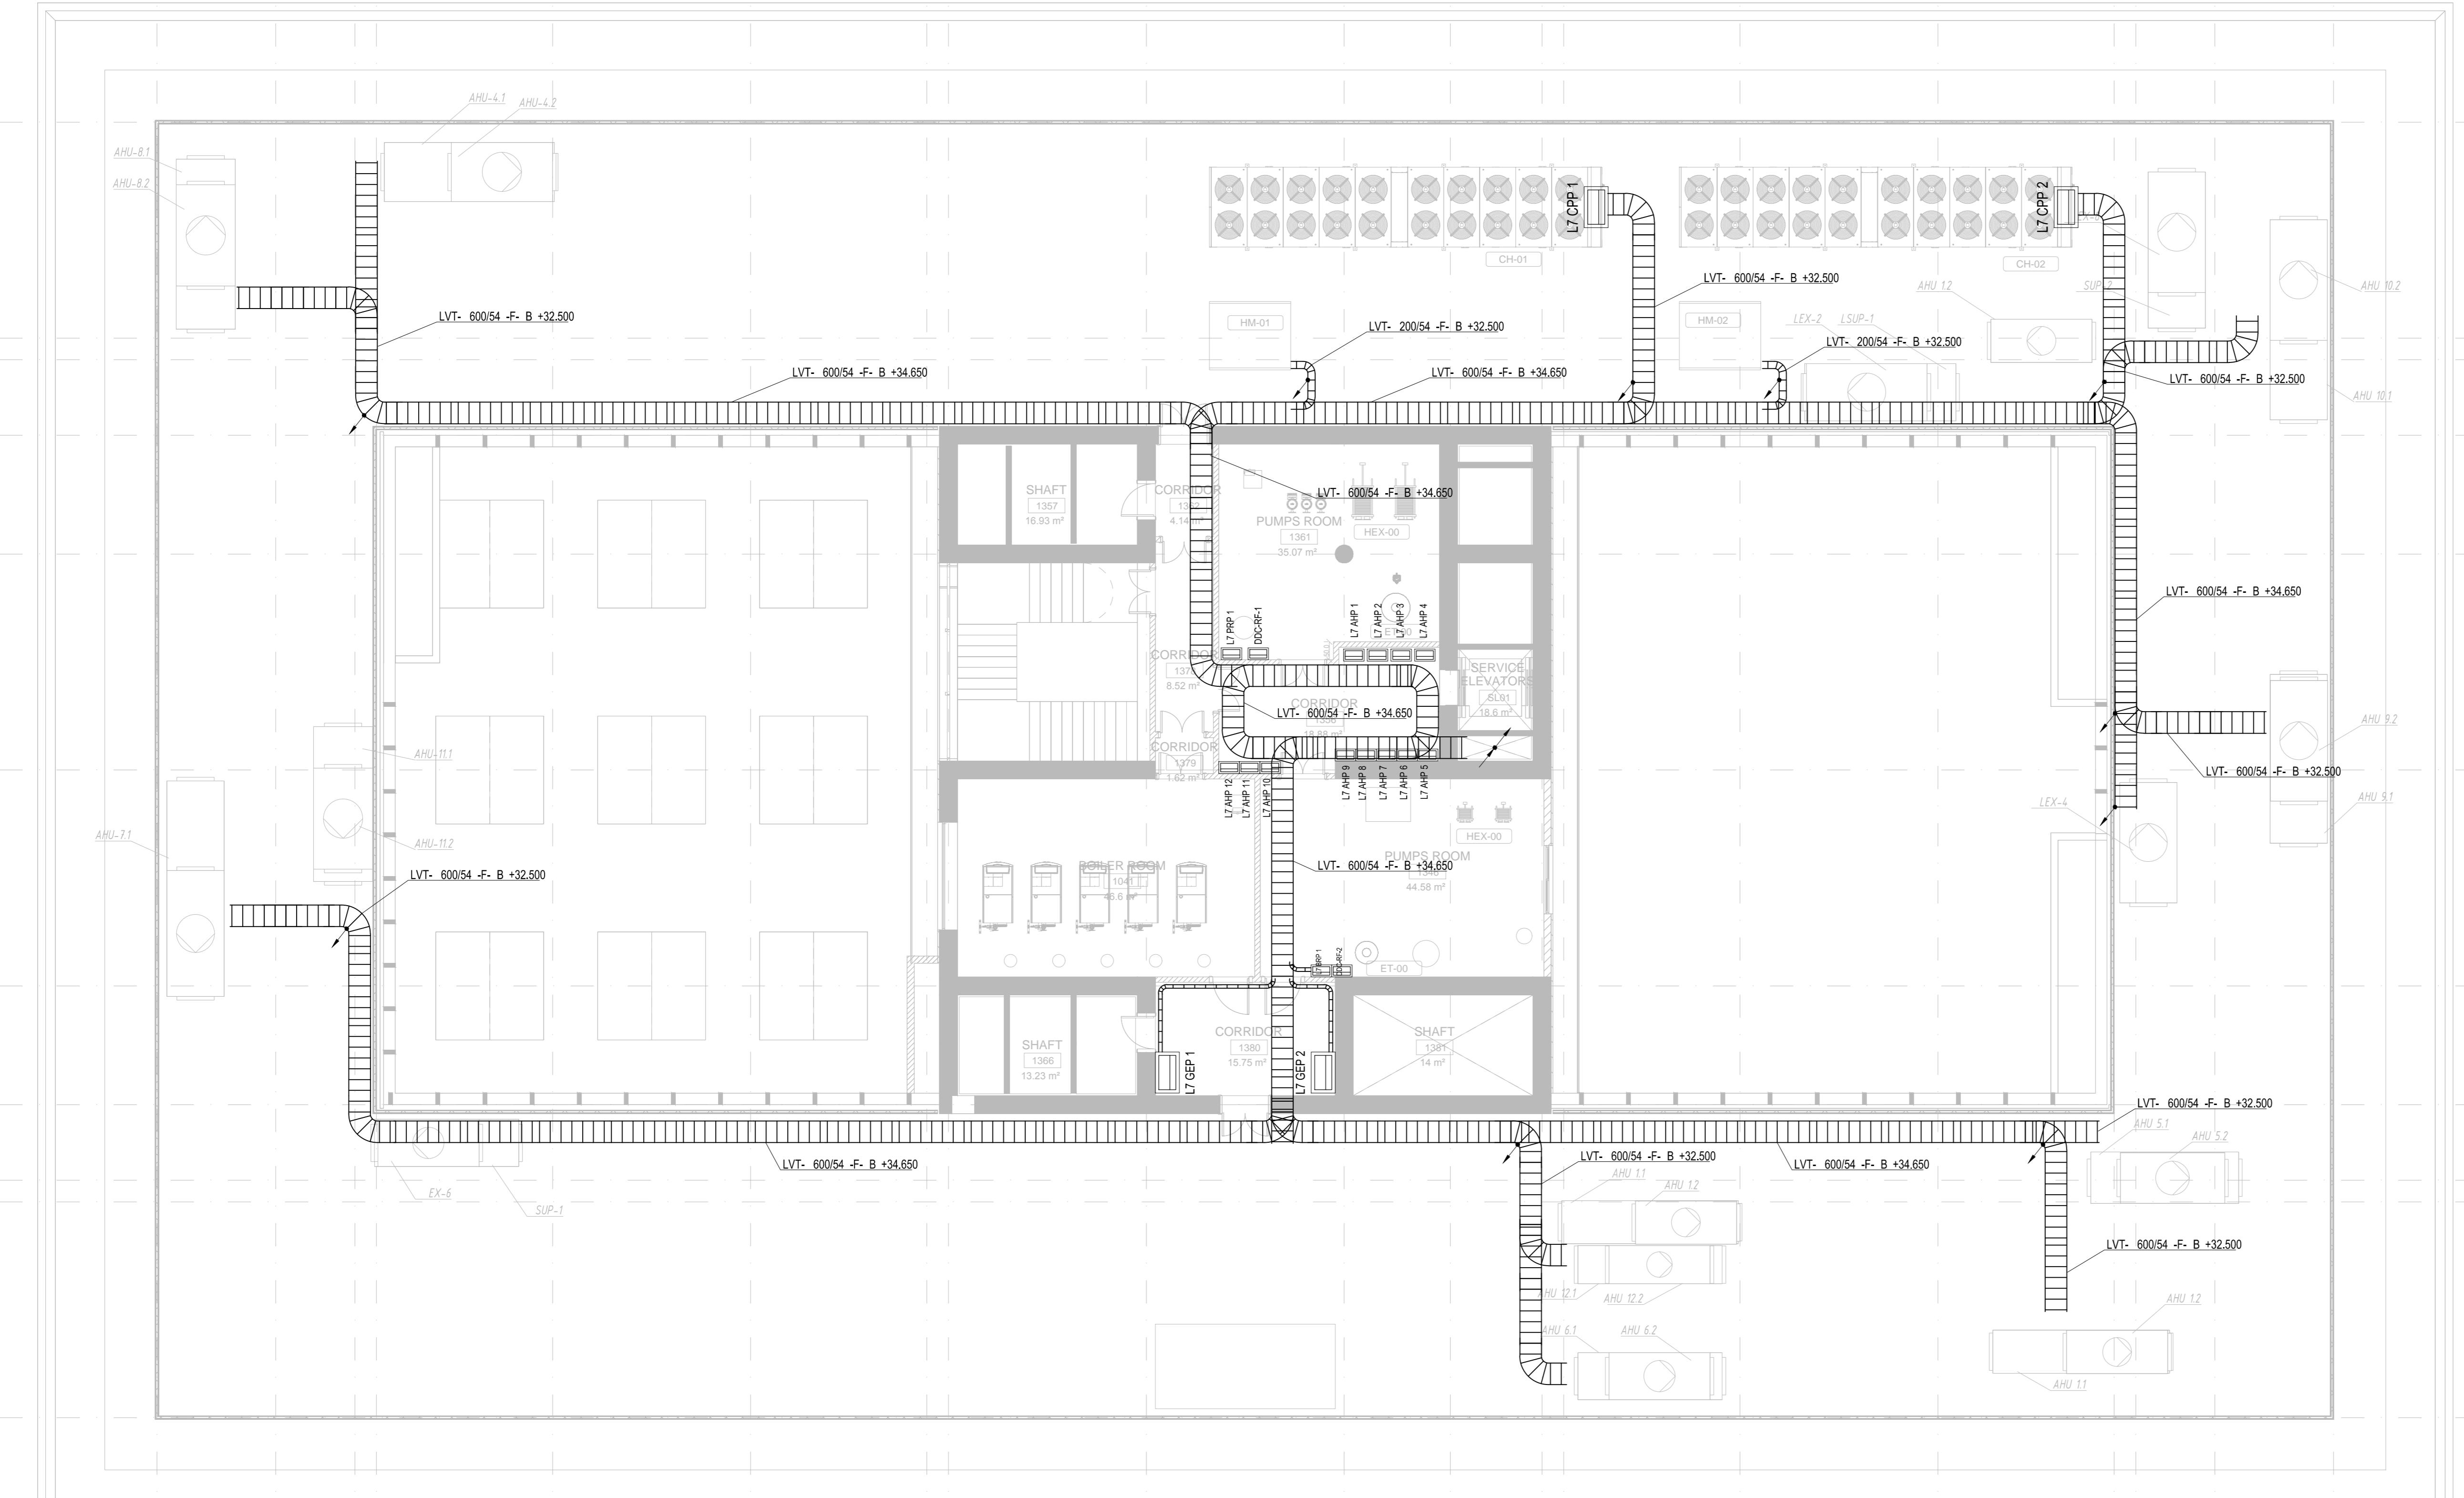

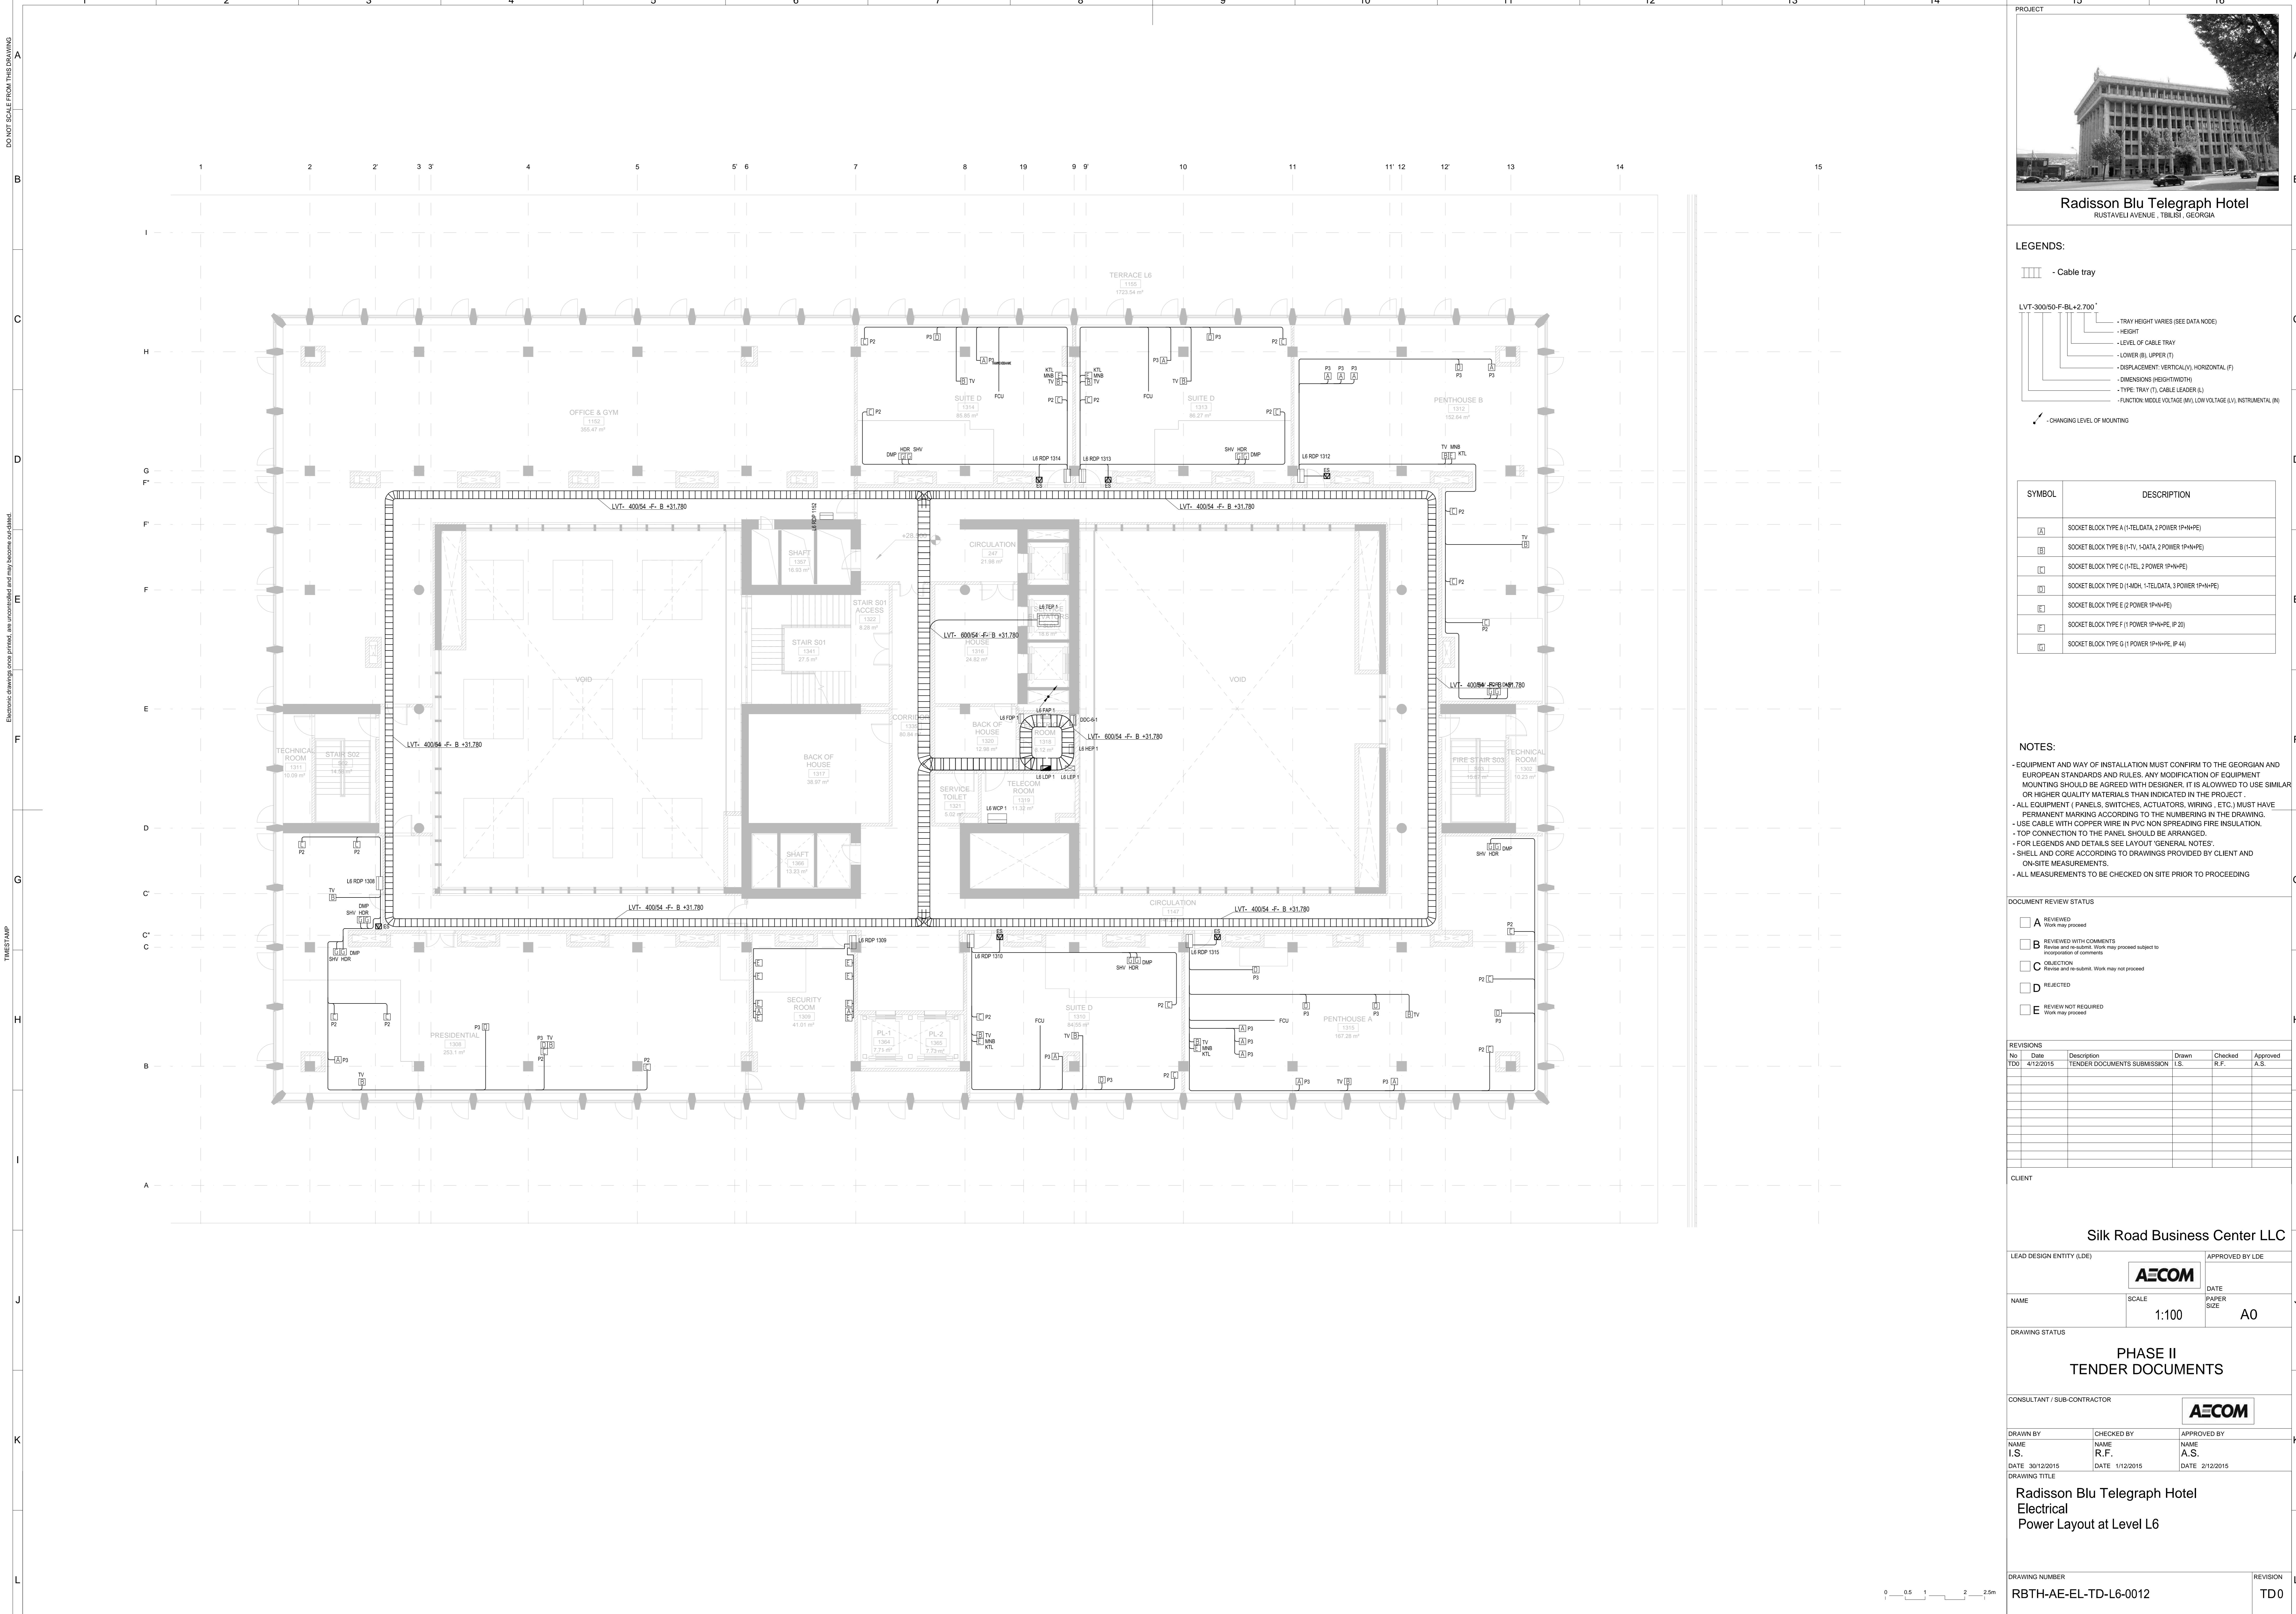

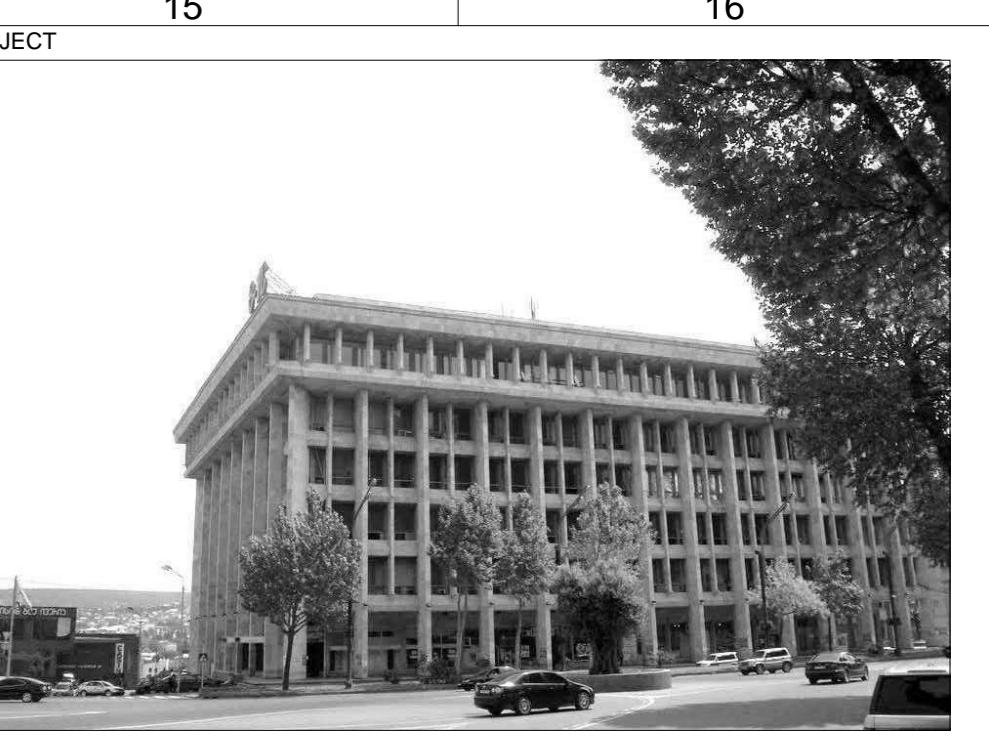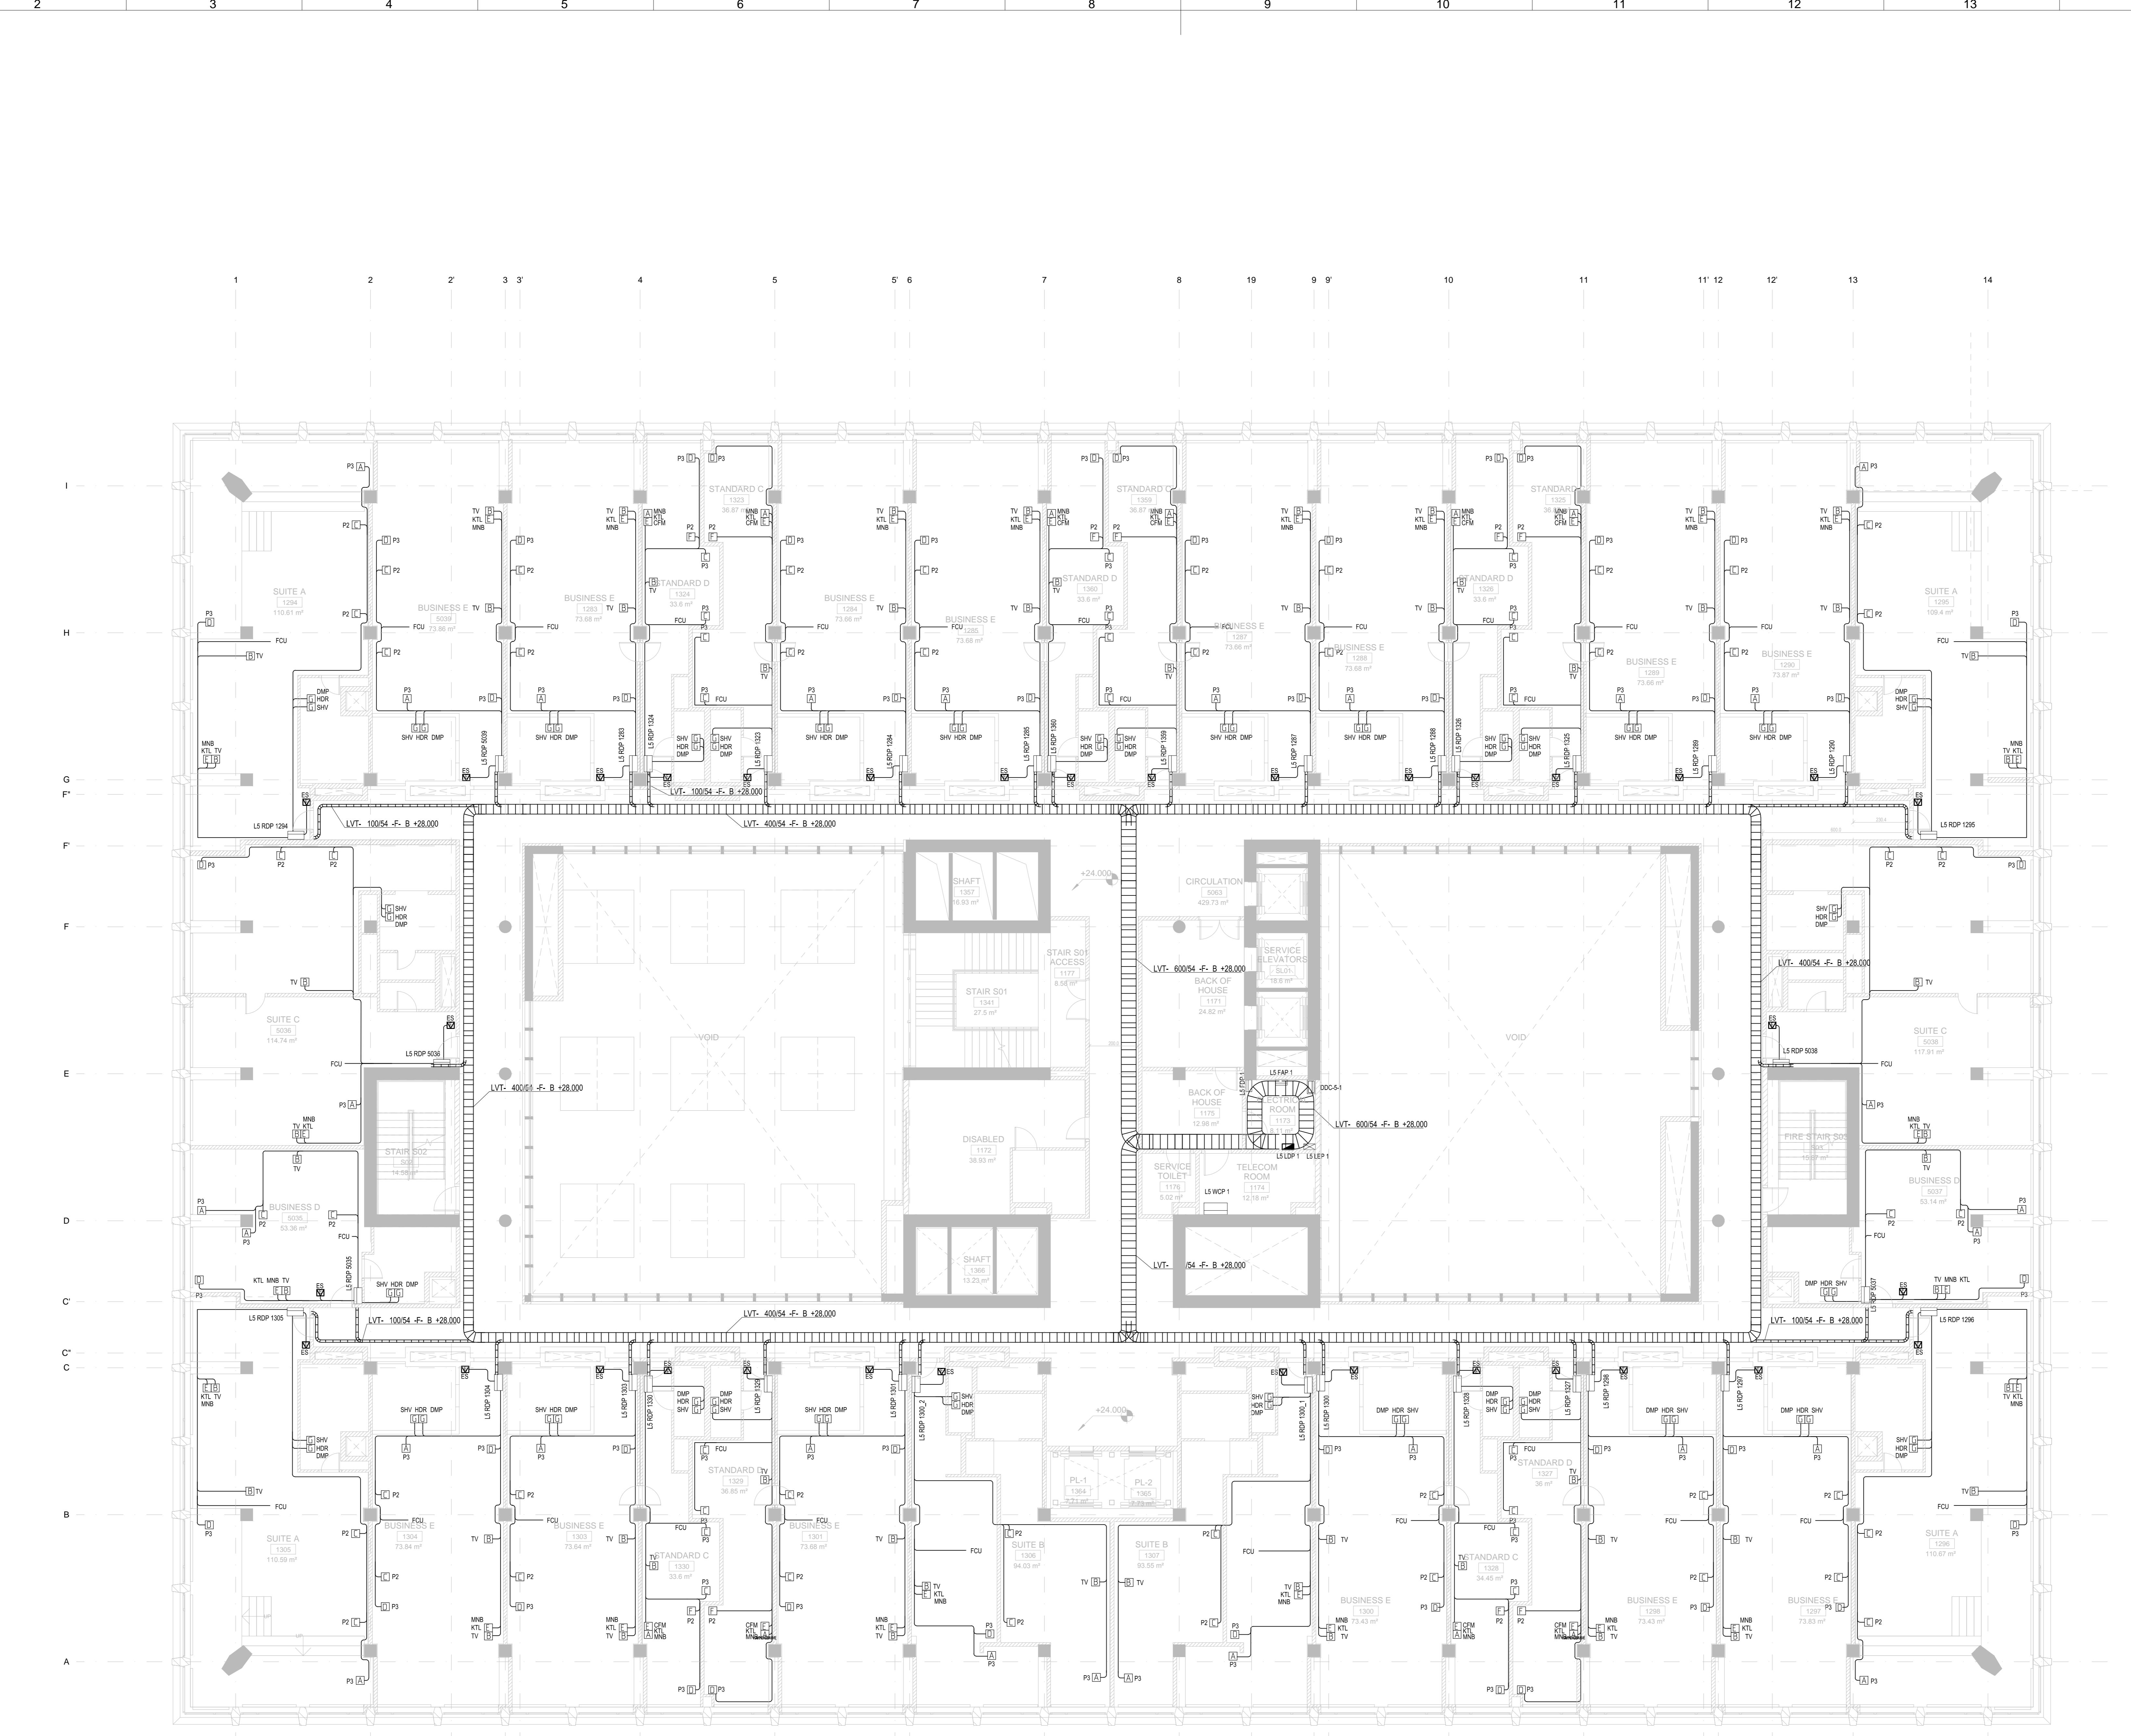

**Radisson Blu Telegraph Hotel**  
RUSTAVELI AVENUE, TBILISI, GEORGIA

**LEGENDS:**

- Cable tray
- LVT-300/50-F-BL+2.700<sup>\*</sup>
  - TRAY HEIGHT VARIES (SEE DATA NODE)
  - HEIGHT
  - LOWER (B), UPPER (T)
  - DISPLACEMENT VERTICAL(V), HORIZONTAL (H)
  - DIMENSIONS (HEIGHT/WIDTH)
  - TYPE: TRAY (T), CABLE LEADER (L)
  - FUNCTION: MIDDLE VOLTAGE (MV), LOW VOLTAGE (LV), INSTRUMENTAL (IN)
- CHANGING LEVEL OF MOUNTING

SYMBOL	DESCRIPTION
A	SOCKET BLOCK TYPE A (1-TEL/DATA, 2 POWER IP-NP-E)
B	SOCKET BLOCK TYPE B (1-TV, 1-DATA, 2 POWER IP-NP-E)
C	SOCKET BLOCK TYPE C (1-TEL, 2 POWER IP-NP-E)
D	SOCKET BLOCK TYPE D (1-MOH, 1-TEL/DATA, 2 POWER IP-NP-E)
E	SOCKET BLOCK TYPE E (2 POWER IP-NP-E)
F	SOCKET BLOCK TYPE F (1 POWER IP-NP-E, IP 20)
G	SOCKET BLOCK TYPE G (1 POWER IP-NP-E, IP 44)

**NOTES:**

- EQUIPMENT AND WAY OF INSTALLATION MUST CONFIRM TO THE GEORGIAN AND EUROPEAN STANDARDS AND RULES. ANY MODIFICATION OF EQUIPMENT MOUNTING SHOULD BE AGREED WITH DESIGNER. IT IS ALLOWED TO USE SIMILAR OR HIGHER QUALITY MATERIALS THAN INDICATED IN THE PROJECT.
- ALL EQUIPMENT (PANELS, SWITCHES, ACTUATORS, WIRING, ETC.) MUST HAVE PERMANENT MARKING ACCORDING TO THE NUMBERING IN THE DRAWING.
- USE SOLELY PVC CABLES THAT ARE PVC NON SPREADING FIRE INSULATION.
- TIES CONNECTION TO THE PANEL SHOULD BE ARRANGED.
- FOR LEGENDS AND DETAILS SEE LAYOUT GENERAL NOTES.
- SHELL AND CORE ACCORDING TO DRAWINGS PROVIDED BY CLIENT AND ON-SITE MEASUREMENTS.
- ALL MEASUREMENTS TO BE CHECKED ON SITE PRIOR TO PROCEEDING

**DOCUMENT REVIEW STATUS**

<input type="checkbox"/> A	REVIEWED Work may proceed
<input type="checkbox"/> B	REVIEWED WITH COMMENTS Review and re-submit. Work may proceed subject to comments.
<input type="checkbox"/> C	OBJECTION Revise and re-submit. Work may not proceed
<input type="checkbox"/> D	REJECTED Work may not proceed
<input type="checkbox"/> E	REVIEW NOT REQUIRED Work may proceed

**RIVERS**

No	Date	Description	Drawn	Checked	Approved
T00	4/12/2015	TENDER DOCUMENTS SUBMISSION	I.S.	R.F.	A.S.

**Silk Road Business Center LLC**

LEAD DESIGN ENTITY (LDE) APPROVED BY LDE

**AECOM**

NAME SCALE 1:100 PAPER SIZE A0

DRAWING STATUS

CONSULTANT / SUB-CONTRACTOR

**AECOM**


DRAWN BY NAME I.S. CHECKED BY NAME R.F. APPROVED BY NAME A.S.  
DATE 30/12/2015 DATE 1/12/2015 DATE 2/12/2015


DRAWING TITLE Radisson Blu Telegraph Hotel Electrical Power Layout at Level L5


DRAWING NUMBER RBTH-AE-EL-TD-L5-0013 REVISION T00


0 0.5 1 2 2.5m


1 2 3 4 5 6 7 8 9 10 11 12 13 14 15 16

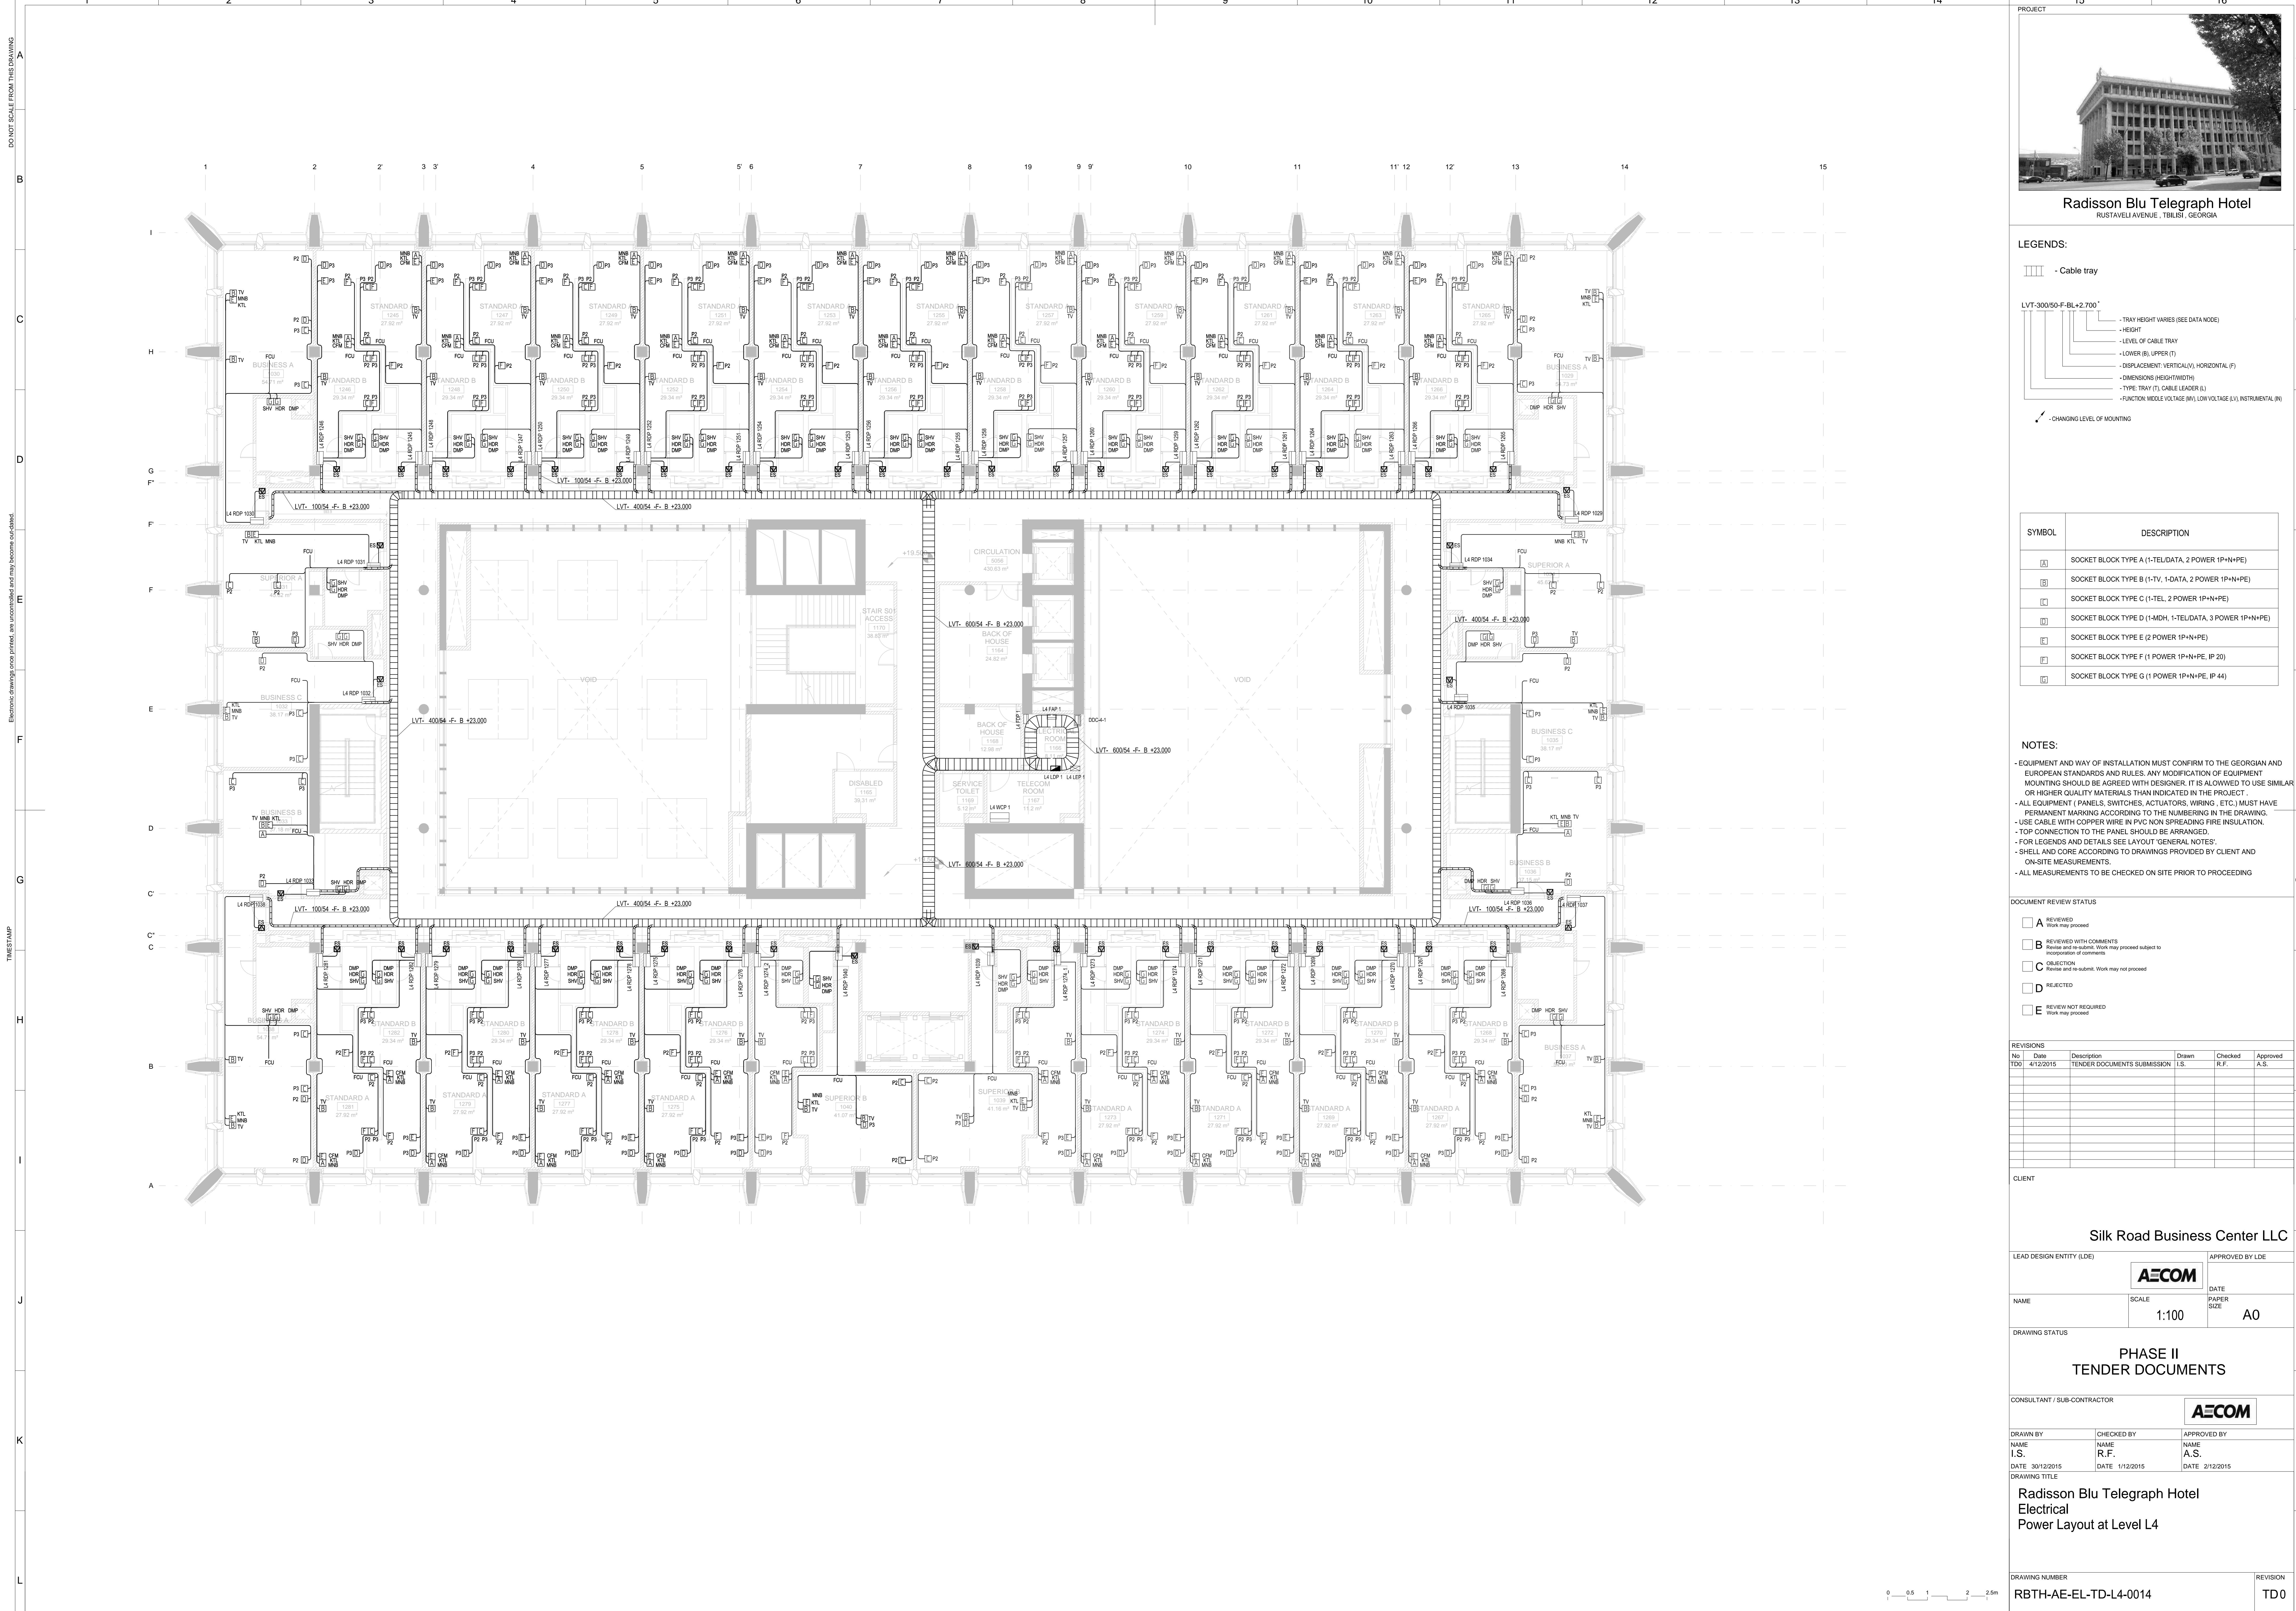


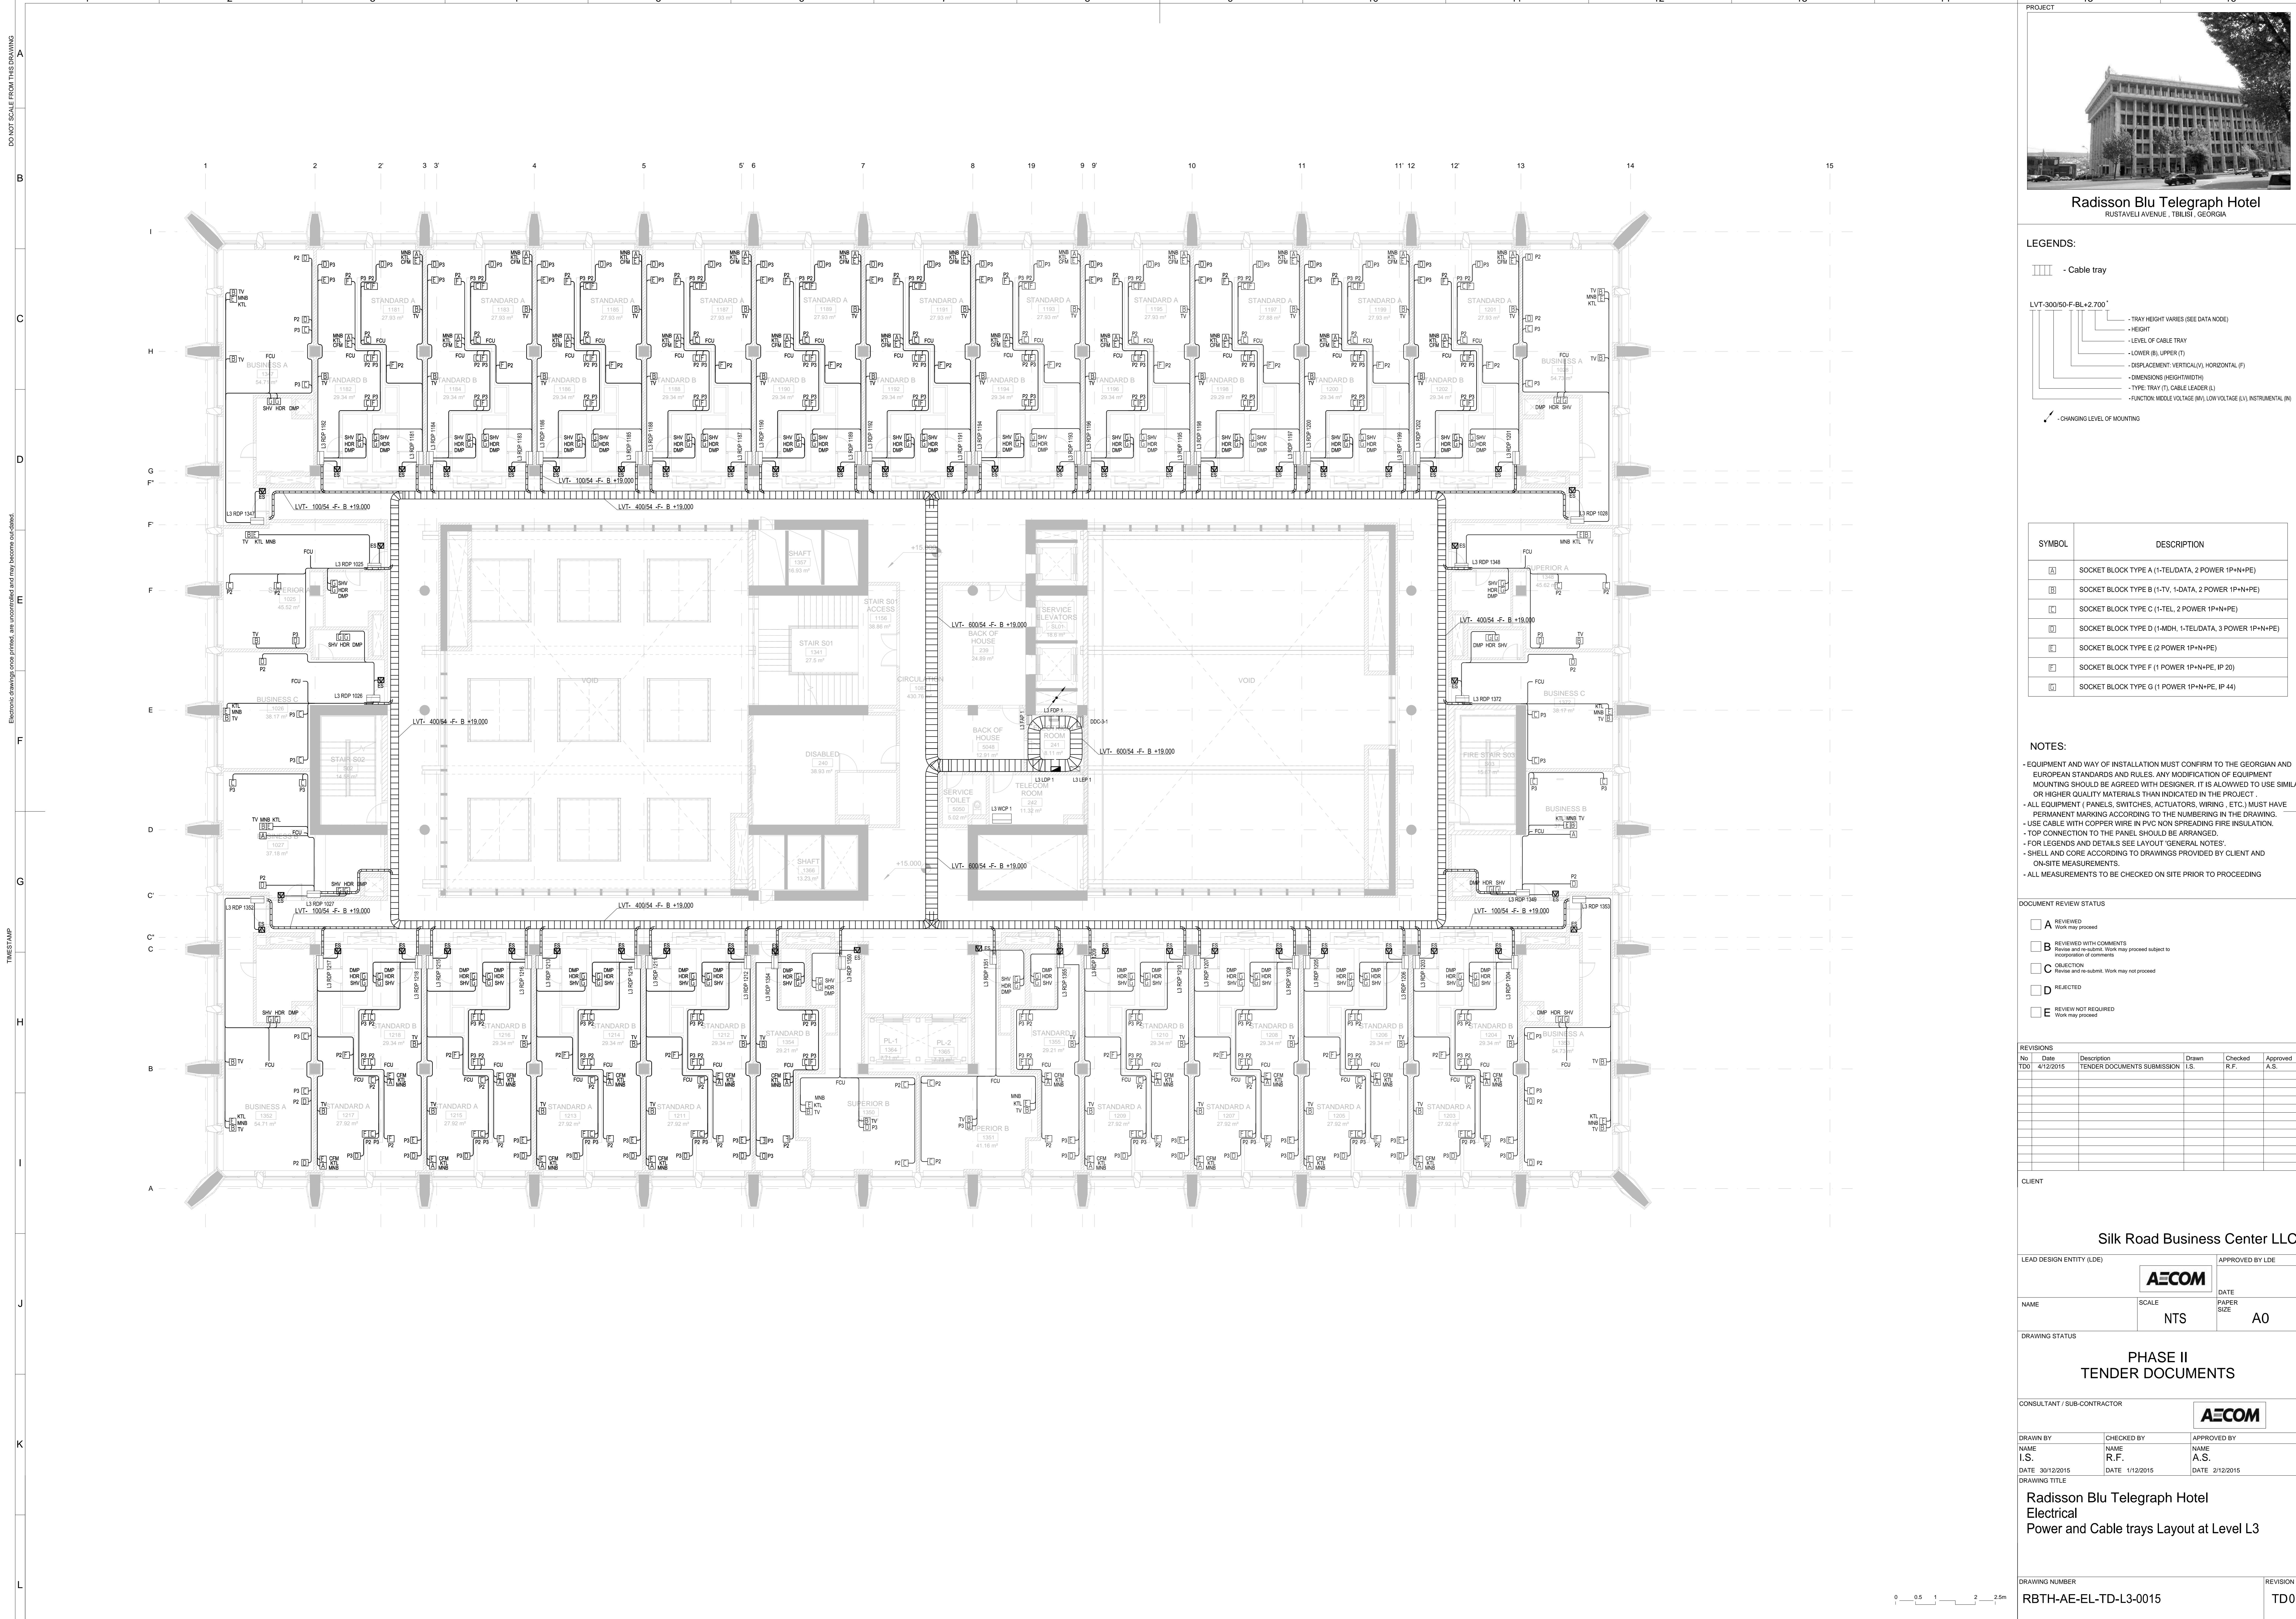

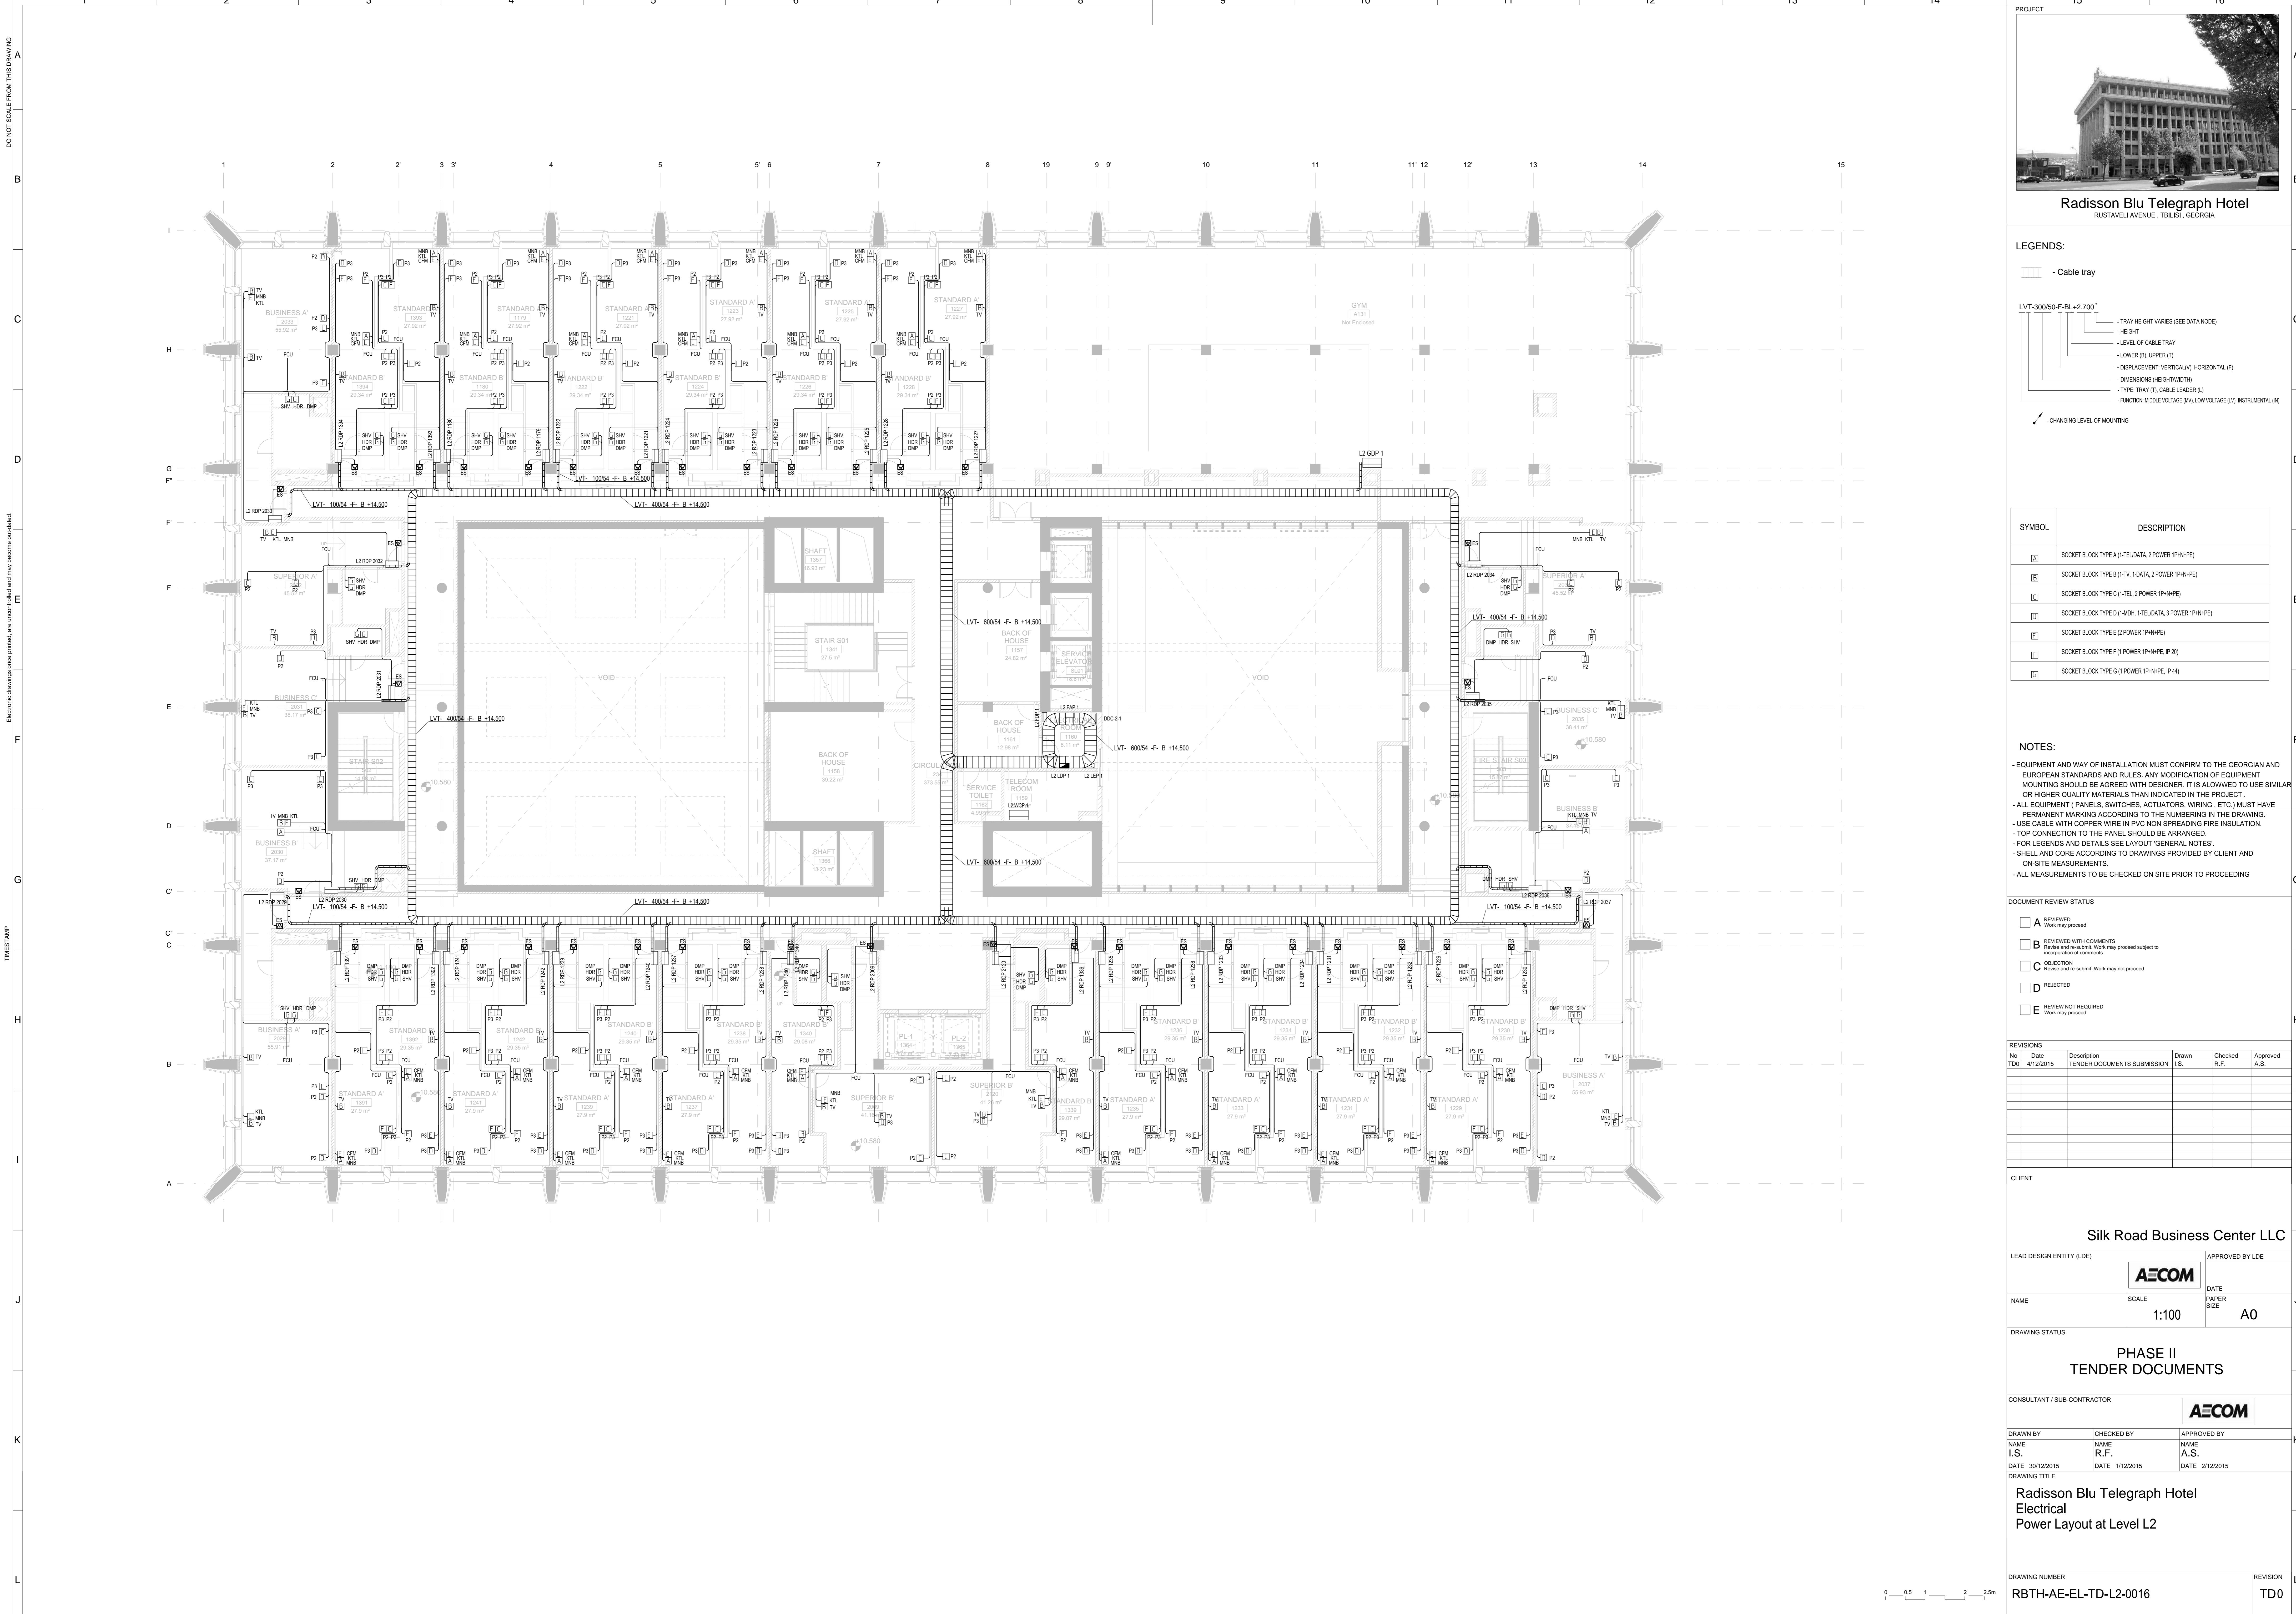

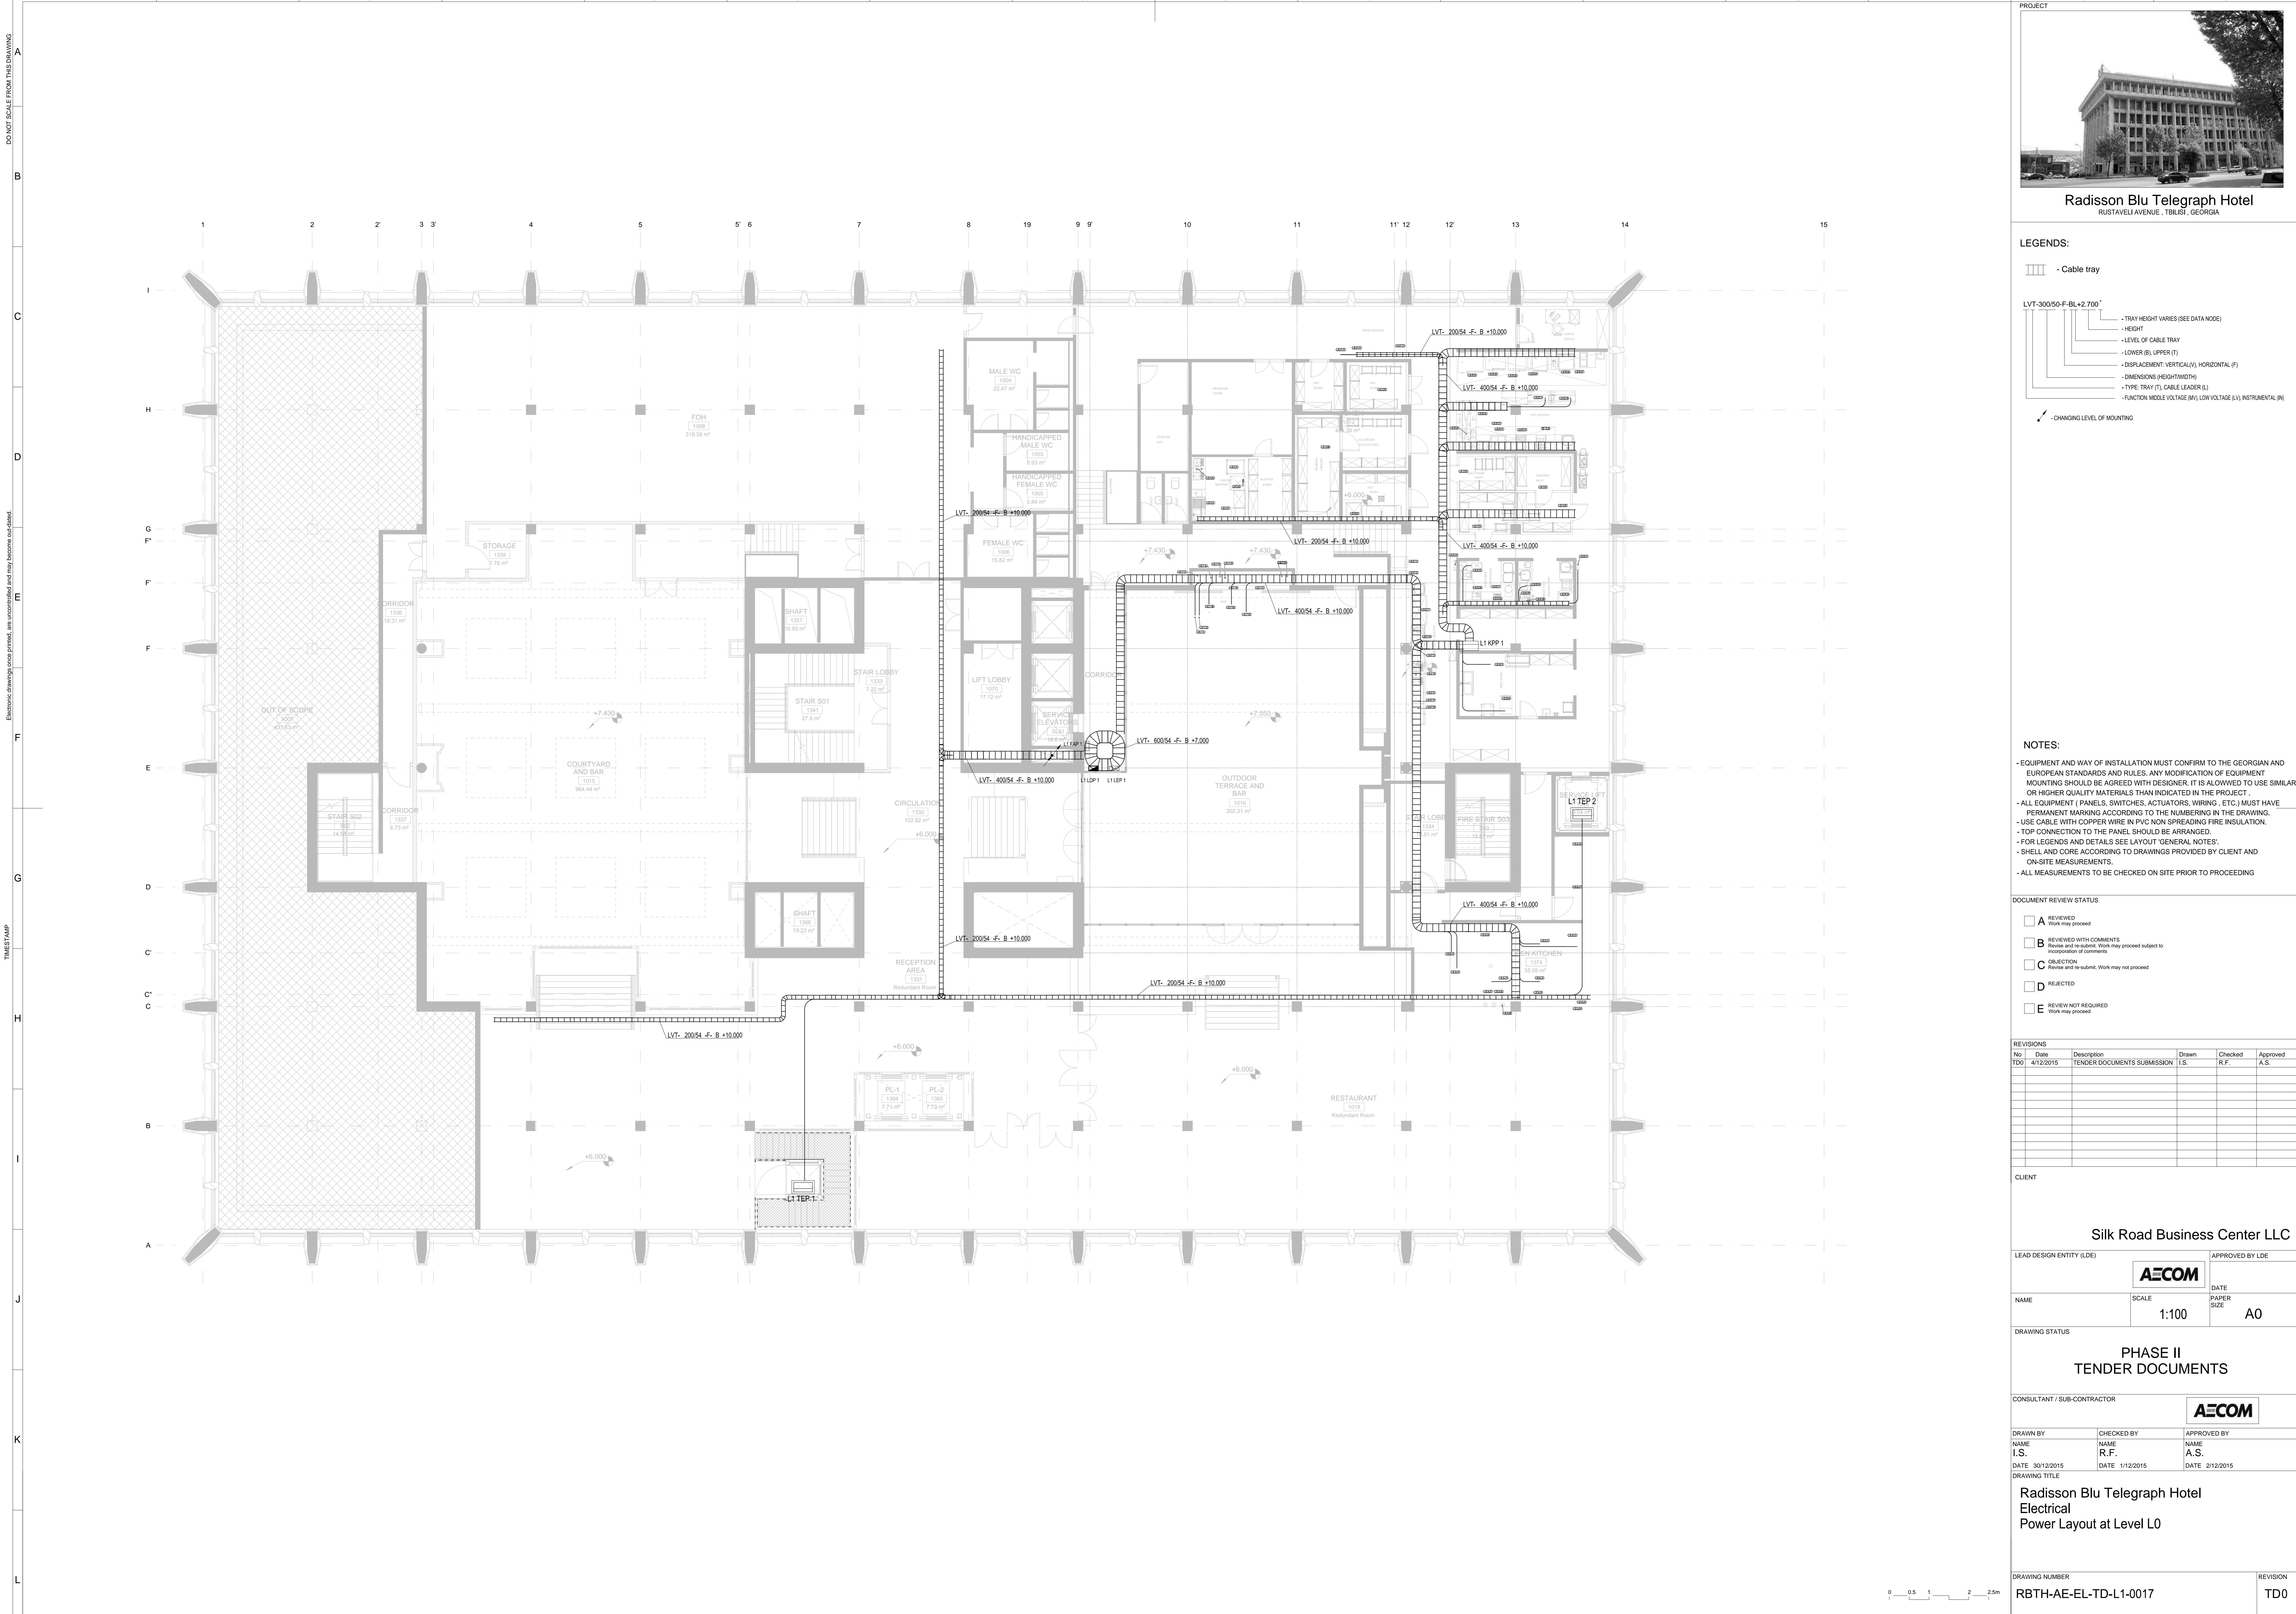


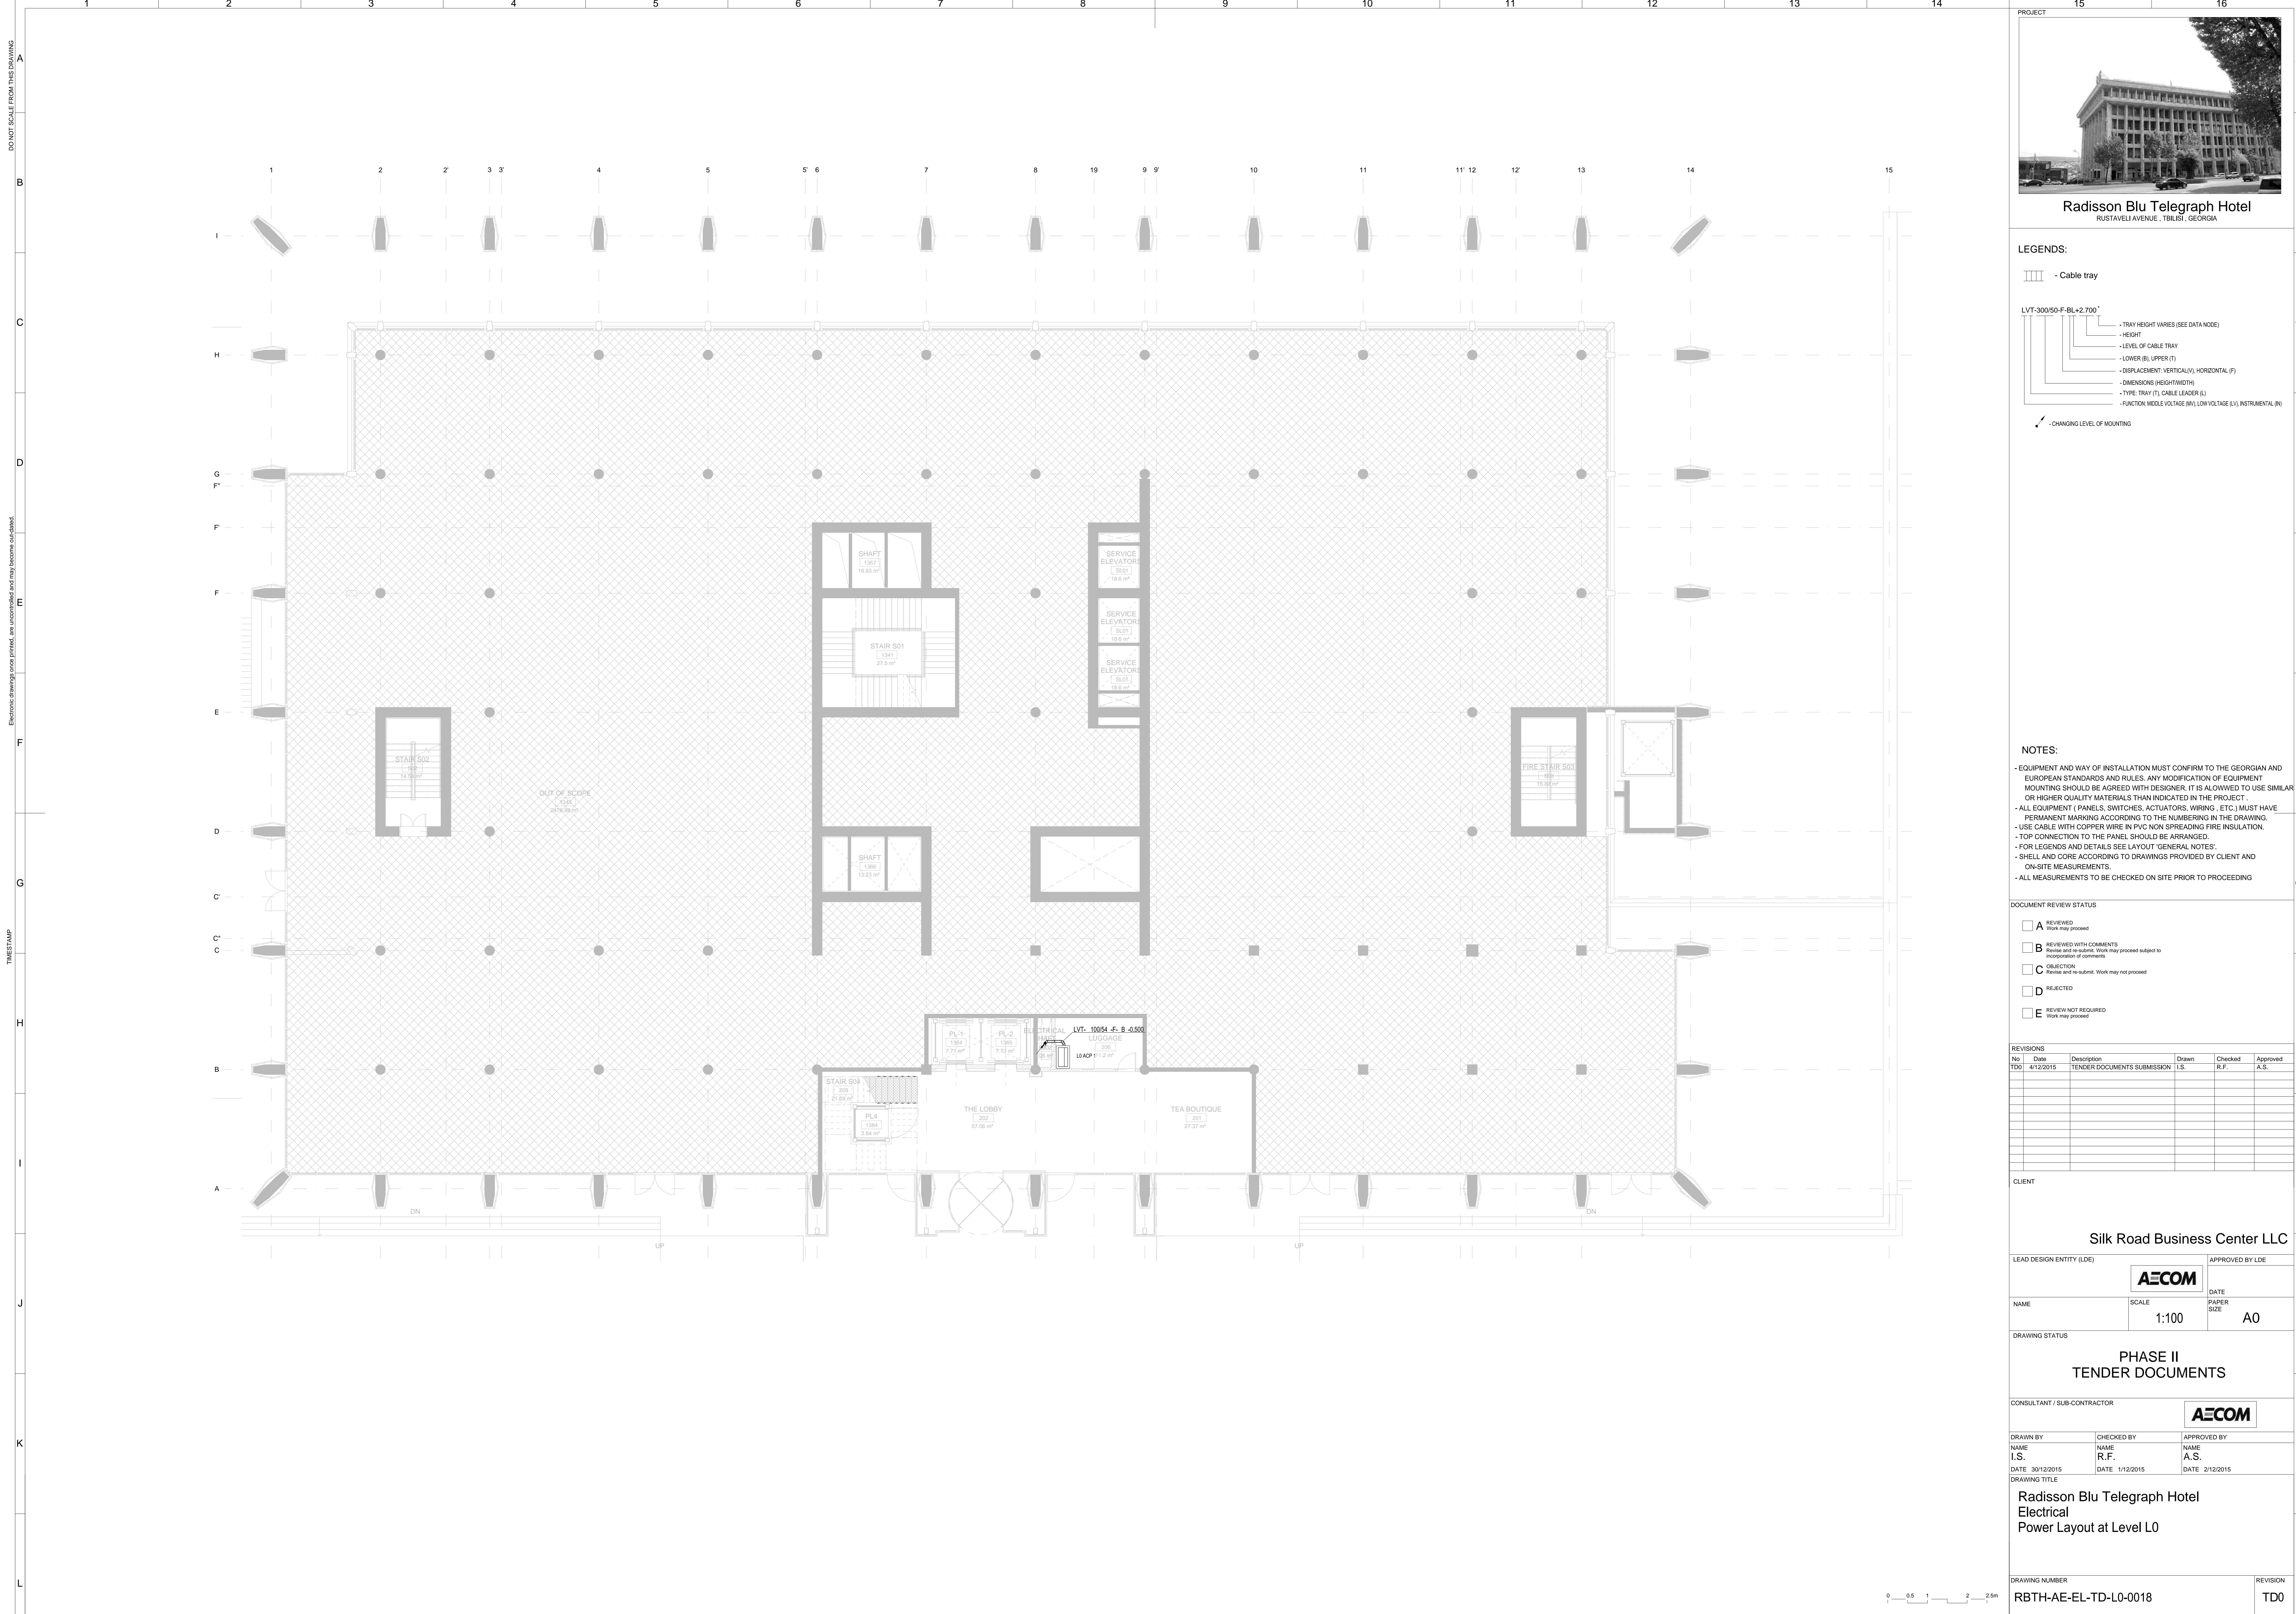


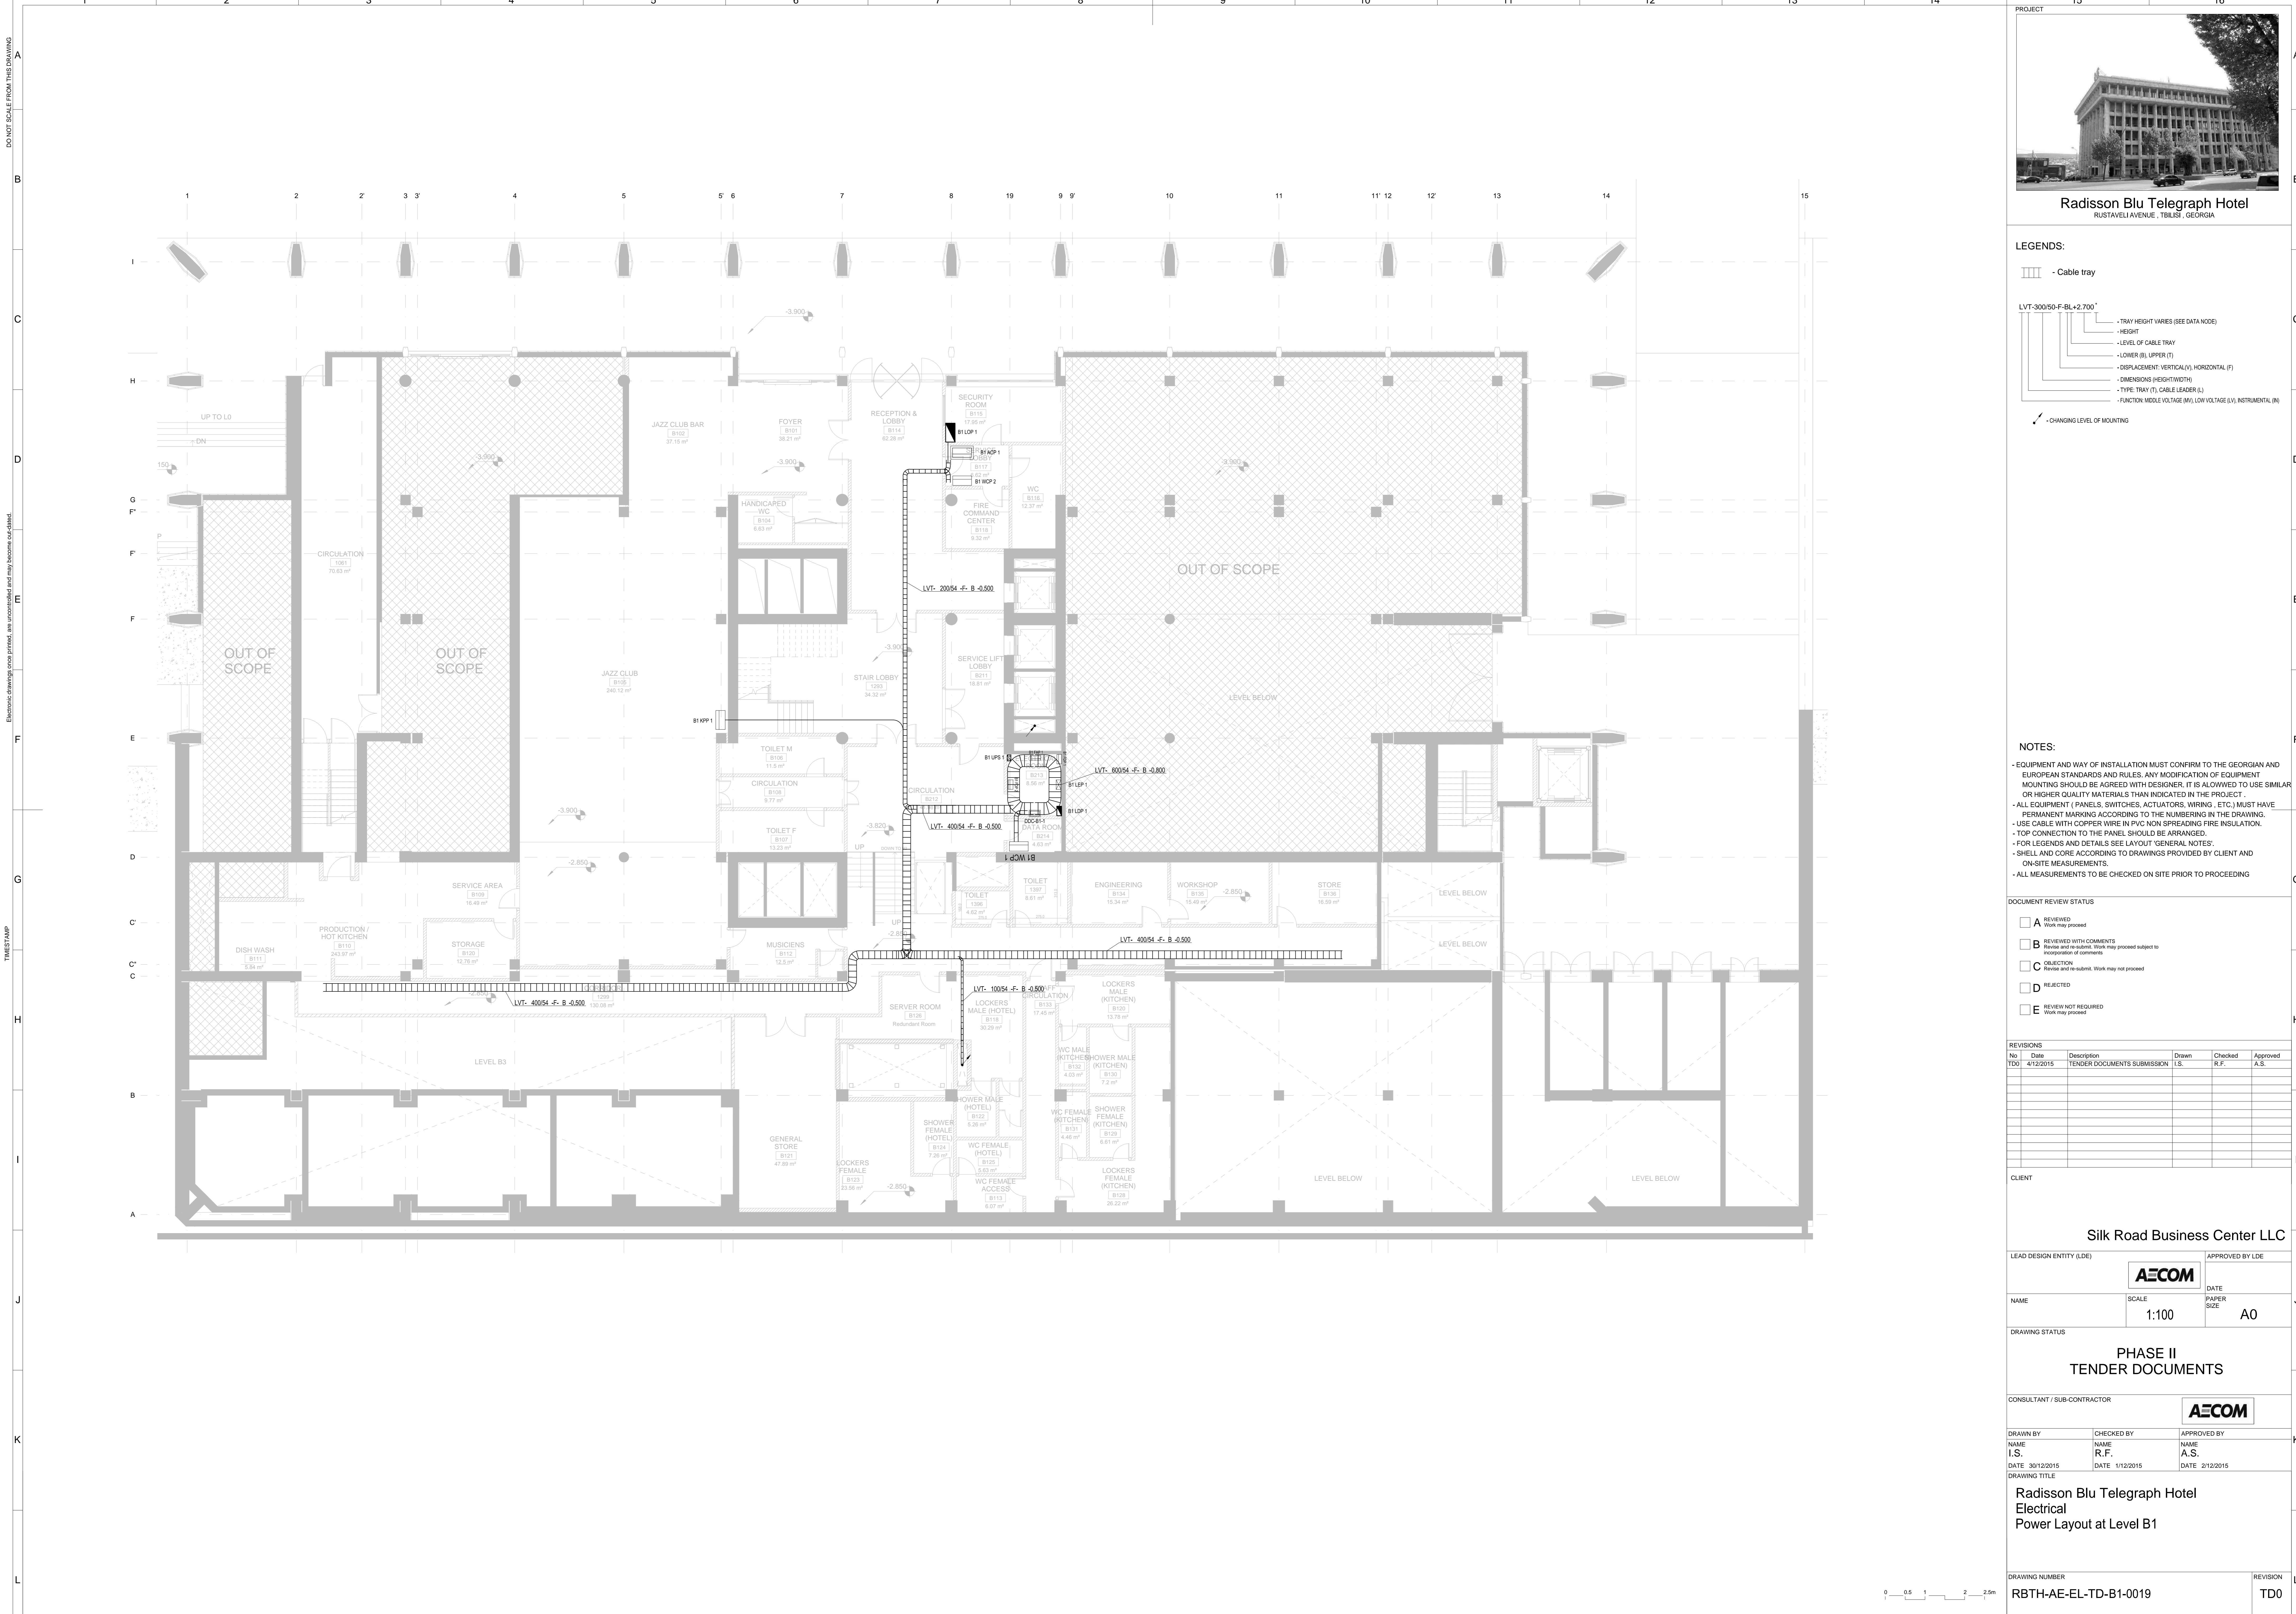





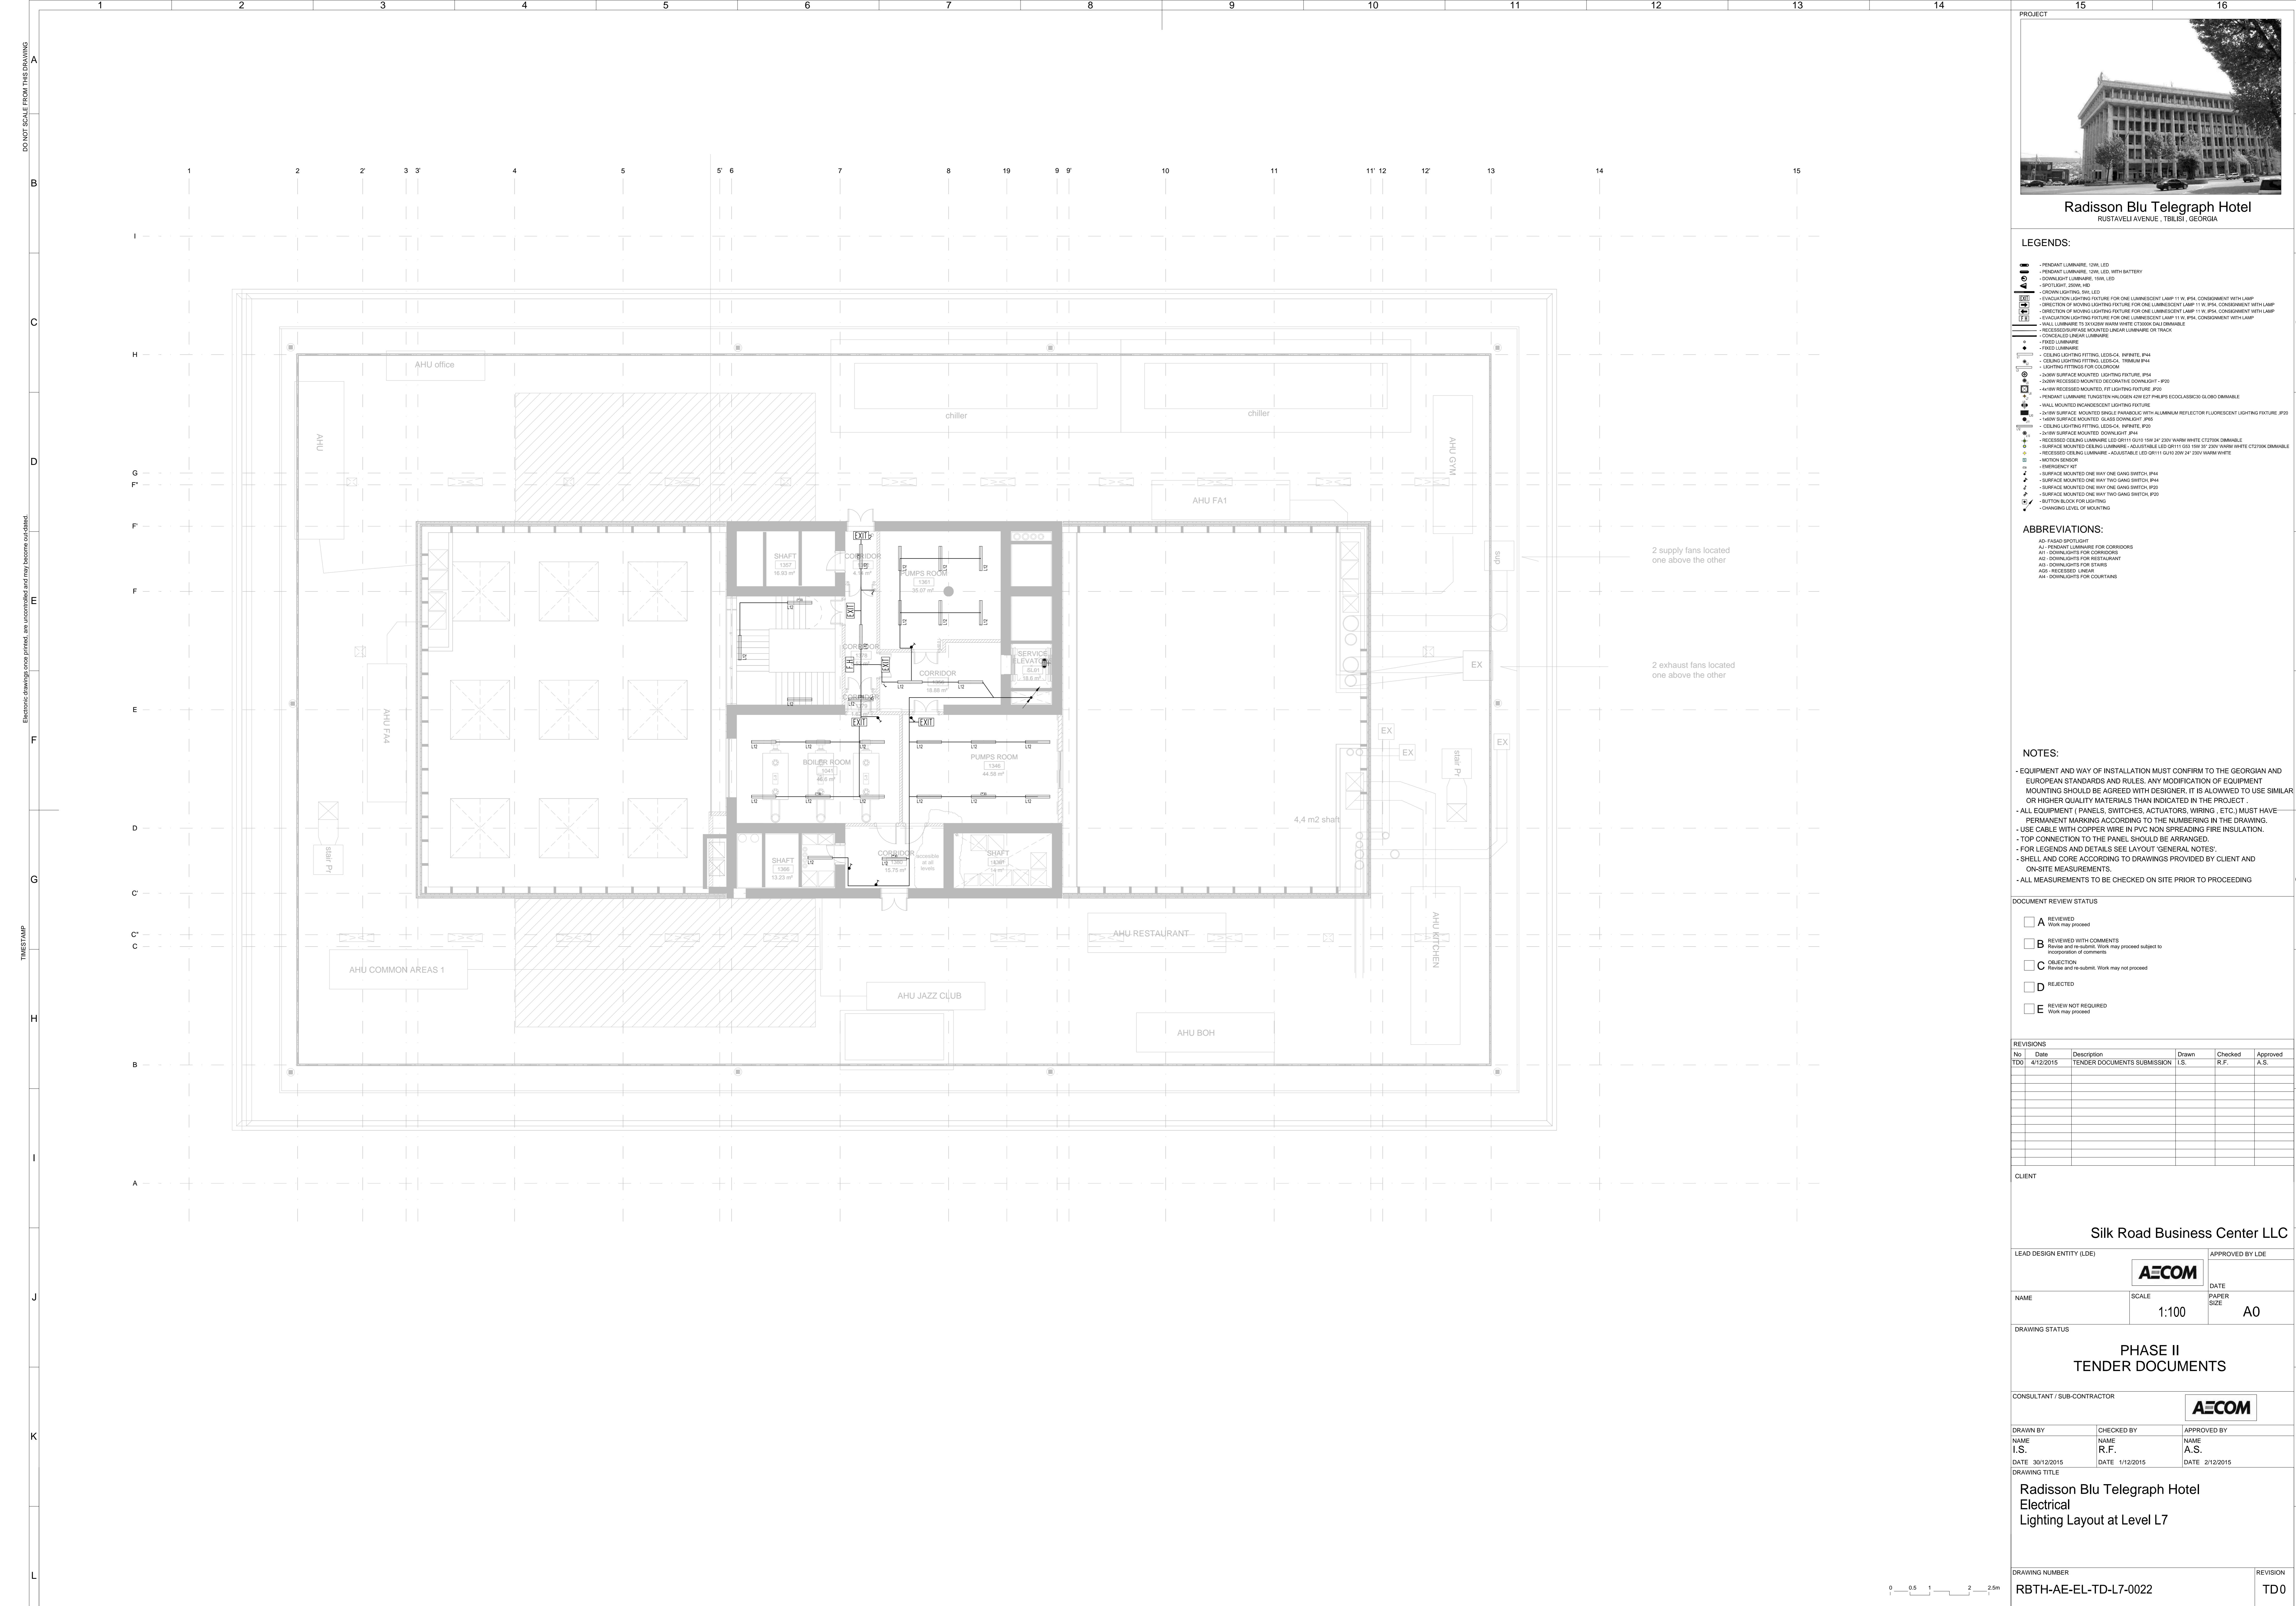

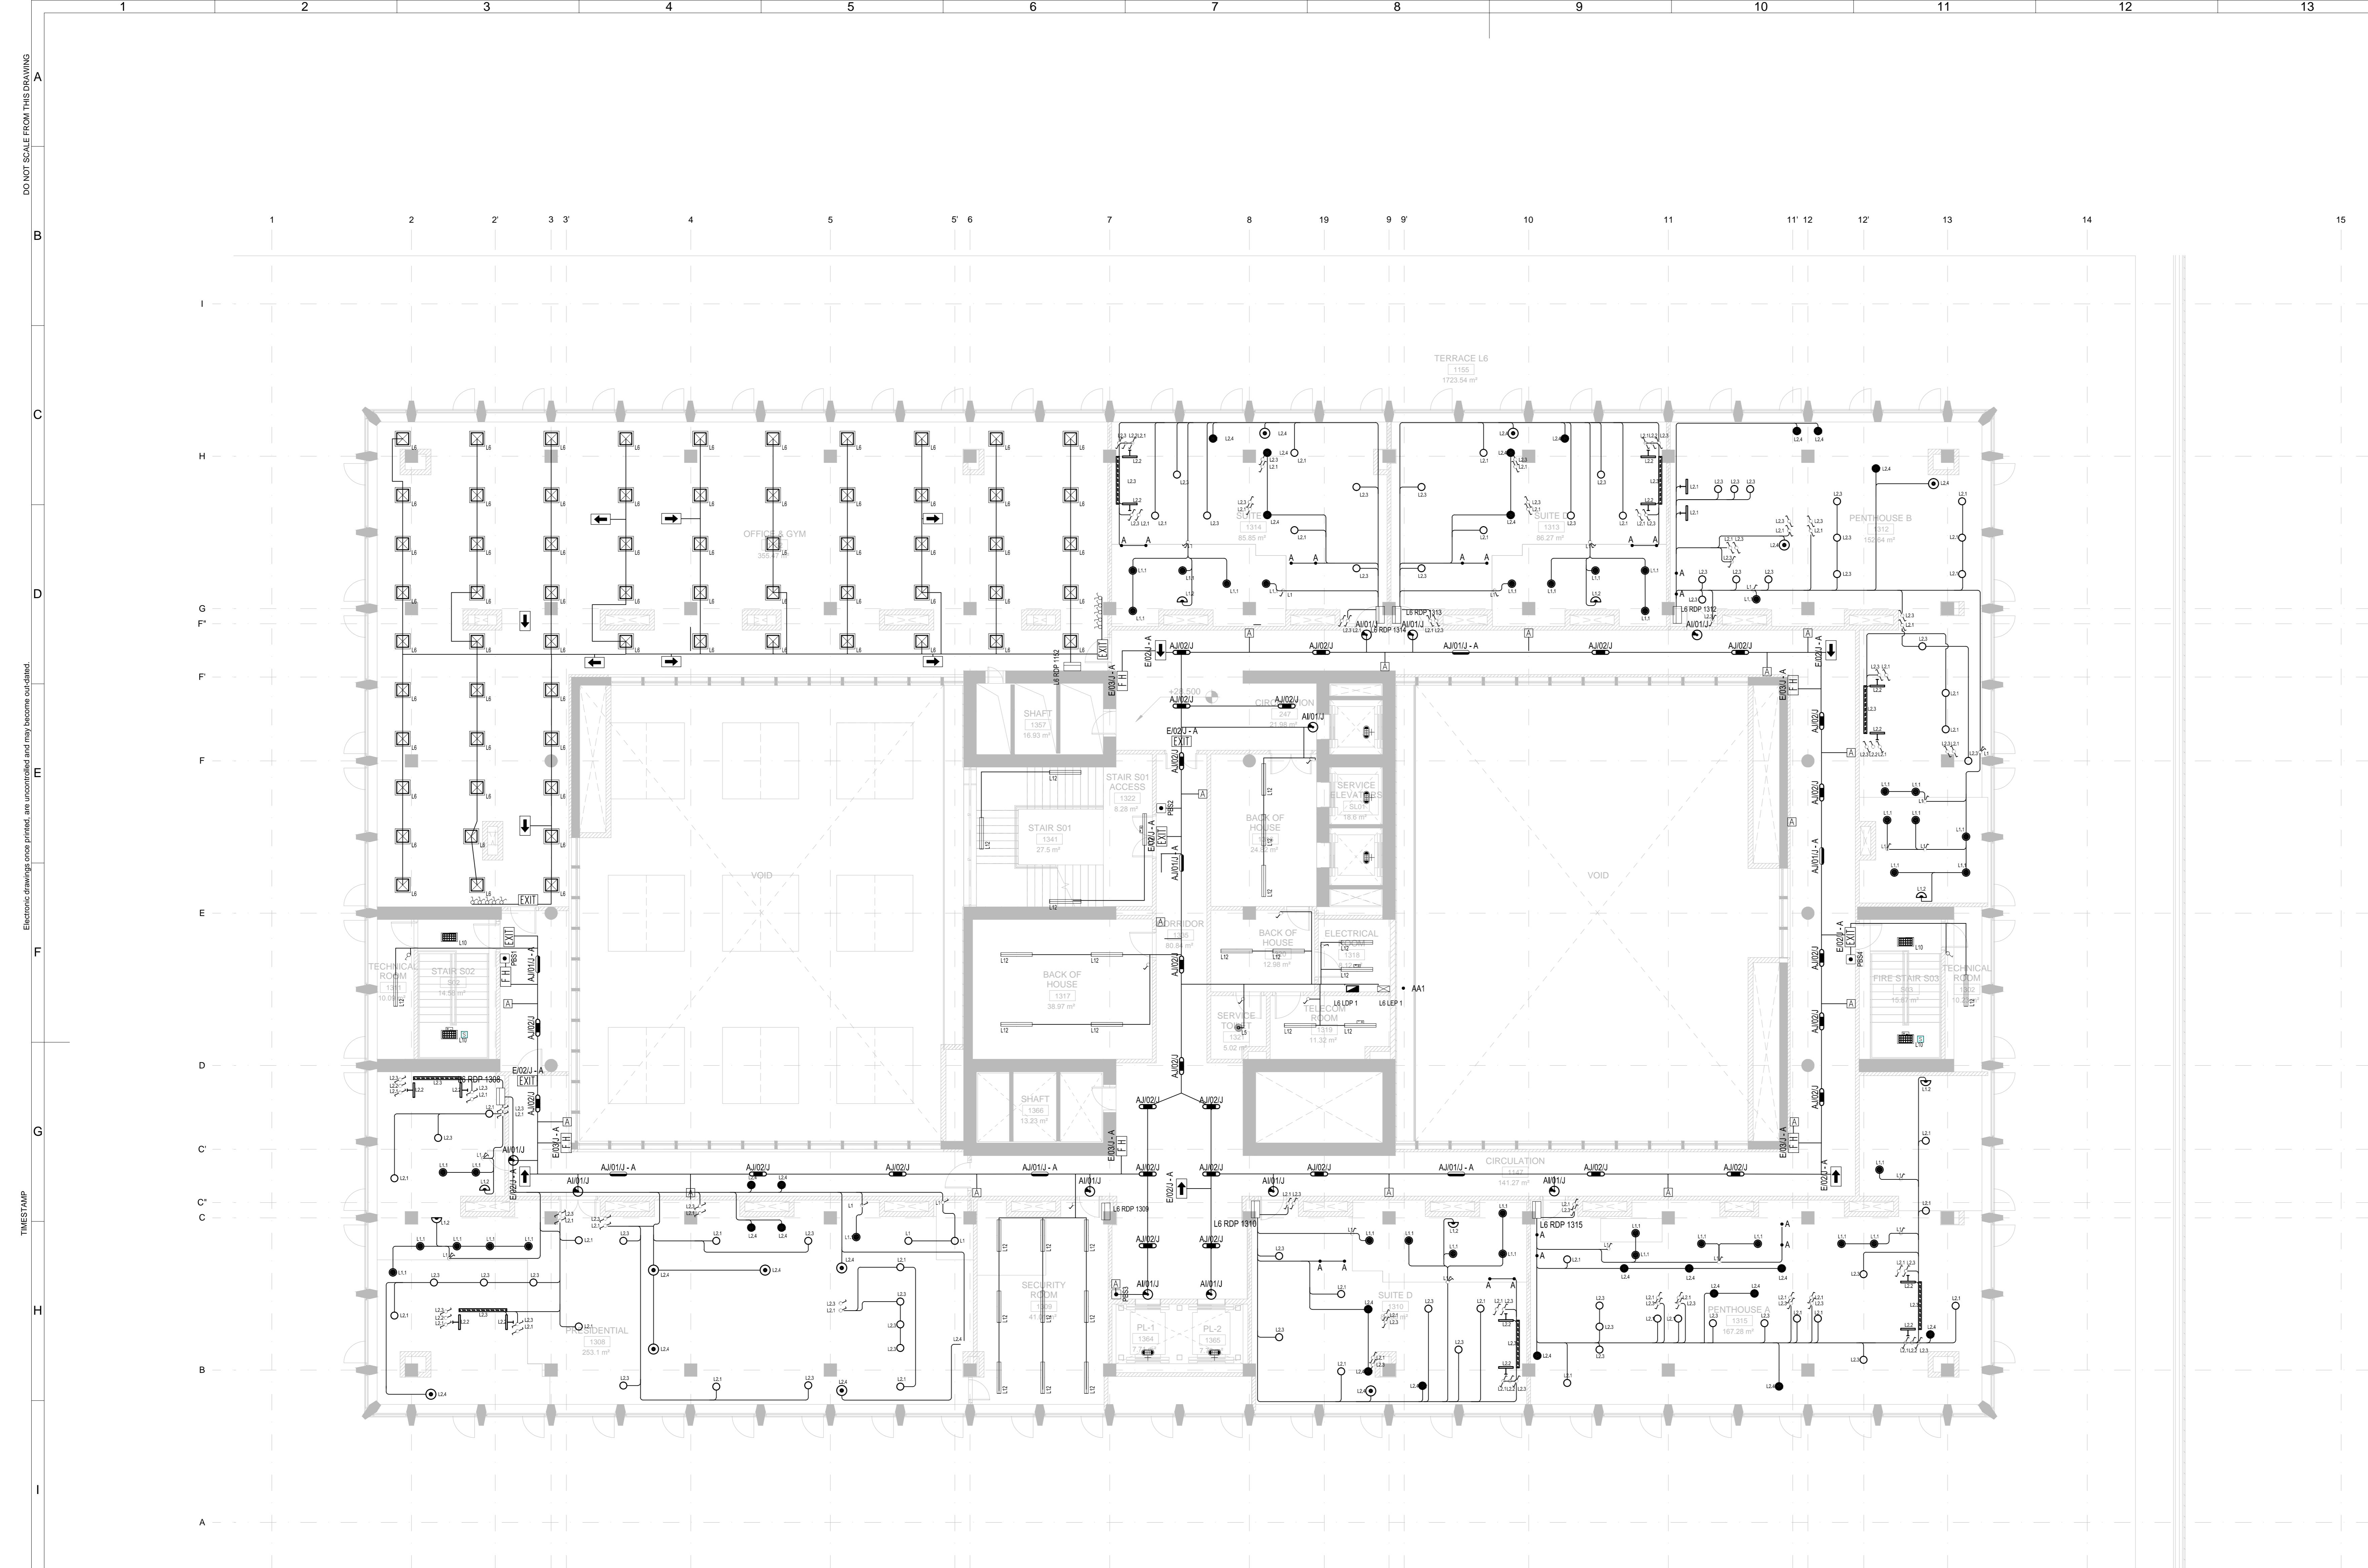

# adisson Blu Telegraph Hotel

RUSTAVELI AVENUE , TBILISI , GEORGIA

## LEGENDS:

- PENDANT LUMINAIRE, 12Wt, LED
  - PENDANT LUMINAIRE, 12Wt, LED, WITH BATTERY
  - DOWNLIGHT LUMINAIRE, 15Wt, LED
  - SPOTLIGHT, 250Wt, HID
  - - CROWN LIGHTING, 5Wt, LED
  - EVACUATION LIGHTING FIXTURE FOR ONE LUMINESCENT LAMP 11 W, IP54, CONSIGNMENT WITH LAMP
  - DIRECTION OF MOVING LIGHTING FIXTURE FOR ONE LUMINESCENT LAMP 11 W, IP54, CONSIGNMENT WITH LAMP
  - DIRECTION OF MOVING LIGHTING FIXTURE FOR ONE LUMINESCENT LAMP 11 W, IP54, CONSIGNMENT WITH LAMP
  - EVACUATION LIGHTING FIXTURE FOR ONE LUMINESCENT LAMP 11 W, IP54, CONSIGNMENT WITH LAMP
  - WALL LUMINAIRE T5 3X1X28W WARM WHITE CT3000K DALI DIMMABLE
  - RECESSED/SURFACE MOUNTED LINEAR LUMINAIRE OR TRACK
  - CONCEALED LINEAR LUMINAIRE
  - FIXED LUMINAIRE
  - FIXED LUMINAIRE
  - CEILING LIGHTING FITTING, LEDS-C4, INFINITE, IP44
  - CEILING LIGHTING FITTING, LEDS-C4, TRIMIUM IP44
  - LIGHTING FITTINGS FOR COLDROOM
  - 2x36W SURFACE MOUNTED LIGHTING FIXTURE, IP54
  - 2x26W RECESSED MOUNTED DECORATIVE DOWNLIGHT - IP20
  - 4x18W RECESSED MOUNTED, FIT LIGHTING FIXTURE ,IP20
  - PENDANT LUMINAIRE TUNGSTEN HALOGEN 42W E27 PHILIPS ECOCLASSIC30 GLOBO DIMMABLE
  - WALL MOUNTED INCANDESCENT LIGHTING FIXTURE
  - 2x18W SURFACE MOUNTED SINGLE PARABOLIC WITH ALUMINIUM REFLECTOR FLUORESCENT LIGHTING FIXTURE ,IP20
  - 1x60W SURFACE MOUNTED GLASS DOWNLIGHT ,IP65
  - CEILING LIGHTING FITTING, LEDS-C4, INFINITE, IP20
  - 2x18W SURFACE MOUNTED DOWNLIGHT ,IP44
  - RECESSED CEILING LUMINAIRE LED QR111 GU10 15W 24° 230V WARM WHITE CT2700K DIMMABLE
  - SURFACE MOUNTED CEILING LUMINAIRE - ADJUSTABLE LED QR111 G53 15W 35° 230V WARM WHITE CT2700K DIMMABLE
  - RECESSED CEILING LUMINAIRE - ADJUSTABLE LED QR111 GU10 20W 24° 230V WARM WHITE
  - MOTION SENSOR
  - EMERGENCY KIT
  - SURFACE MOUNTED ONE WAY ONE GANG SWITCH, IP44
  - SURFACE MOUNTED ONE WAY TWO GANG SWITCH, IP44
  - SURFACE MOUNTED ONE WAY ONE GANG SWITCH, IP20
  - SURFACE MOUNTED ONE WAY TWO GANG SWITCH, IP20
  - BUTTON BLOCK FOR LIGHTING
  - CHANGING LEVEL OF MOUNTING

## ABBREVIATION

- AD- FASAD SPOTLIGHT  
AJ - PENDANT LUMINAIRE FOR CORRIDORS  
AI1 - DOWNLIGHTS FOR CORRIDORS  
AI2 - DOWNLIGHTS FOR RESTAURANT  
AI3 - DOWNLIGHTS FOR STAIRS  
AG5 - RECESSED LINEAR  
AM - DOWNLIGHTS FOR CURTAINS

0105

- EQUIPMENT AND WAY OF INSTALLATION MUST CONFIRM TO THE GEORGIAN AND EUROPEAN STANDARDS AND RULES. ANY MODIFICATION OF EQUIPMENT COUNTING SHOULD BE AGREED WITH DESIGNER. IT IS ALLOWED TO USE SIMILAR HIGHER QUALITY MATERIALS THAN INDICATED IN THE PROJECT . EQUIPMENT ( PANELS, SWITCHES, ACTUATORS, WIRING , ETC.) MUST HAVE PERMANENT MARKING ACCORDING TO THE NUMBERING IN THE DRAWING. CABLE WITH COPPER WIRE IN PVC NON SPREADING FIRE INSULATION. CONNECTION TO THE PANEL SHOULD BE ARRANGED. FOR LEGENDS AND DETAILS SEE LAYOUT 'GENERAL NOTES'. CELL AND CORE ACCORDING TO DRAWINGS PROVIDED BY CLIENT AND ON-SITE MEASUREMENTS. MEASUREMENTS TO BE CHECKED ON SITE PRIOR TO PROCEEDING

#### MENT REVIEW STATUS

- A REVIEWED  
Work may proceed
  - B REVIEWED WITH COMMENTS  
Revise and re-submit. Work may proceed subject to incorporation of comments
  - C OBJECTION  
Revise and re-submit. Work may not proceed
  - D REJECTED

ONS				
Date	Description	Drawn	Checked	Approved
4/12/2015	TENDER DOCUMENTS SUBMISSION	I.S.	R.F.	A.S.

Silk Road Business Center LLC

Silk Road Business Center LLC

APP

DATE

	SCALE	DATE
	1:100	PAPER SIZE A0

For more information about the study, please contact the study team at 1-800-258-4929 or visit [www.cancer.gov](http://www.cancer.gov).

ULTANT / SUB-CONTRACTOR

BY APPROVED BY

NAME  
A.S.

30/12/2015	DATE 1/12/2015	DATE 2/12/2015
ING TITLE		


# adisson Blu Telegraph Hotel electrical ighting Layout at Level L6

REF ID: A1234567890 | PAGE 1 OF 1 | DRAFT | 01/01/2024



TH-AE-EL-TD-L6-0023 TD0

www.willvd.com

15 | 16

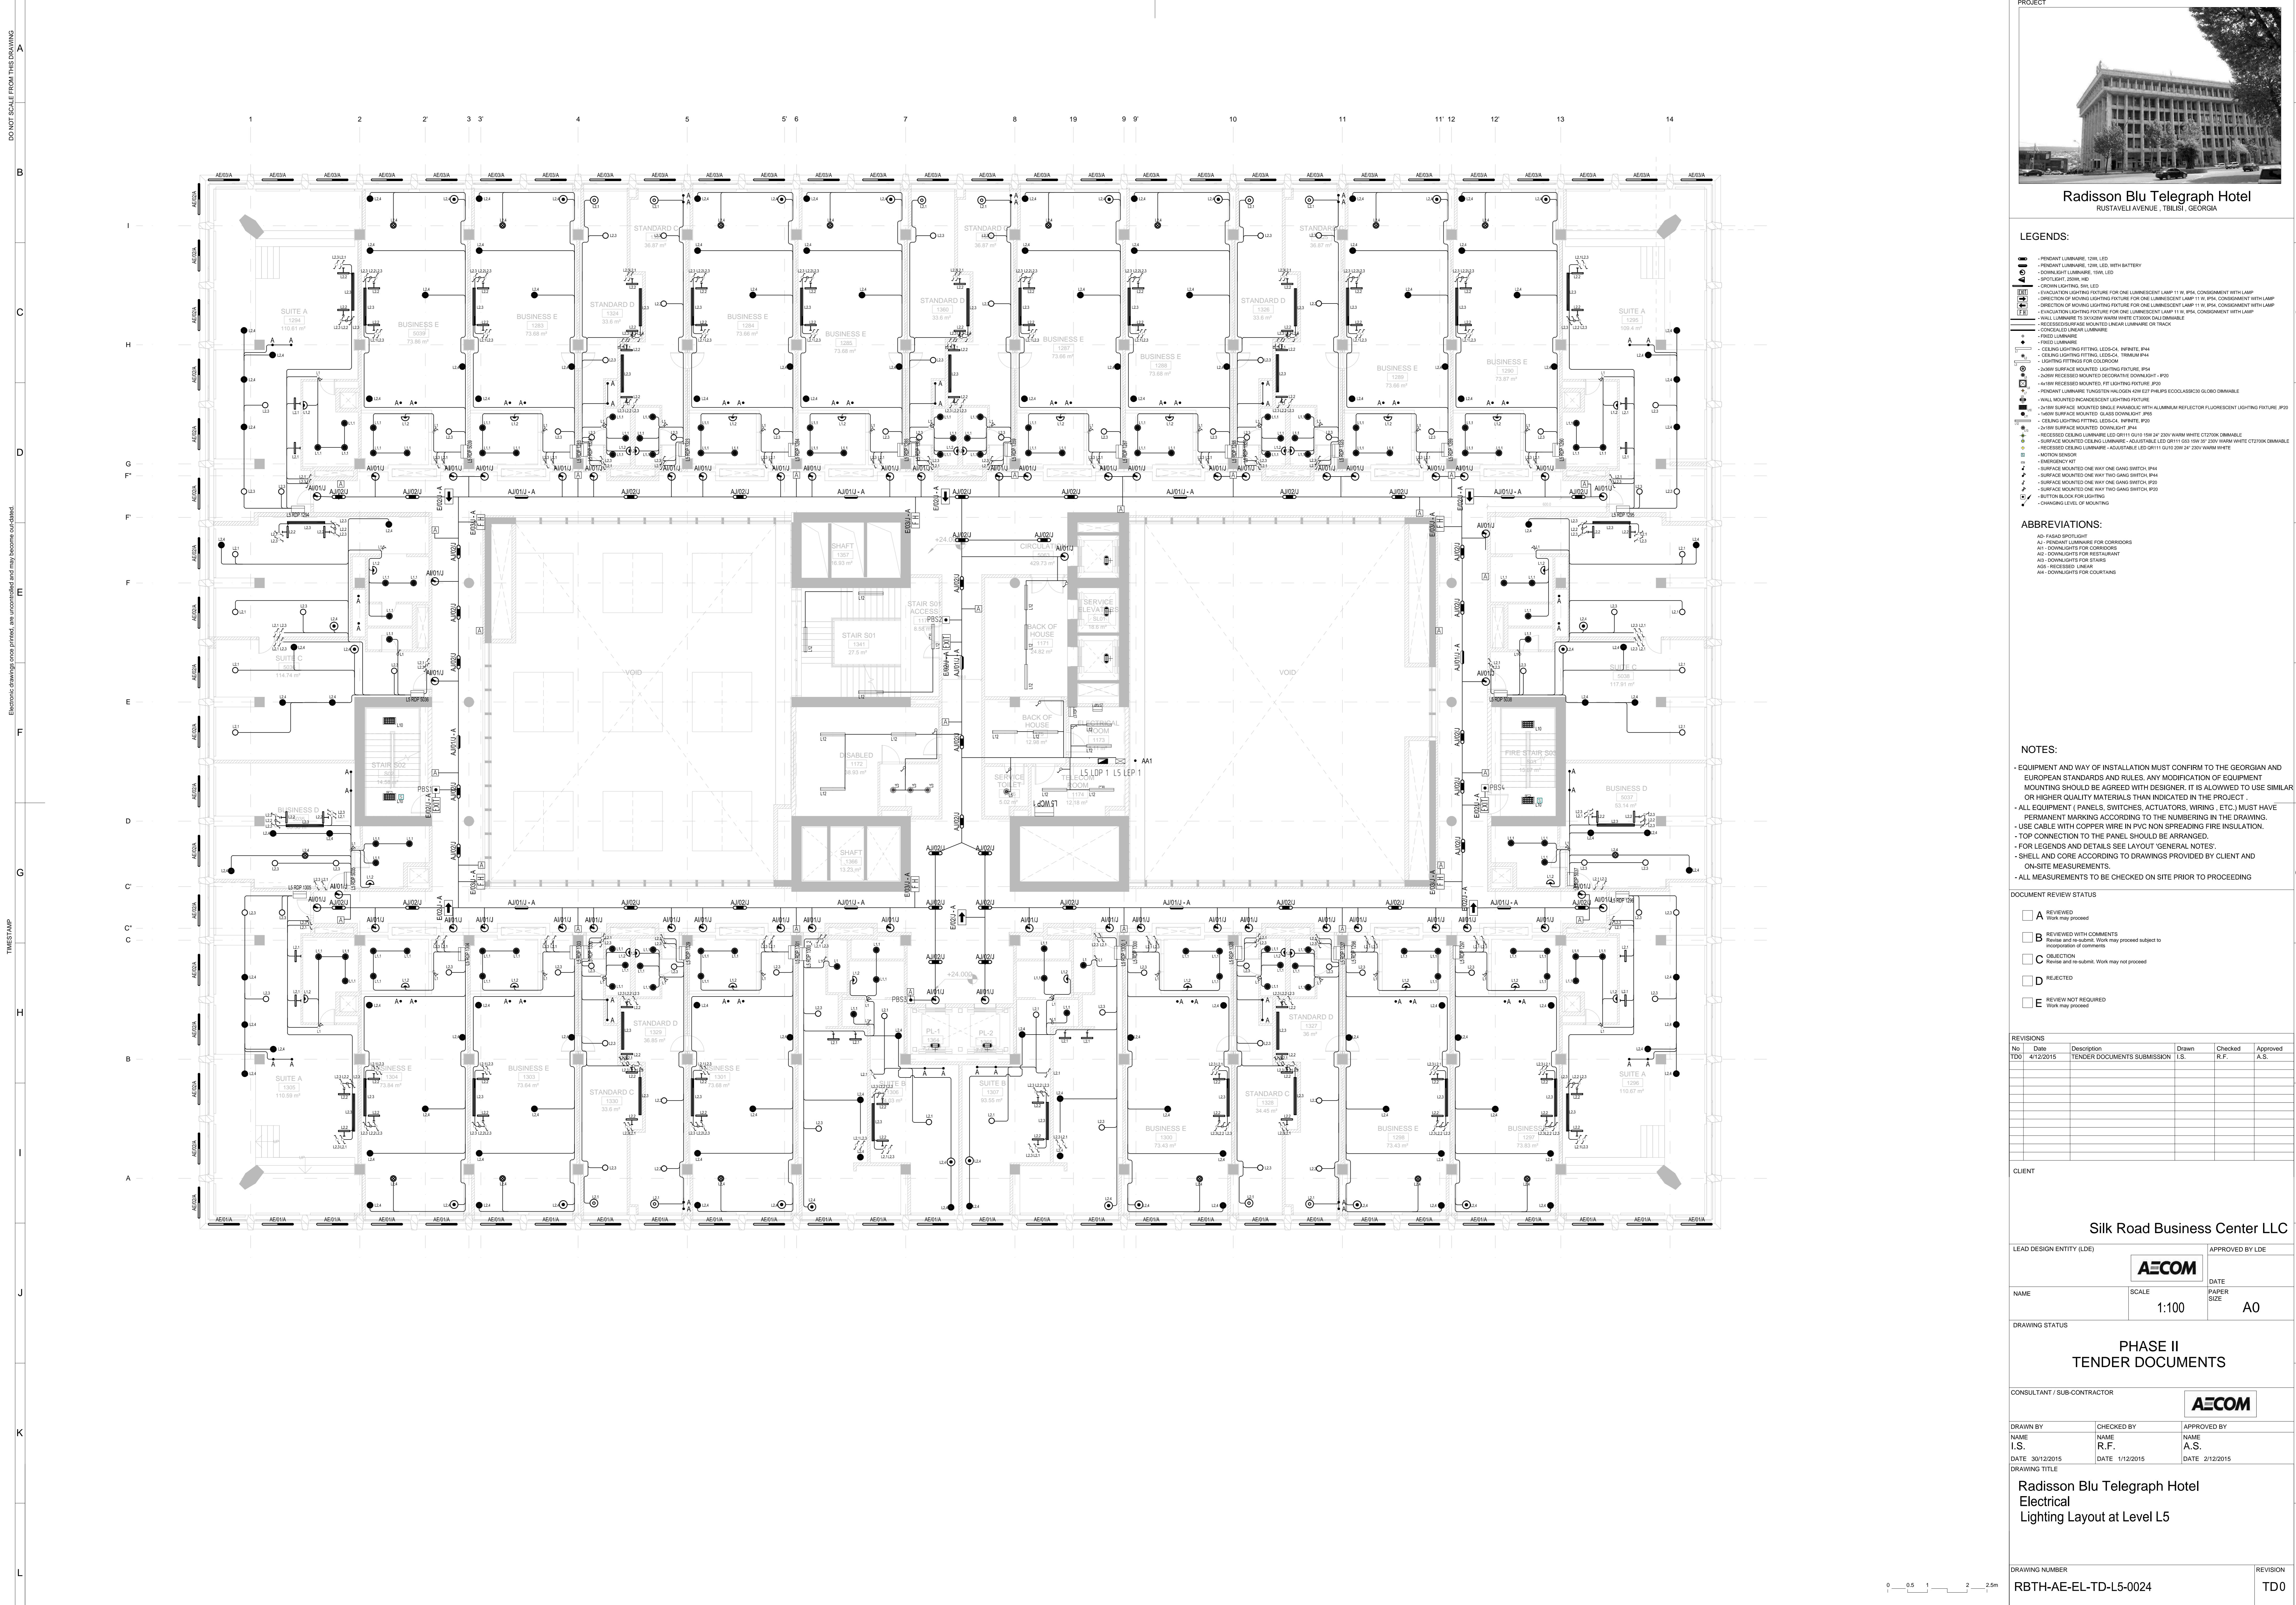

DO NOT SCALE FROM THIS DRAWING

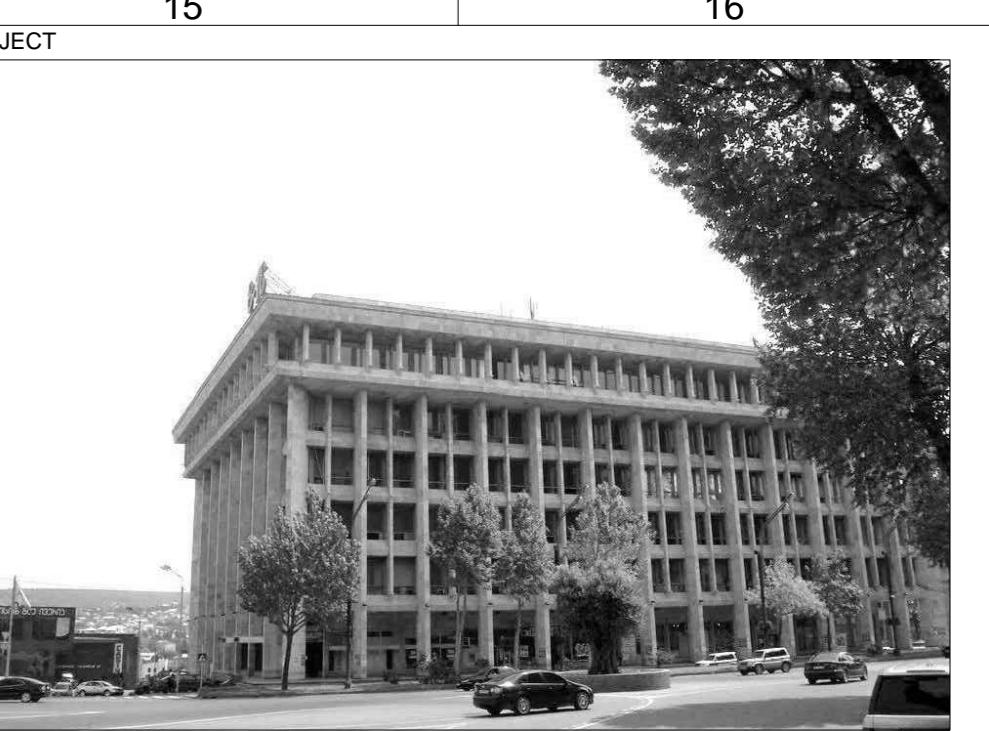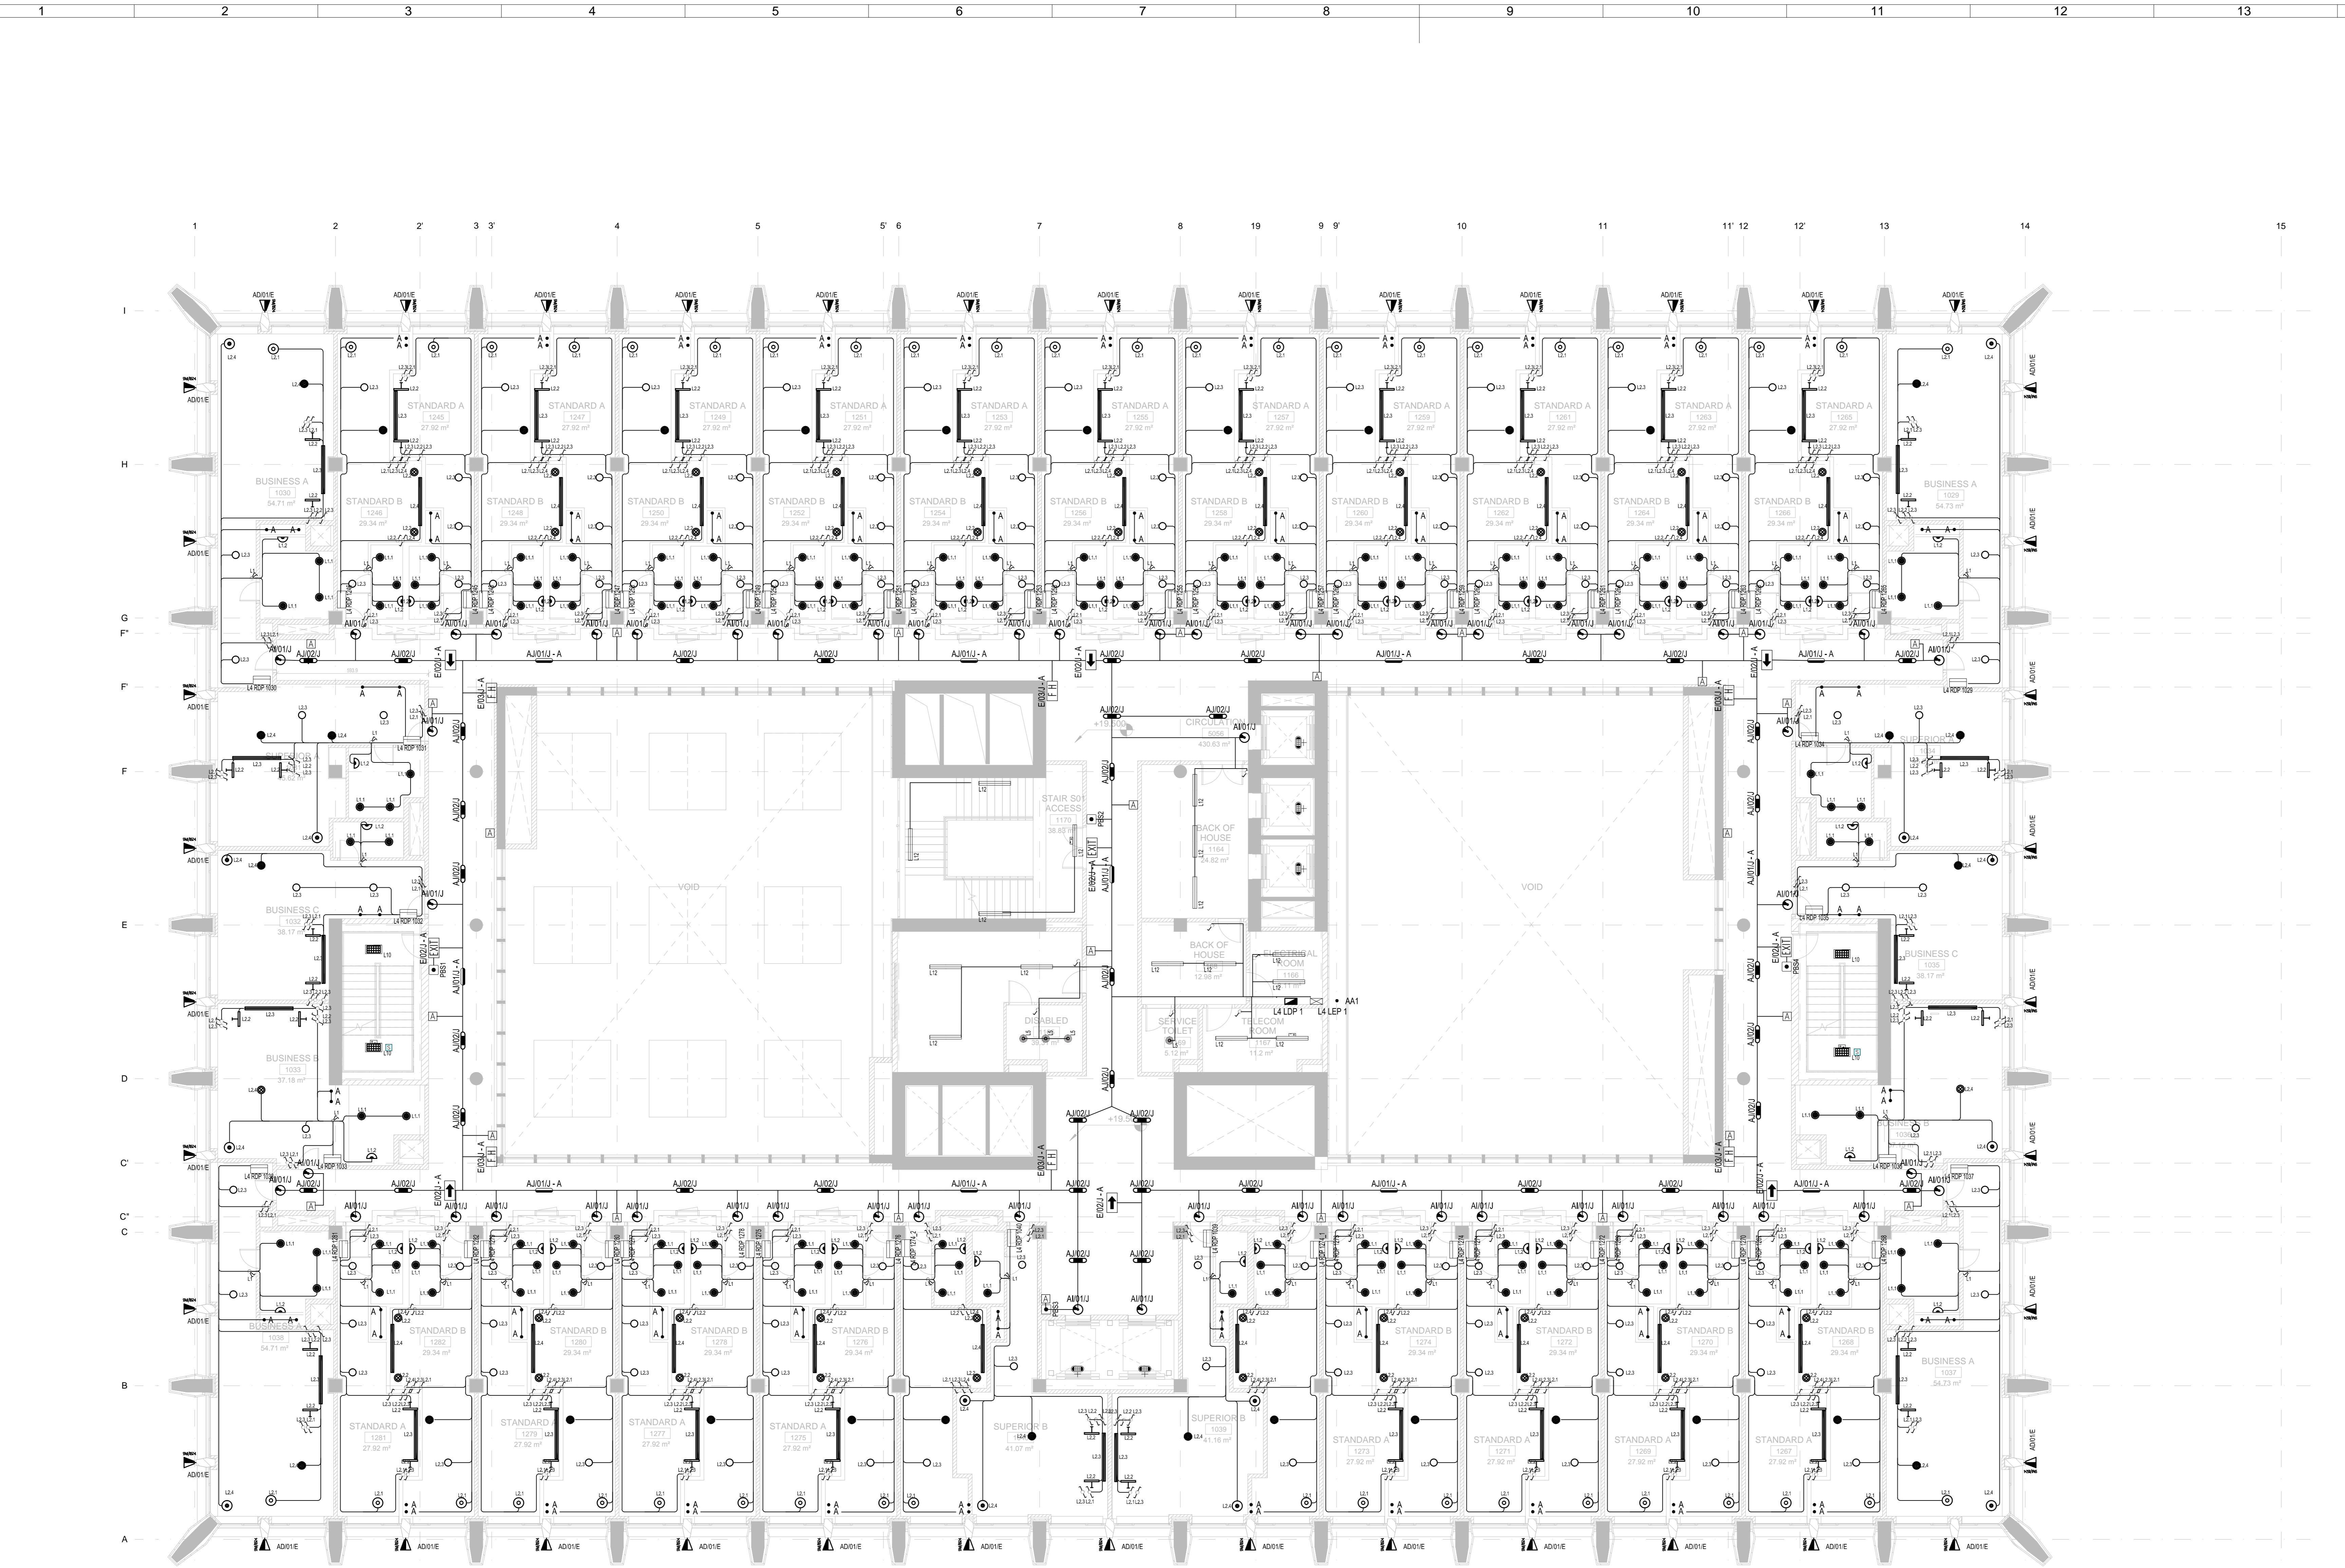

**Radisson Blu Telegraph Hotel**  
RUSTAVELI AVENUE, TBILISI, GEORGIA

LEGENDS:

- PENDANT LUMINARE, 12W LED
- PENDANT LUMINARE, 12W LED WITH BATTERY
- SPOTLIGHT, 20W, HD
- CROWN LIGHTING, SWL, 15W, LED
- DIRECTION OF MOVING LIGHTING FIXTURE FOR ONE LUMINESCENT LAMP 11W IP54, CONSIDERATION WITH LAMP
- DIRECTION OF MOVING LIGHTING FIXTURE FOR ONE LUMINESCENT LAMP 11W IP54, CONSIDERATION WITH LAMP
- EVACUATION LIGHTING FIXTURE FOR ONE LUMINESCENT LAMP 11W IP54, CONSIDERATION WITH LAMP
- WALL MOUNTED LINEAR LUMINARE, 12W LED, DIMMABLE
- RECESSED LINEAR LUMINARE, 12W LED, DIMMABLE
- FIXED LUMINARE
- CEILING LIGHTING FITTING, LED, 24W, INFINITE IP44
- SURFACE MOUNTED CEILING LUMINARE, ADJUSTABLE LED, 12W, TRIMLESS IP44
- 2X2W SURFACE MOUNTED DECORATIVE DOWNLIGHT IP54
- SURFACE MOUNTED DECORATIVE DOWNLIGHT IP54
- PENDANT LUMINAIRE TUNGSTEN HALOGEN E27 PHILIPS ECOCLOUD GLOBO DIMMABLE
- SURFACE MOUNTED DECORATIVE ALUMINUM REFLECTOR FLUORESCENT LIGHTING FIXTURE IP20
- SURFACE MOUNTED DECORATIVE GLASS DOWNLIGHT IP20
- RECESSED CEILING LUMINARE LED GRH1 GU10 19W 230V WARM WHITE CT270K DIMMABLE
- RECESSED CEILING LUMINARE, ADJUSTABLE LED GRH1 GU10 20W 230V WARM WHITE CT270K DIMMABLE
- MOTION SENSORS
- DIMMER
- SURFACE MOUNTED ONE WAY ONE GANG SWITCH IP44
- SURFACE MOUNTED ONE WAY ONE GANG SWITCH IP44
- SURFACE MOUNTED ONE WAY TWO GANG SWITCH IP50
- SURFACE MOUNTED ONE WAY THREE GANG SWITCH IP50
- CHANGING LEVEL OF MOUNTING

ABBREVIATIONS:

- AD - ADJUSTABLE SPOTLIGHT
- AJ - ADJUSTABLE SPOTLIGHT FOR CORRIDORS
- A1 - DOWNLIGHTS FOR RESTAURANT
- A2 - DOWNLIGHTS FOR BARS
- A3 - DOWNLIGHTS FOR LOBBY
- A4 - RECESSED LINEAR
- A5 - DOWNLIGHTS FOR COURTYARD

NOTES:

- EQUIPMENT AND WAY OF INSTALLATION MUST CONFIRM TO THE GEORGIAN AND EUROPEAN STANDARDS AND RULES. ANY MODIFICATION OF EQUIPMENT MOUNTING OR CONNECTIONS IS PROHIBITED. IT IS ALLOWED TO USE SIMILAR OR HIGHER QUALITY MATERIALS THAN INDICATED IN THE DRAWING.
- ALL EQUIPMENT (PANELS, SWITCHES, ACTUATORS, WIRING, ETC.) MUST HAVE PERMANENT MARKING ACCORDING TO THE NUMBERING IN THE DRAWING.
- USE CABLE WITH COPPER WIRE IN PVC NON SPREADING FIRE INSULATION.
- TOP CONNECTION TO THE PANEL SHOULD BE ARRANGED.
- FOR LEGENDS AND DETAILS SEE LAYOUT GENERAL NOTES.
- SHELL AND CORE ACCORDING TO DRAWINGS PROVIDED BY CLIENT AND ON-SITE MEASUREMENTS.
- ALL MEASUREMENTS TO BE CHECKED ON SITE PRIOR TO PROCEEDING

DOCUMENT REVIEW STATUS

- A REVIEWED Work may proceed
- B REVIEWED WITH COMMENTS Work may proceed subject to review and re-submit
- C OBJECTION Revise and re-submit. Work may not proceed
- D REJECTED
- E REVIEW NOT REQUIRED Work may proceed

REVISIONS

No	Date	Description	Drawn	Checked	Approved
T00	4/12/2015	TENDER DOCUMENTS SUBMISSION	I.S.	R.F.	A.S.

CLIENT

Silk Road Business Center LLC  
LEAD DESIGN ENTITY (LDE) APPROVED BY LDE  
**AECOM**

NAME SCALE PAPER SIZE  
NAME R.F. A.S.  
SCALE 1:100 A0

DRAWING STATUS

PHASE II  
TENDER DOCUMENTS

CONSULTANT / SUB-CONTRACTOR


DRAWN BY CHECKED BY APPROVED BY  
NAME I.S. NAME R.F. NAME A.S.  
DATE 30/12/2015 DATE 1/12/2015 DATE 2/12/2015

DRAWING TITLE  
Radisson Blu Telegraph Hotel  
Electrical  
Lighting Layout at Level L4

DRAWING NUMBER RBTH-AE-EL-TD-L4-0025  
REVISION T00

0 0.5 1 2 2.5m

DO NOT SCALE FROM THIS DRAWING

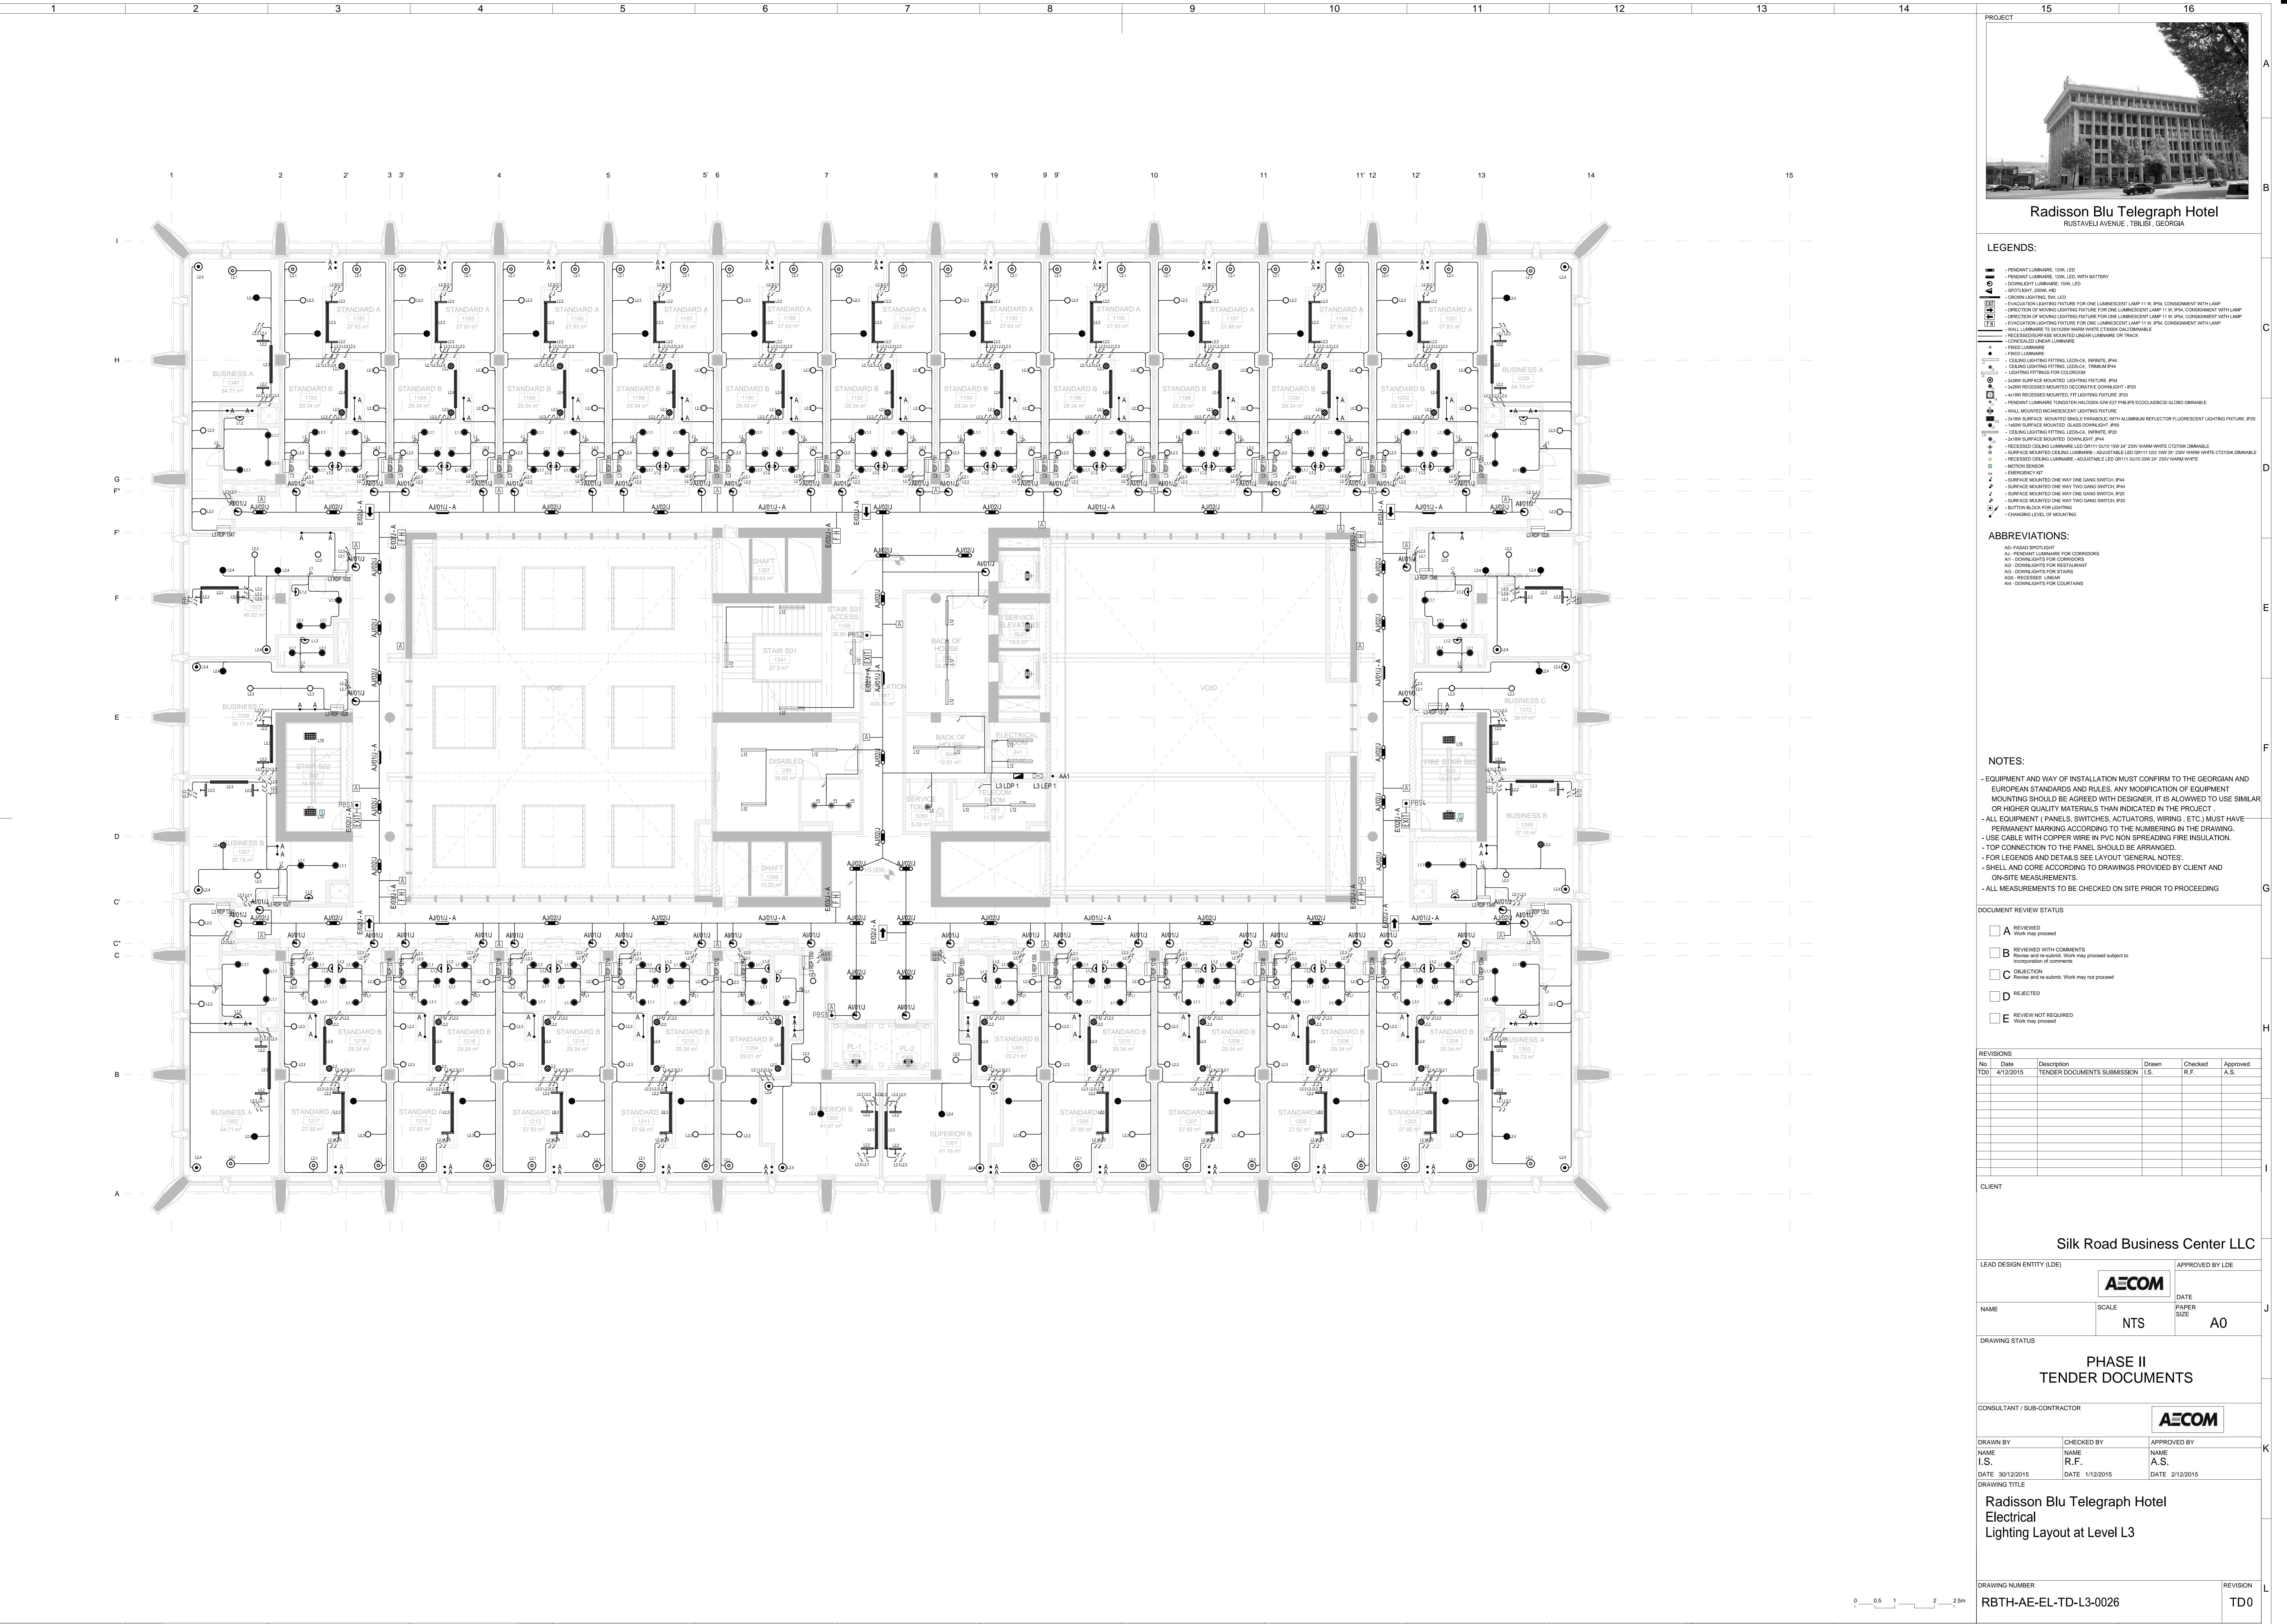


DO NOT SCALE FROM THIS DRAWING


Electronic drawings once printed, are uncontrolled and may become out-dated.


TIMESTAMP


K


L

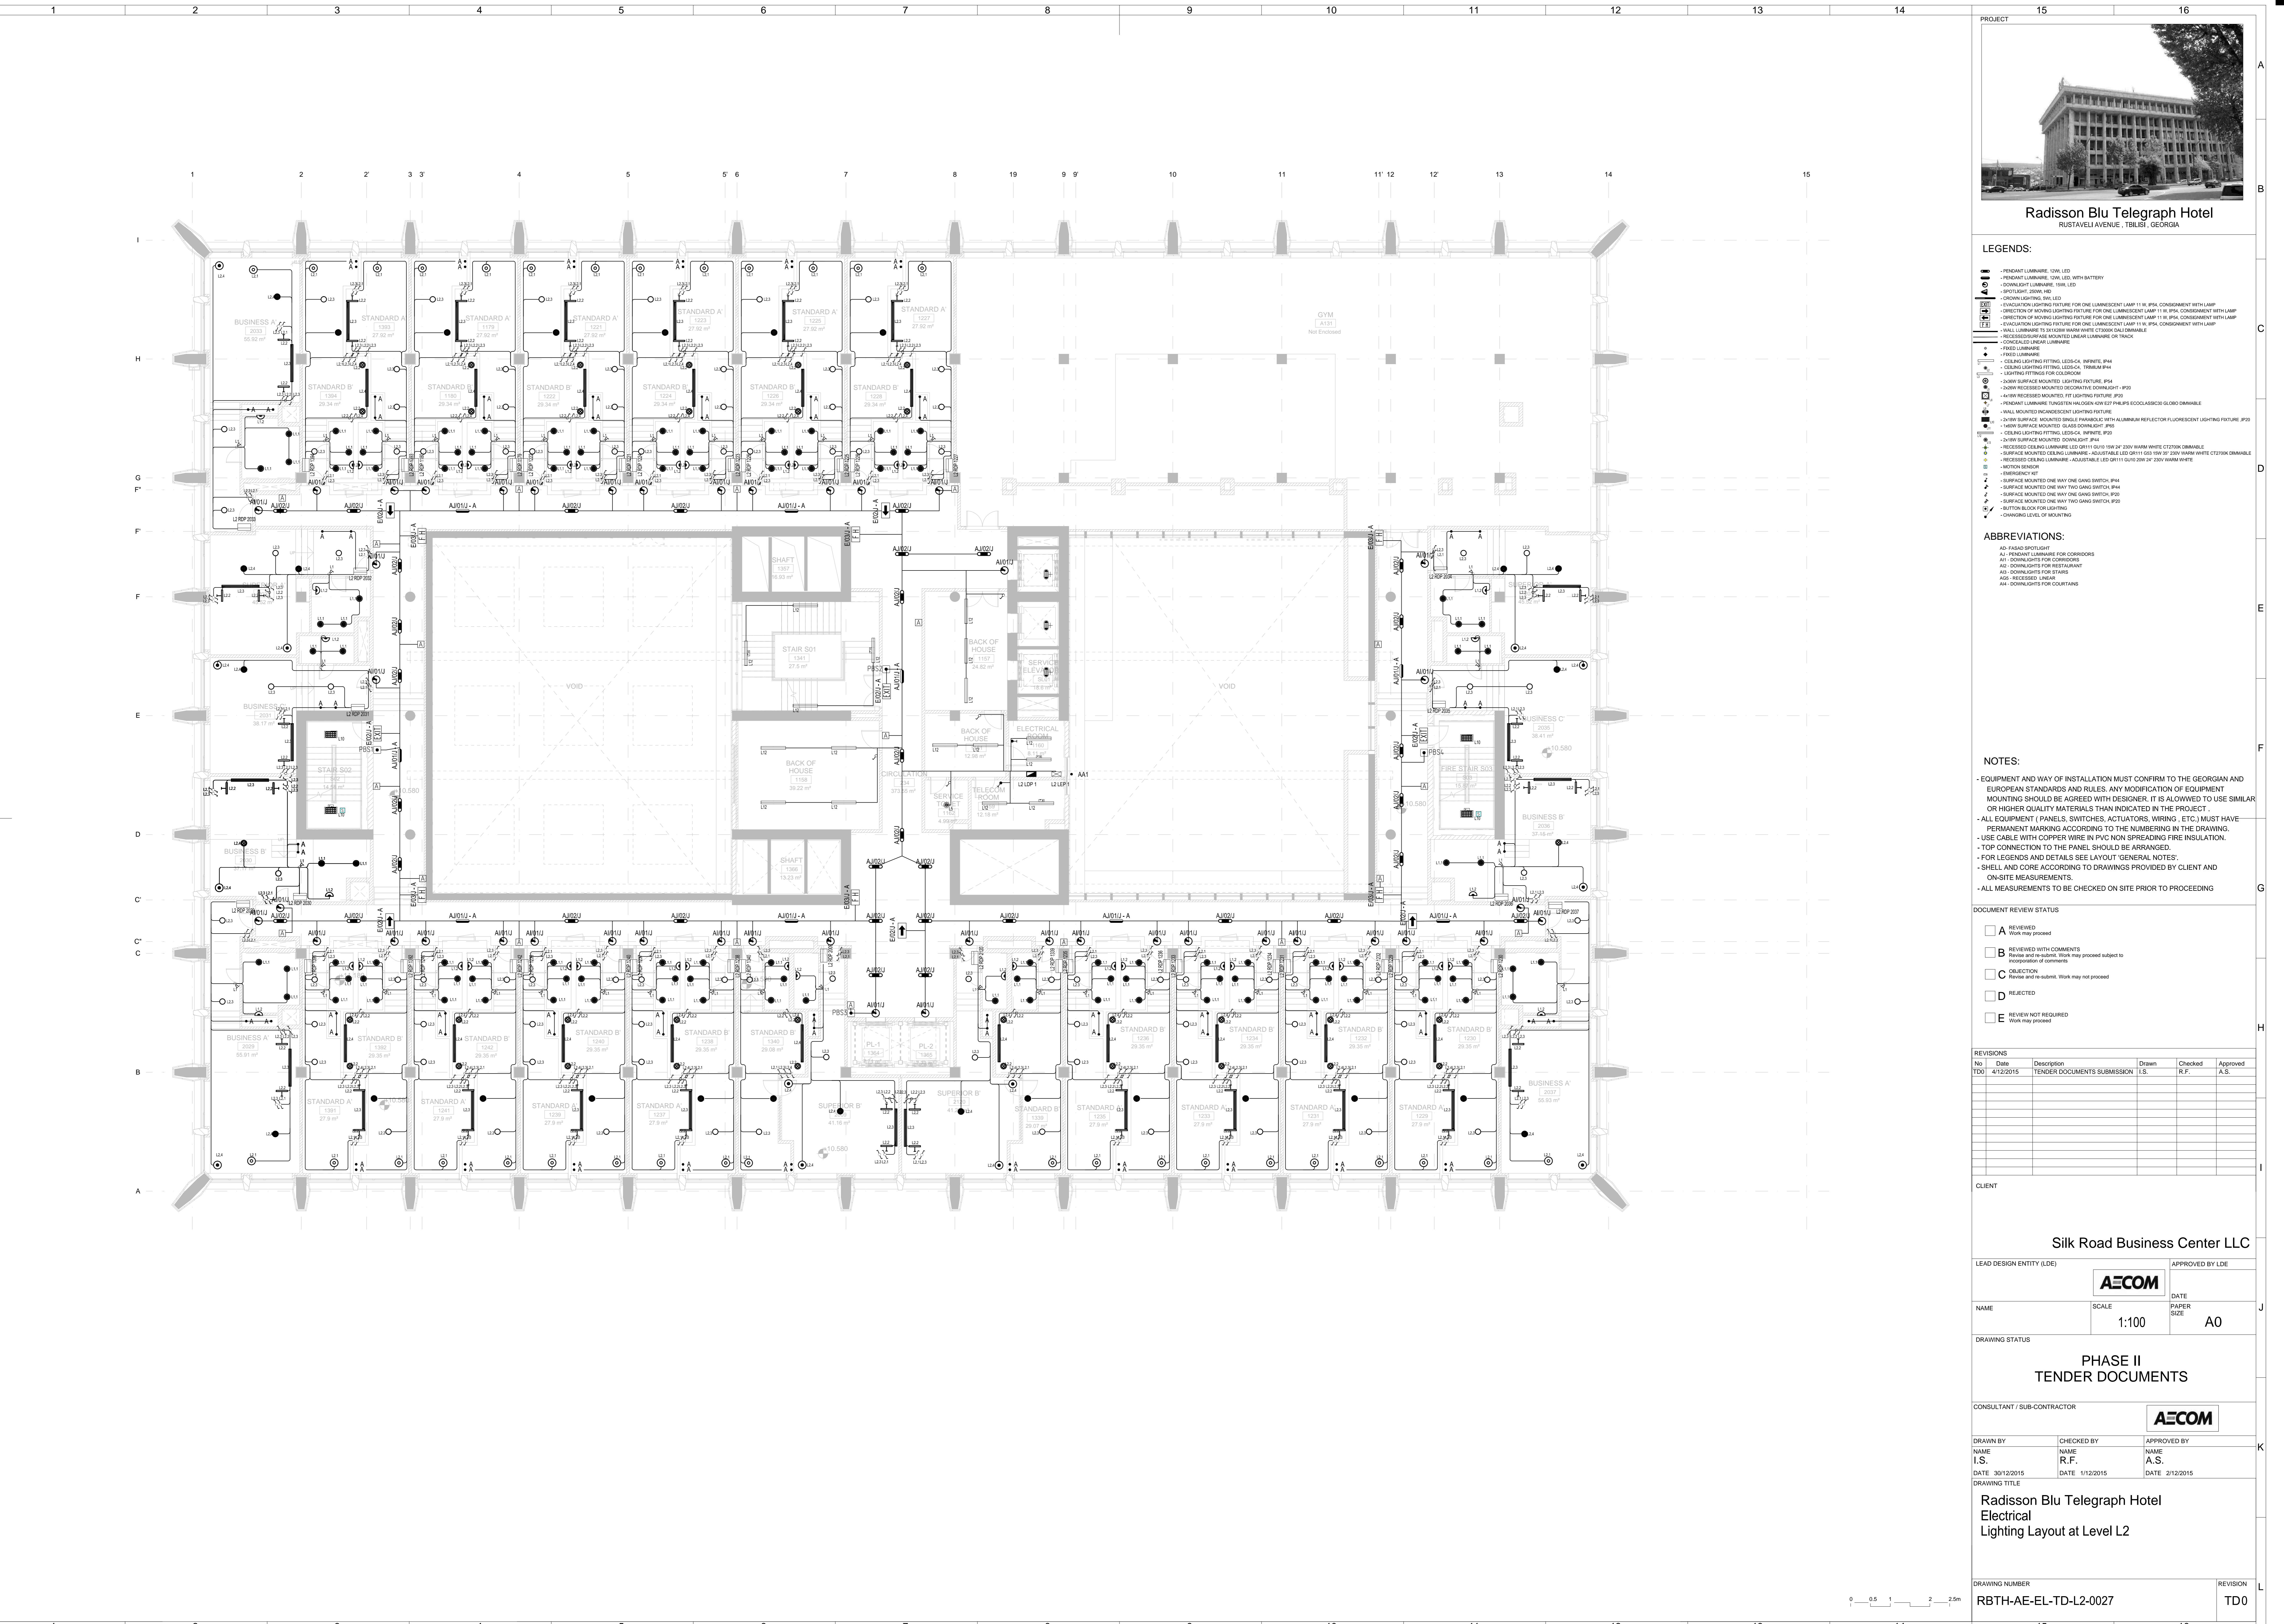


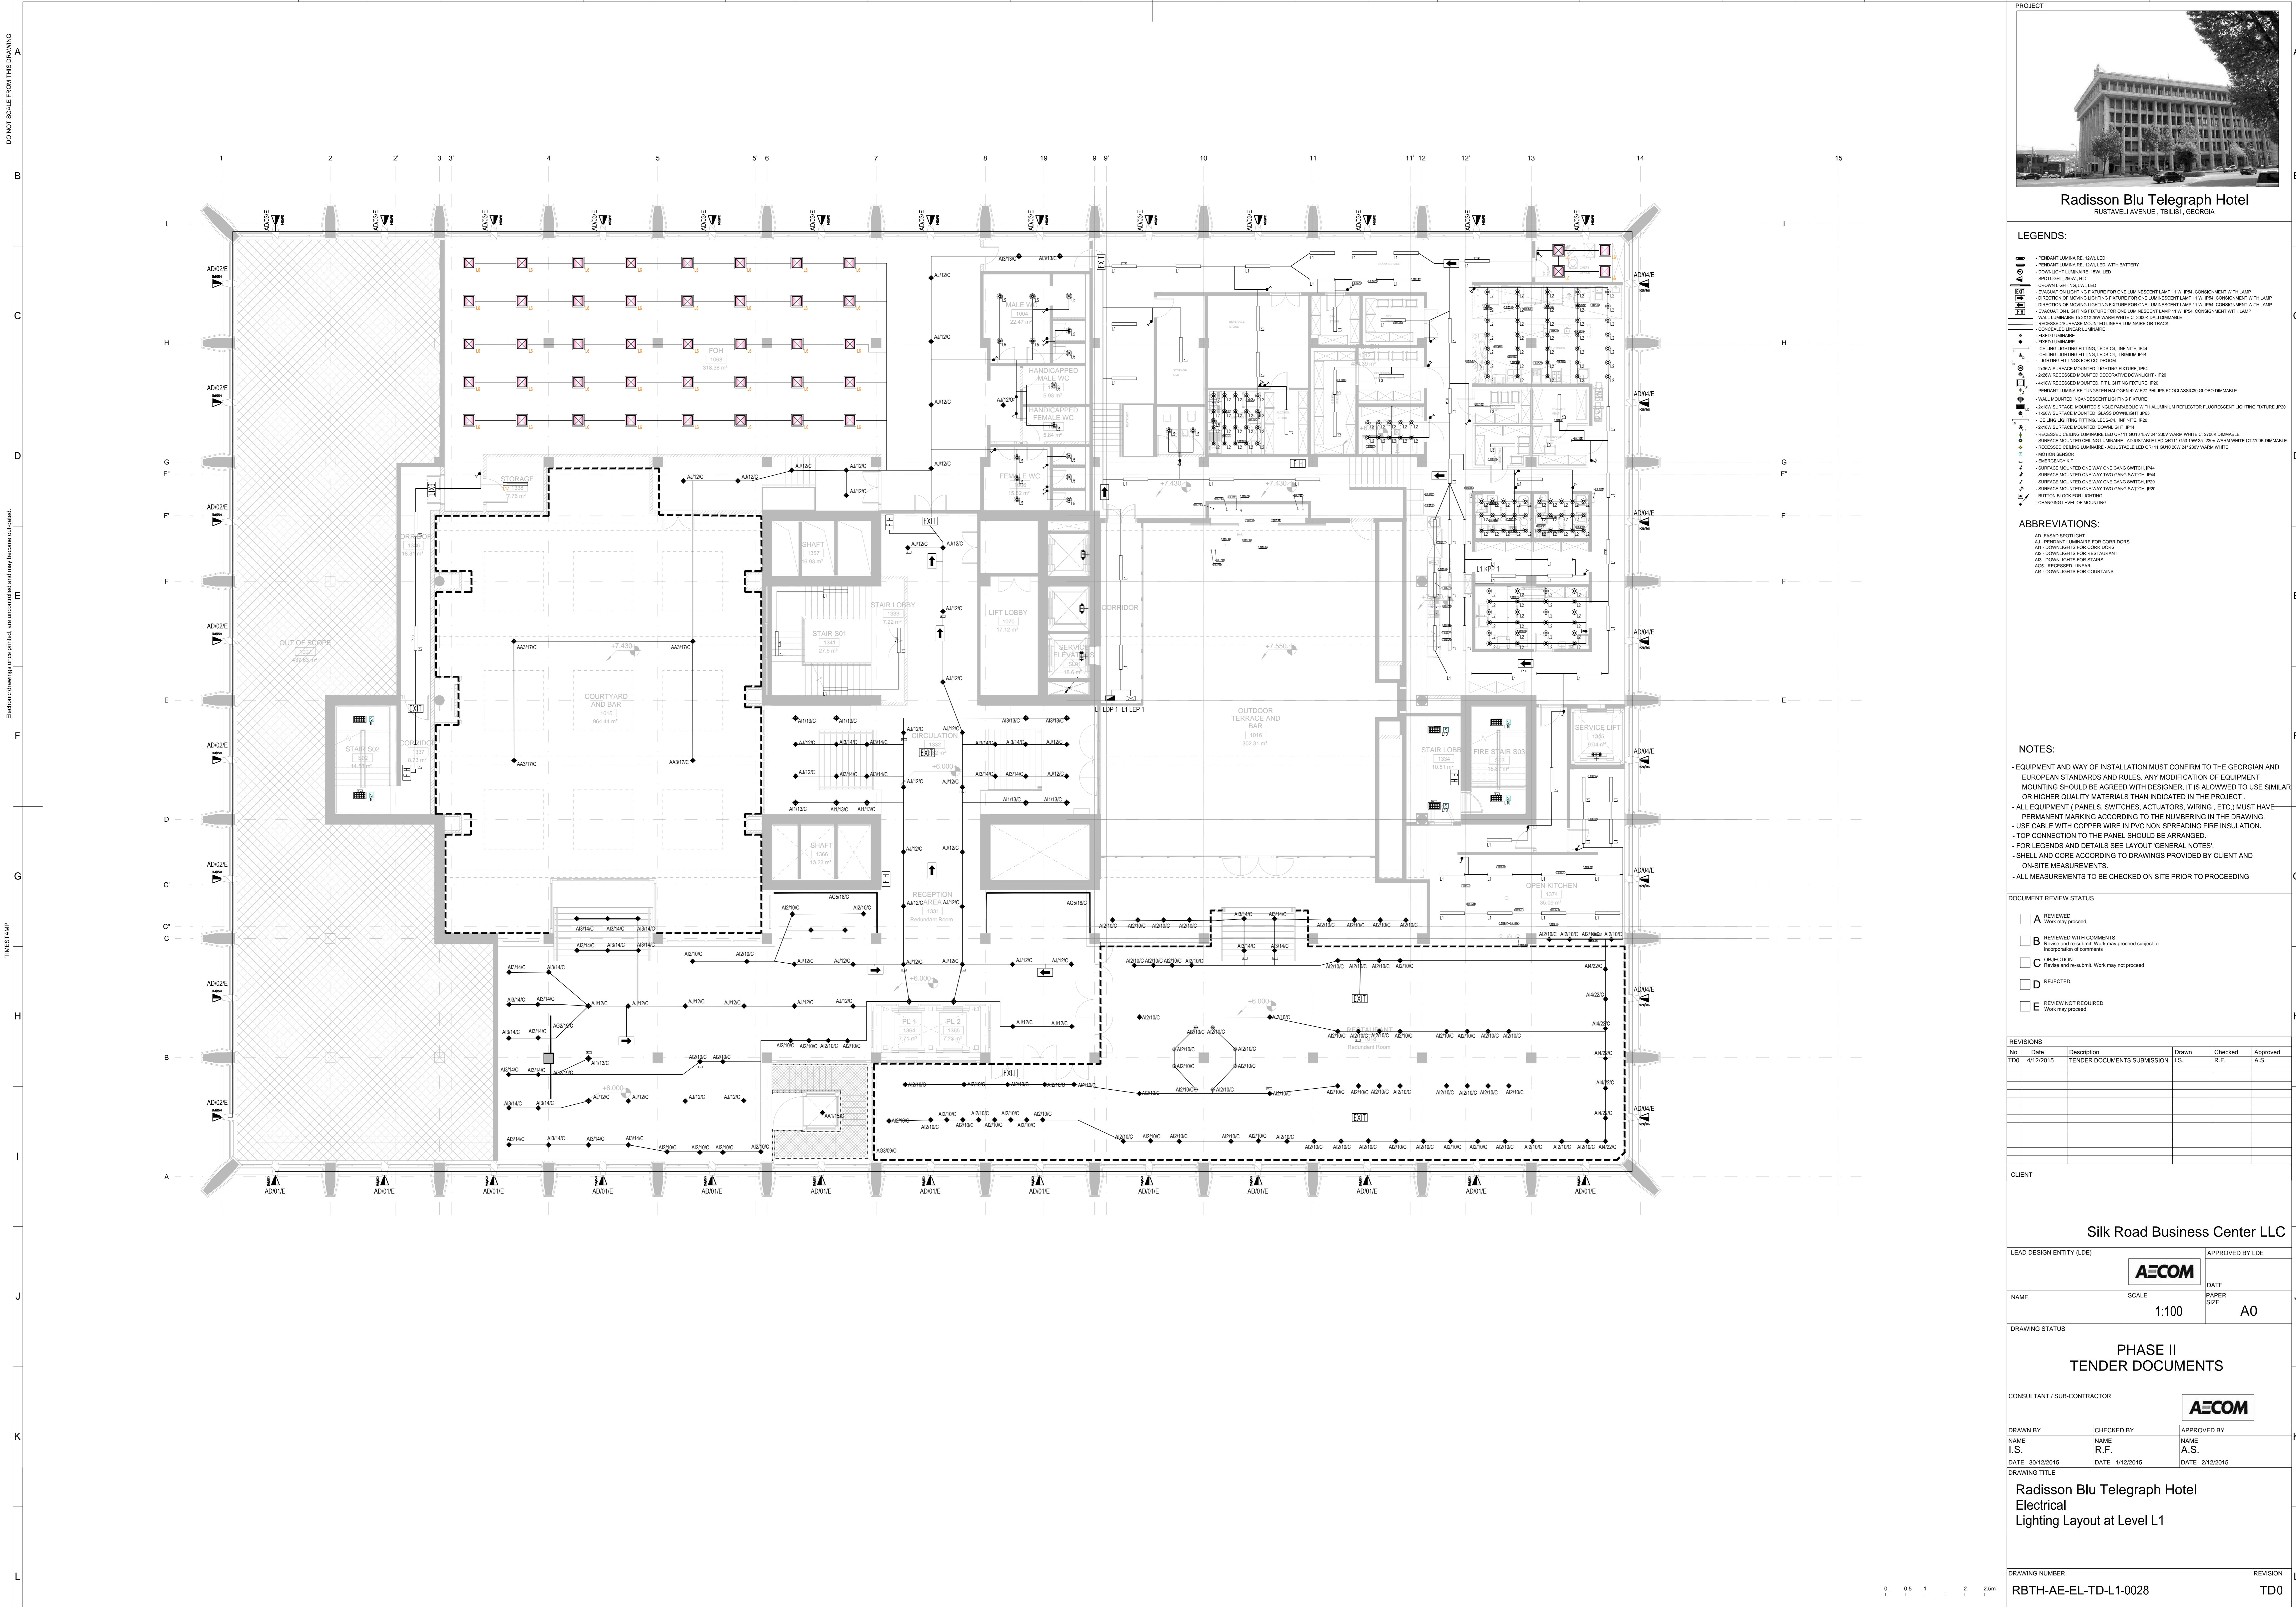


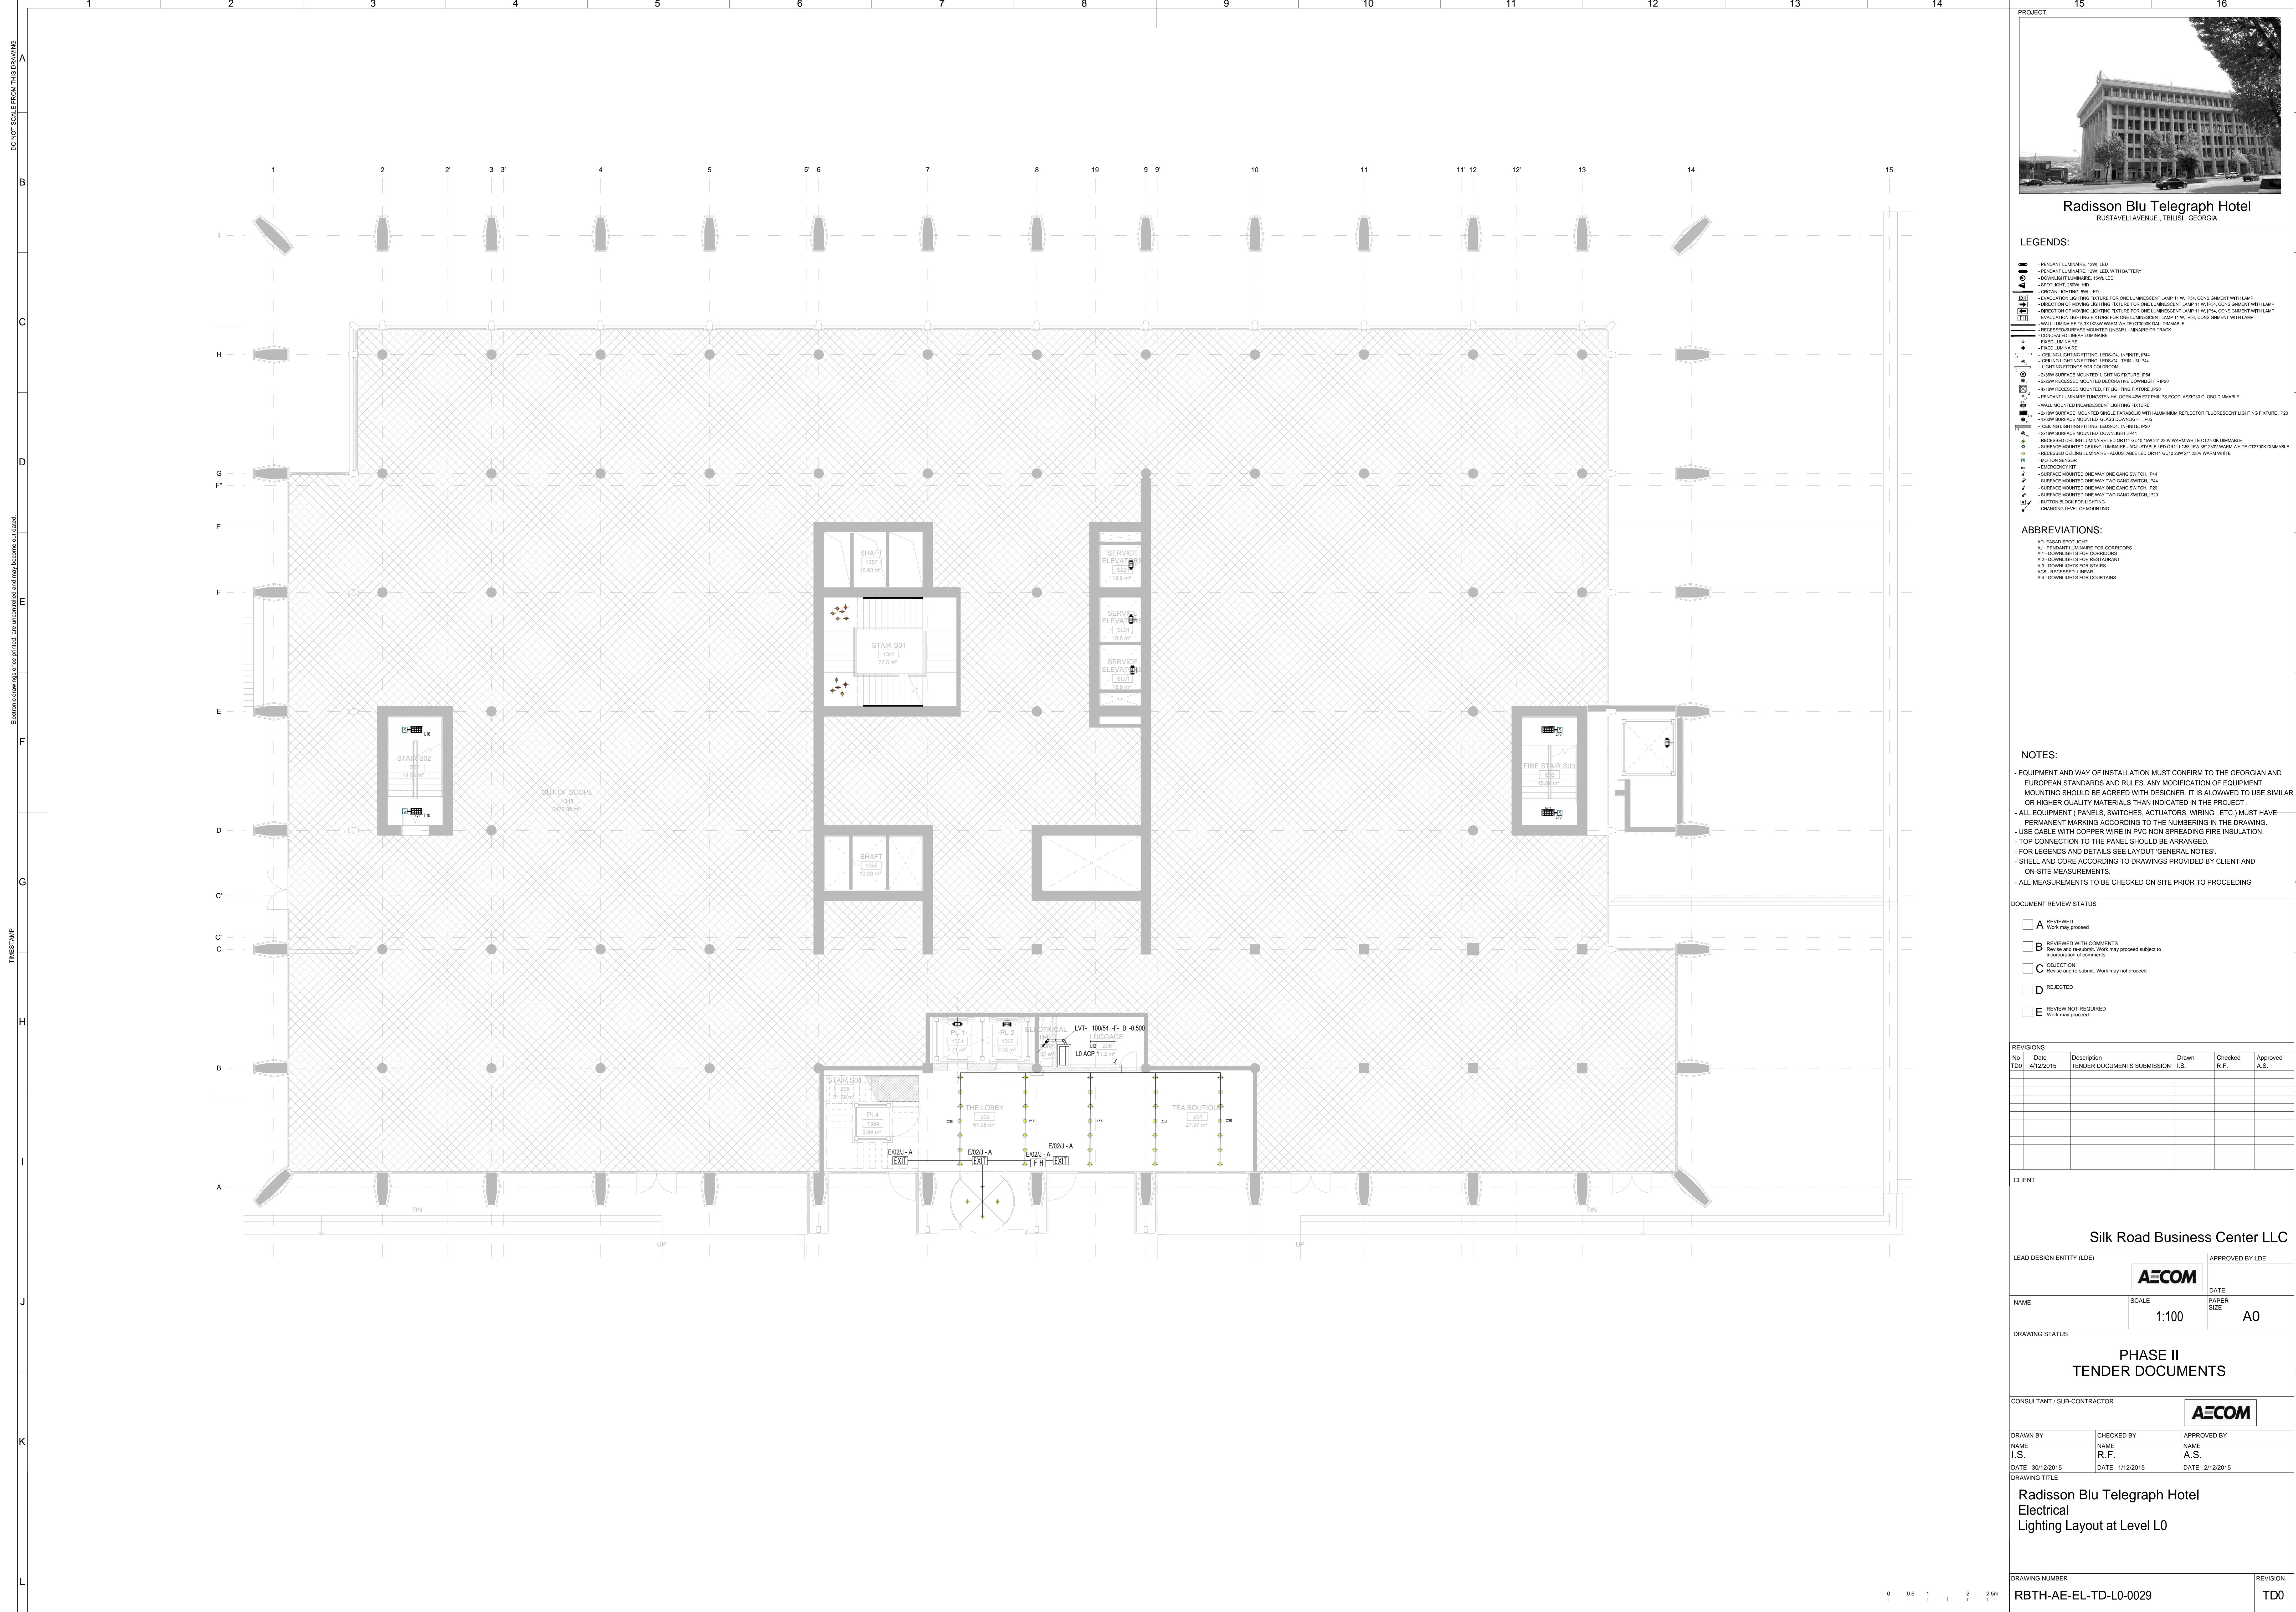


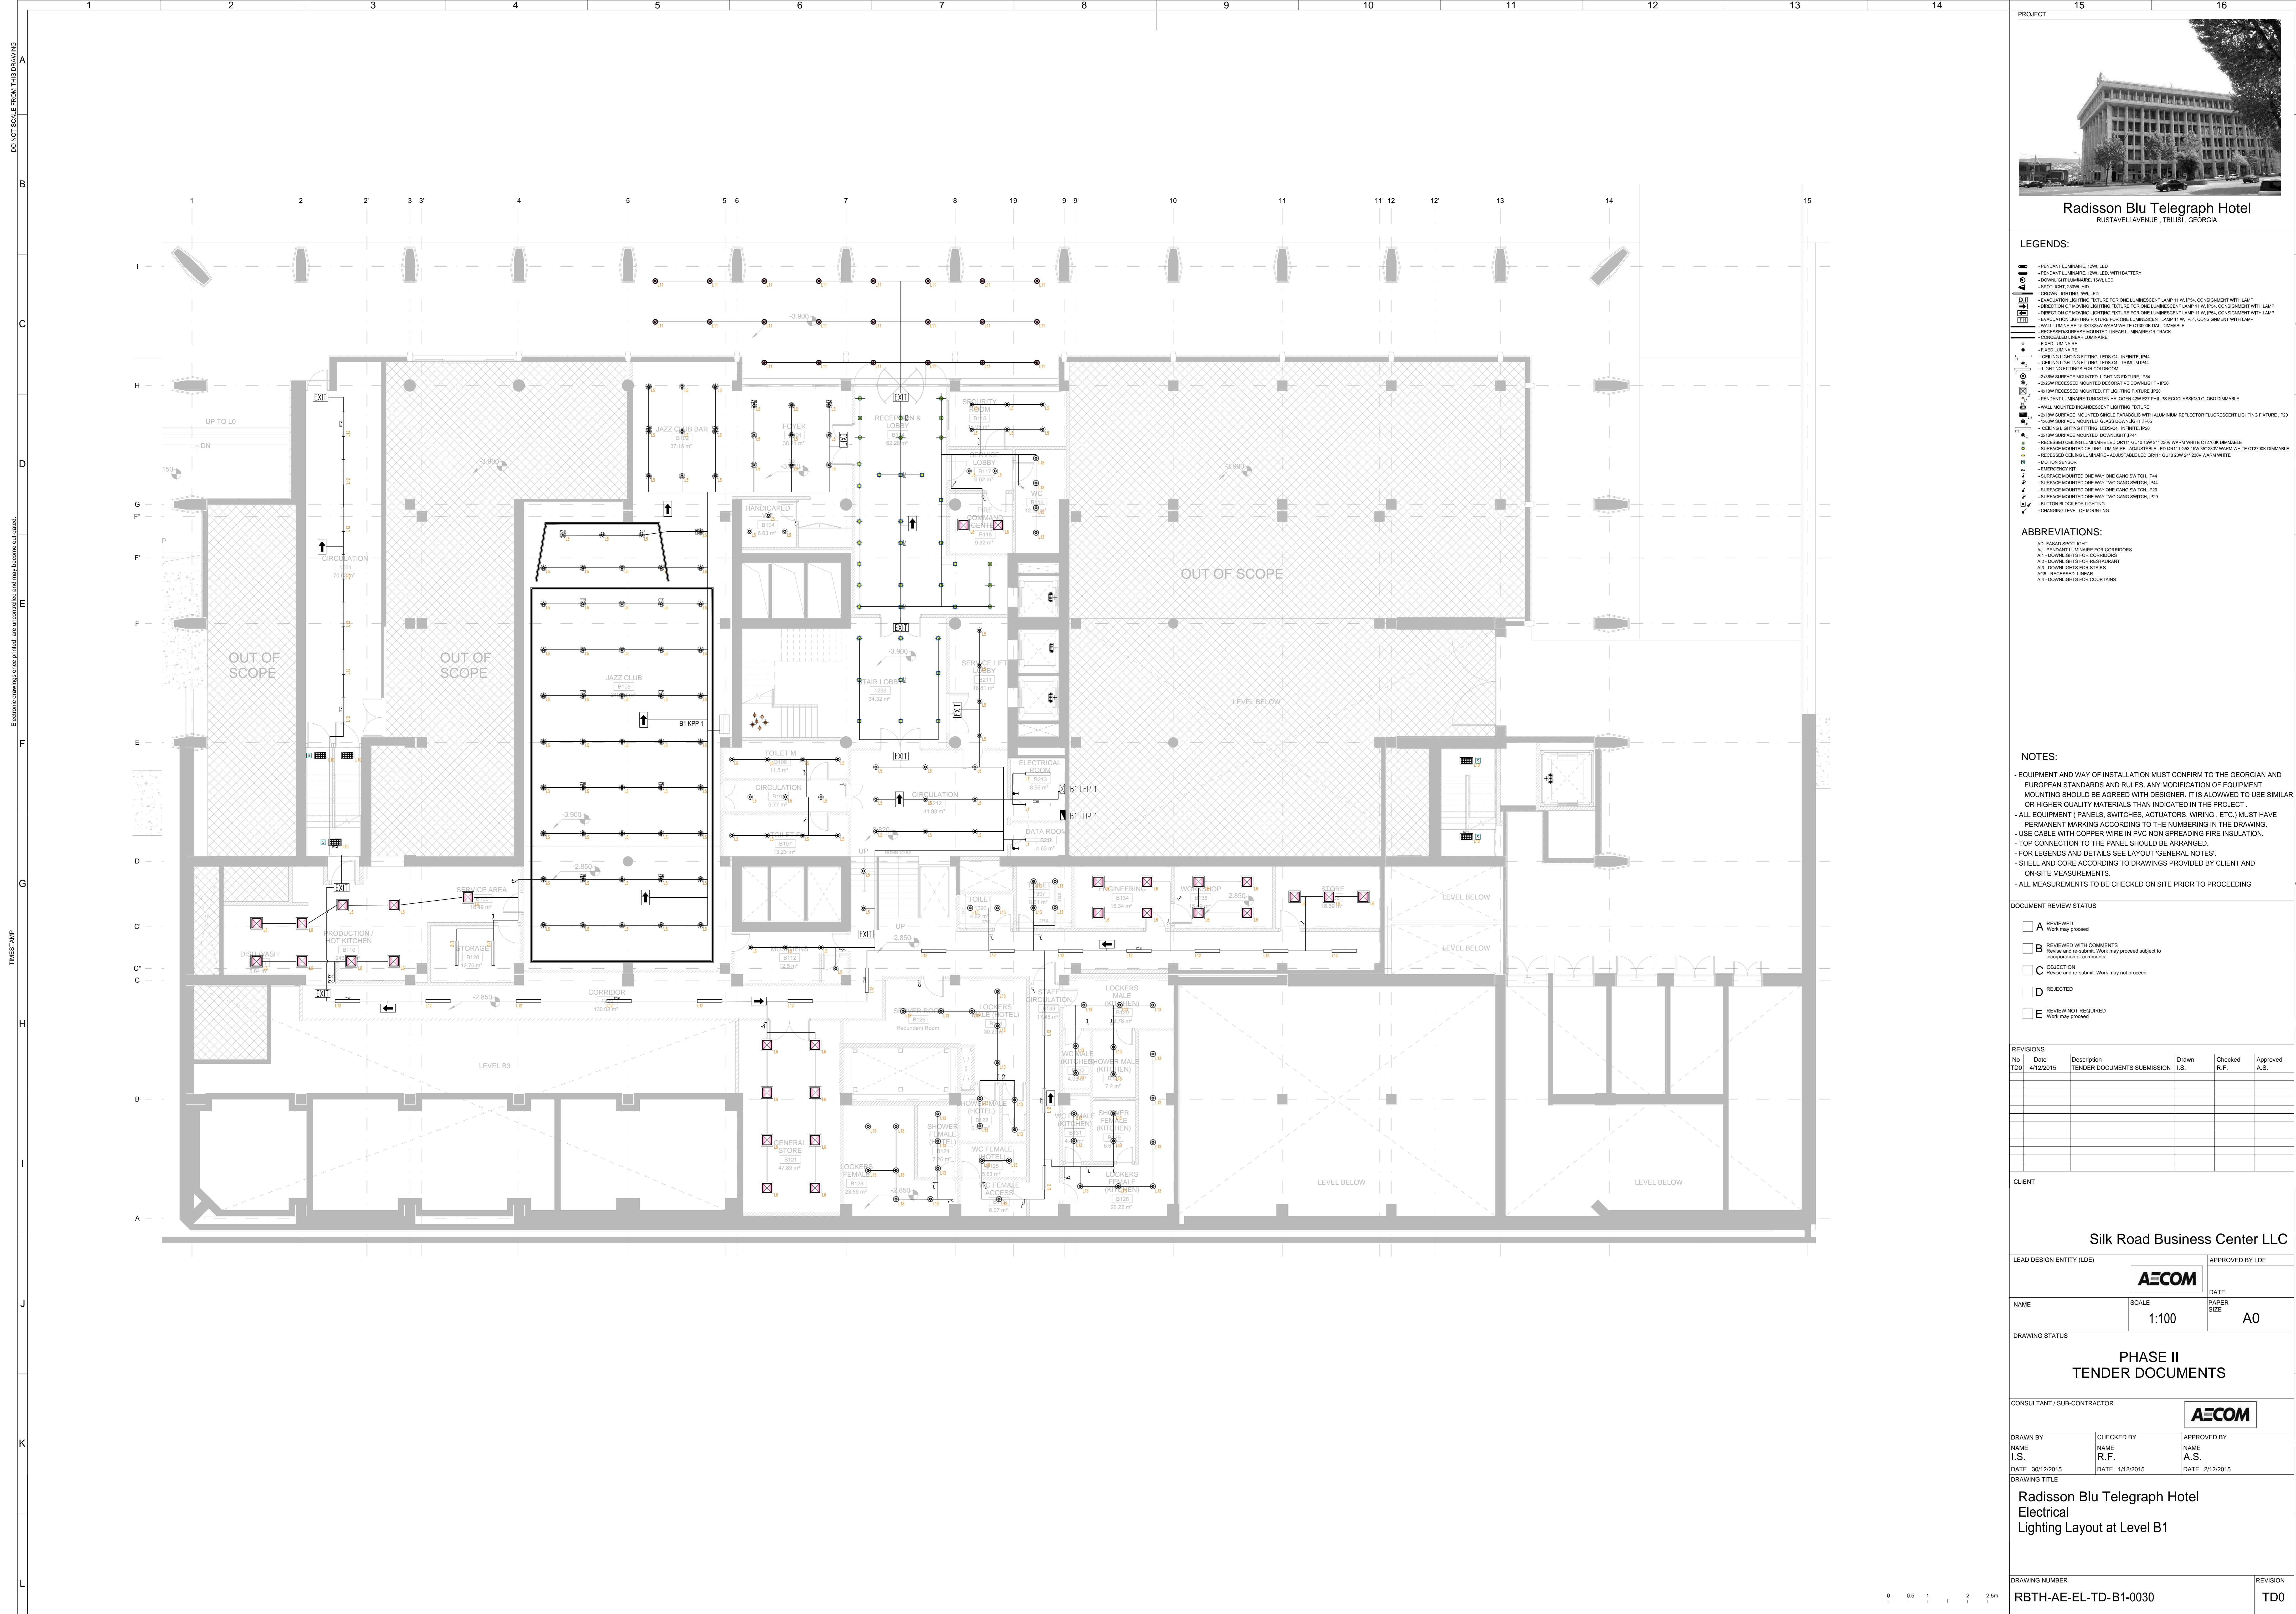

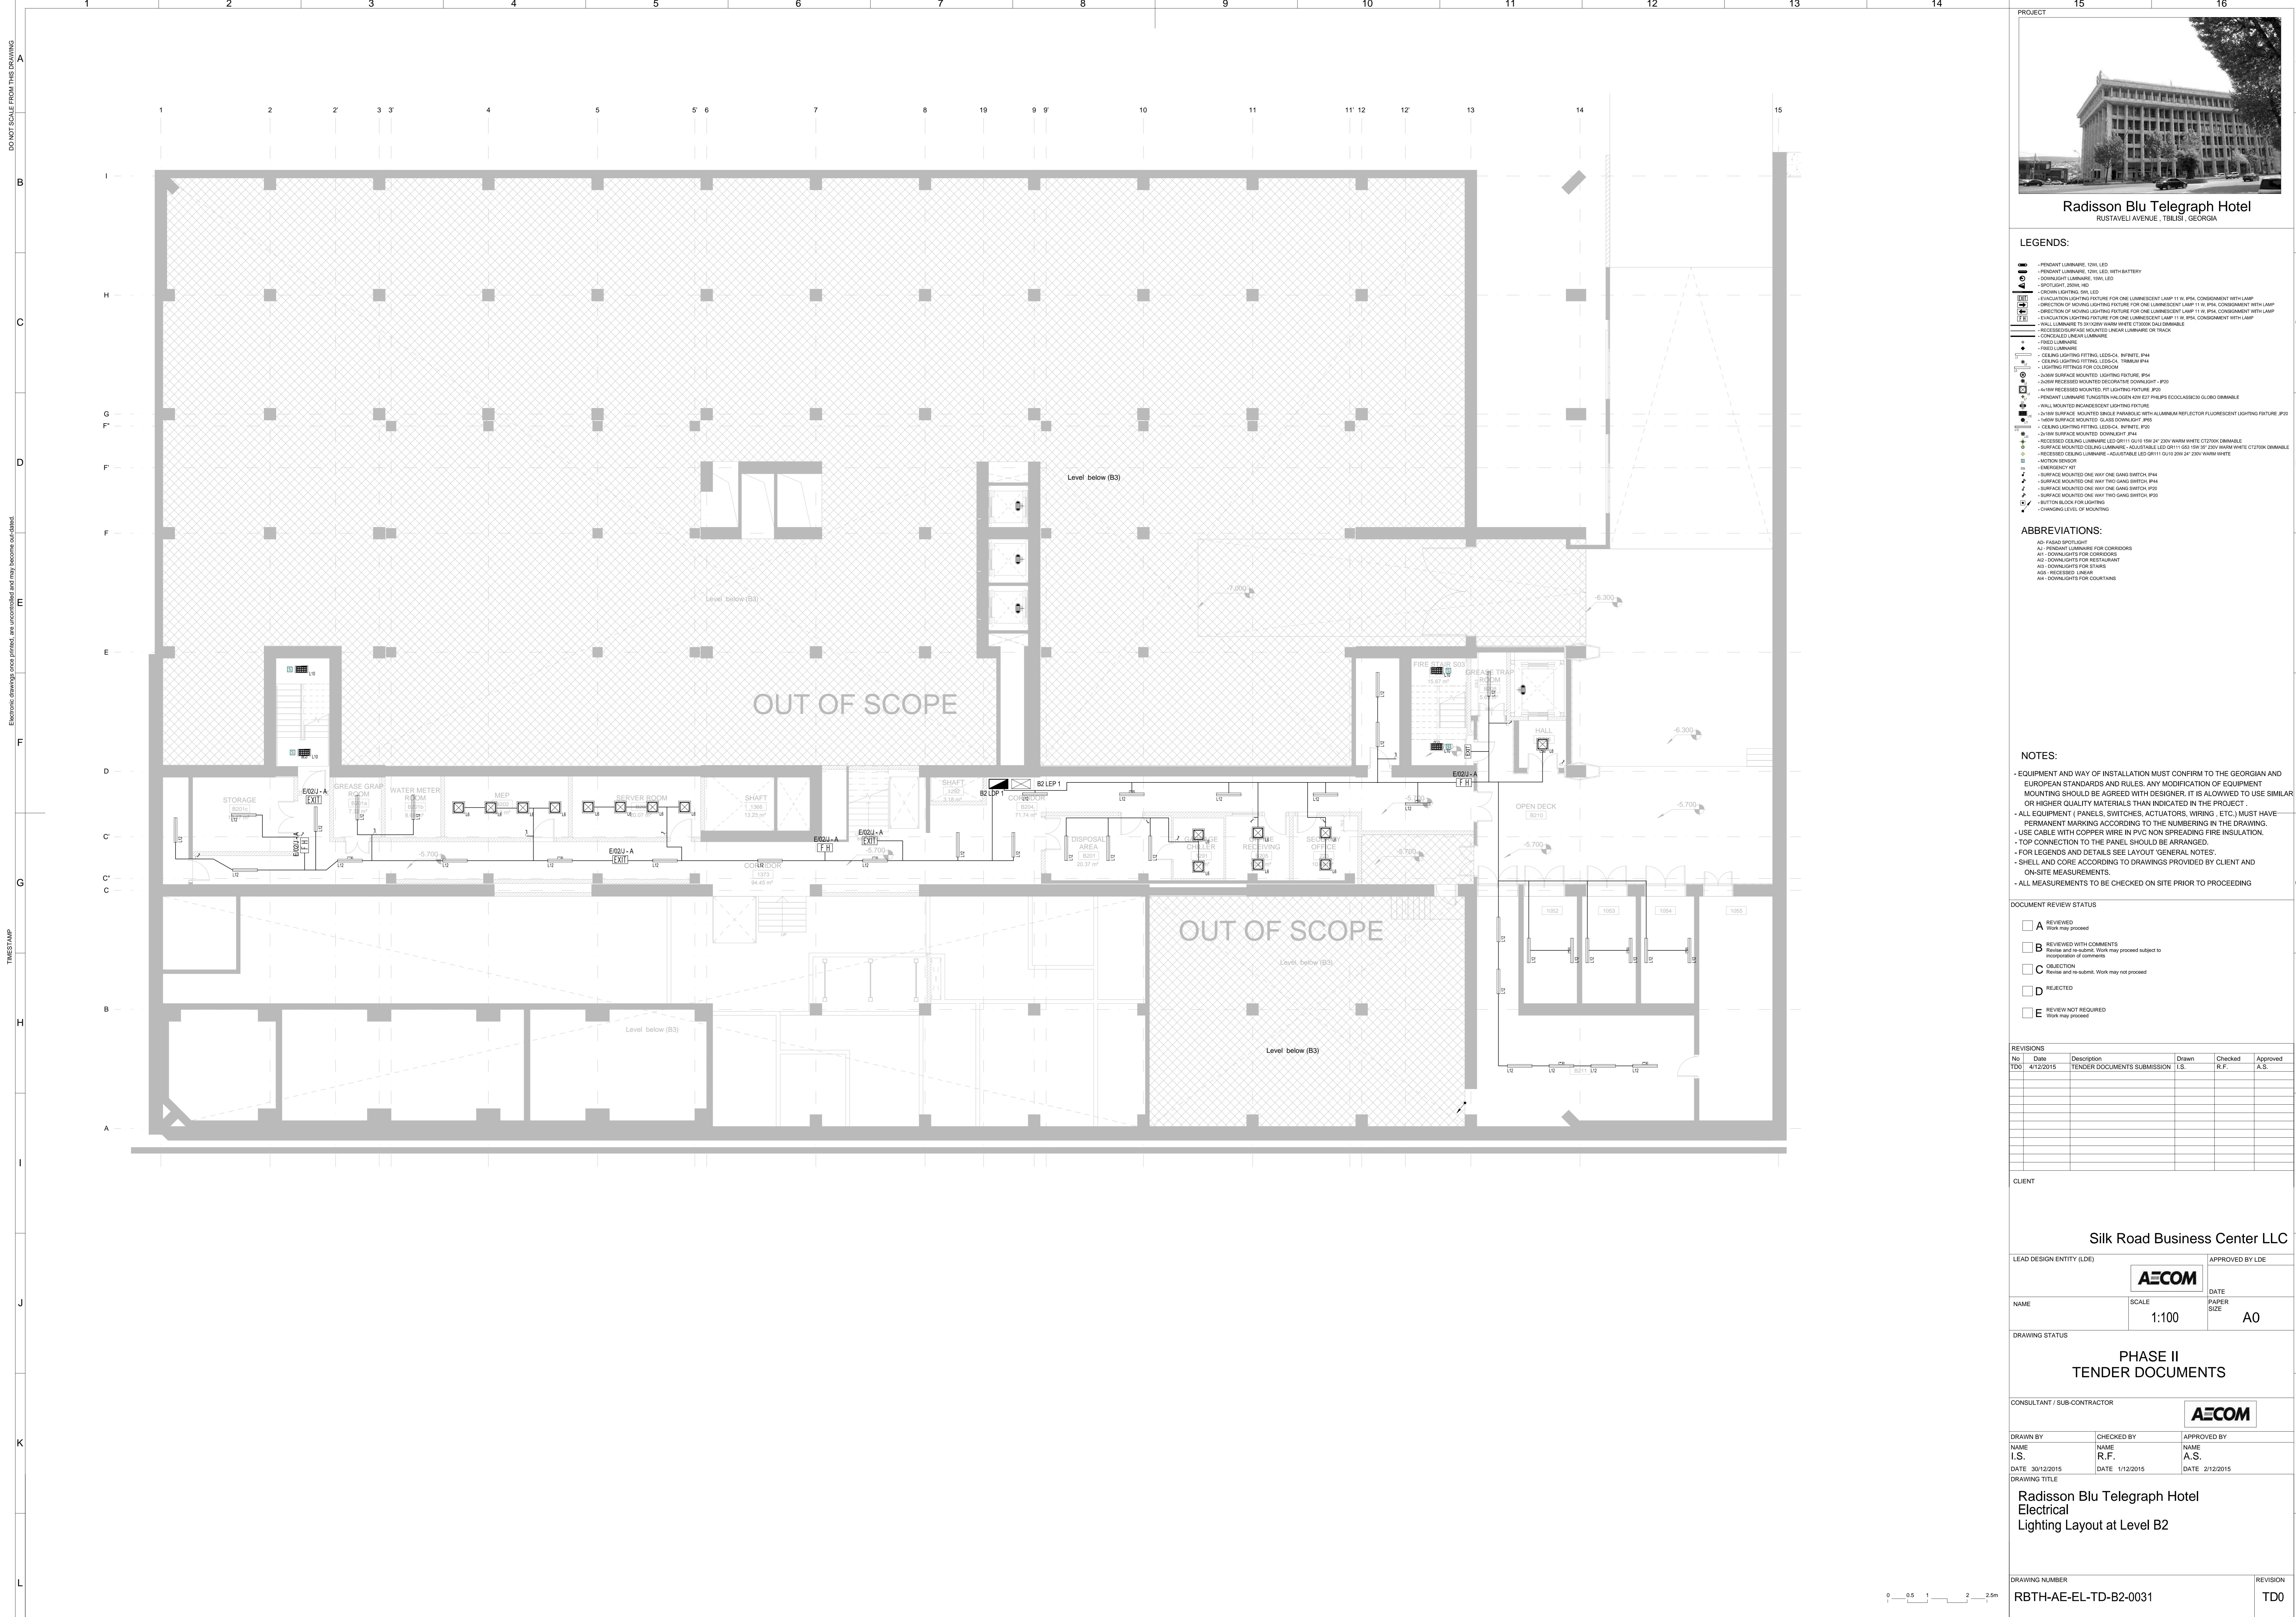

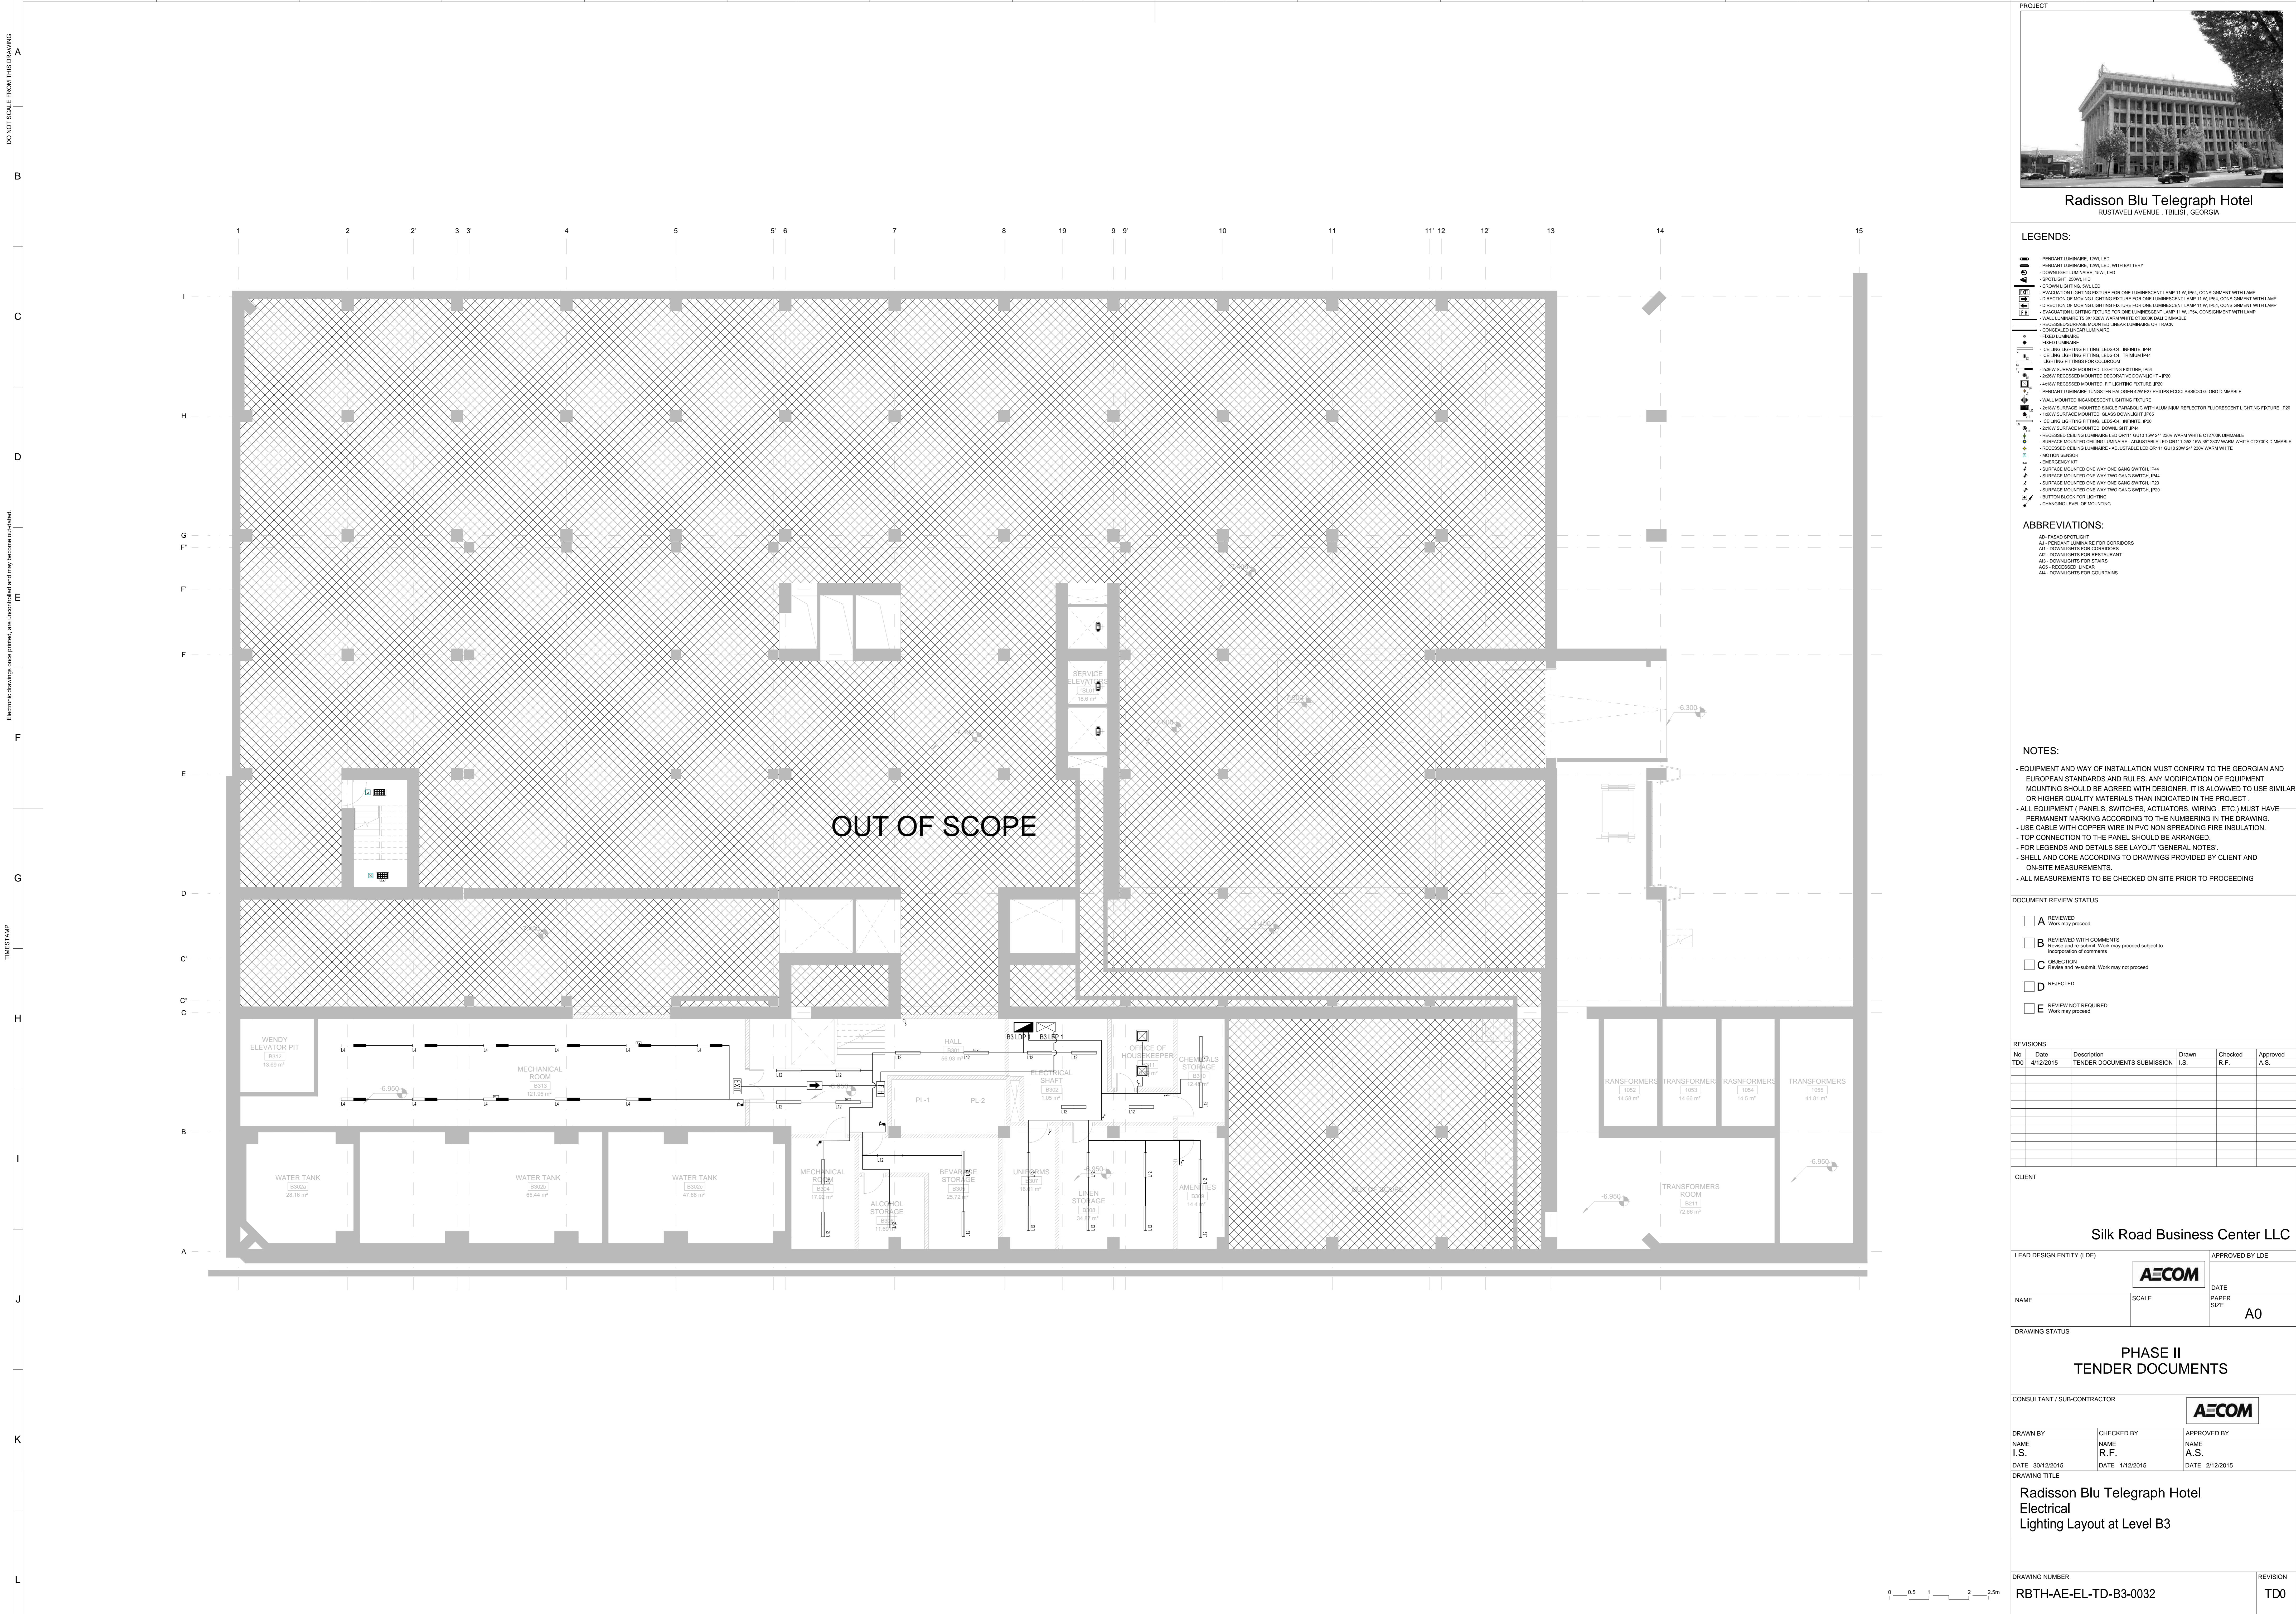


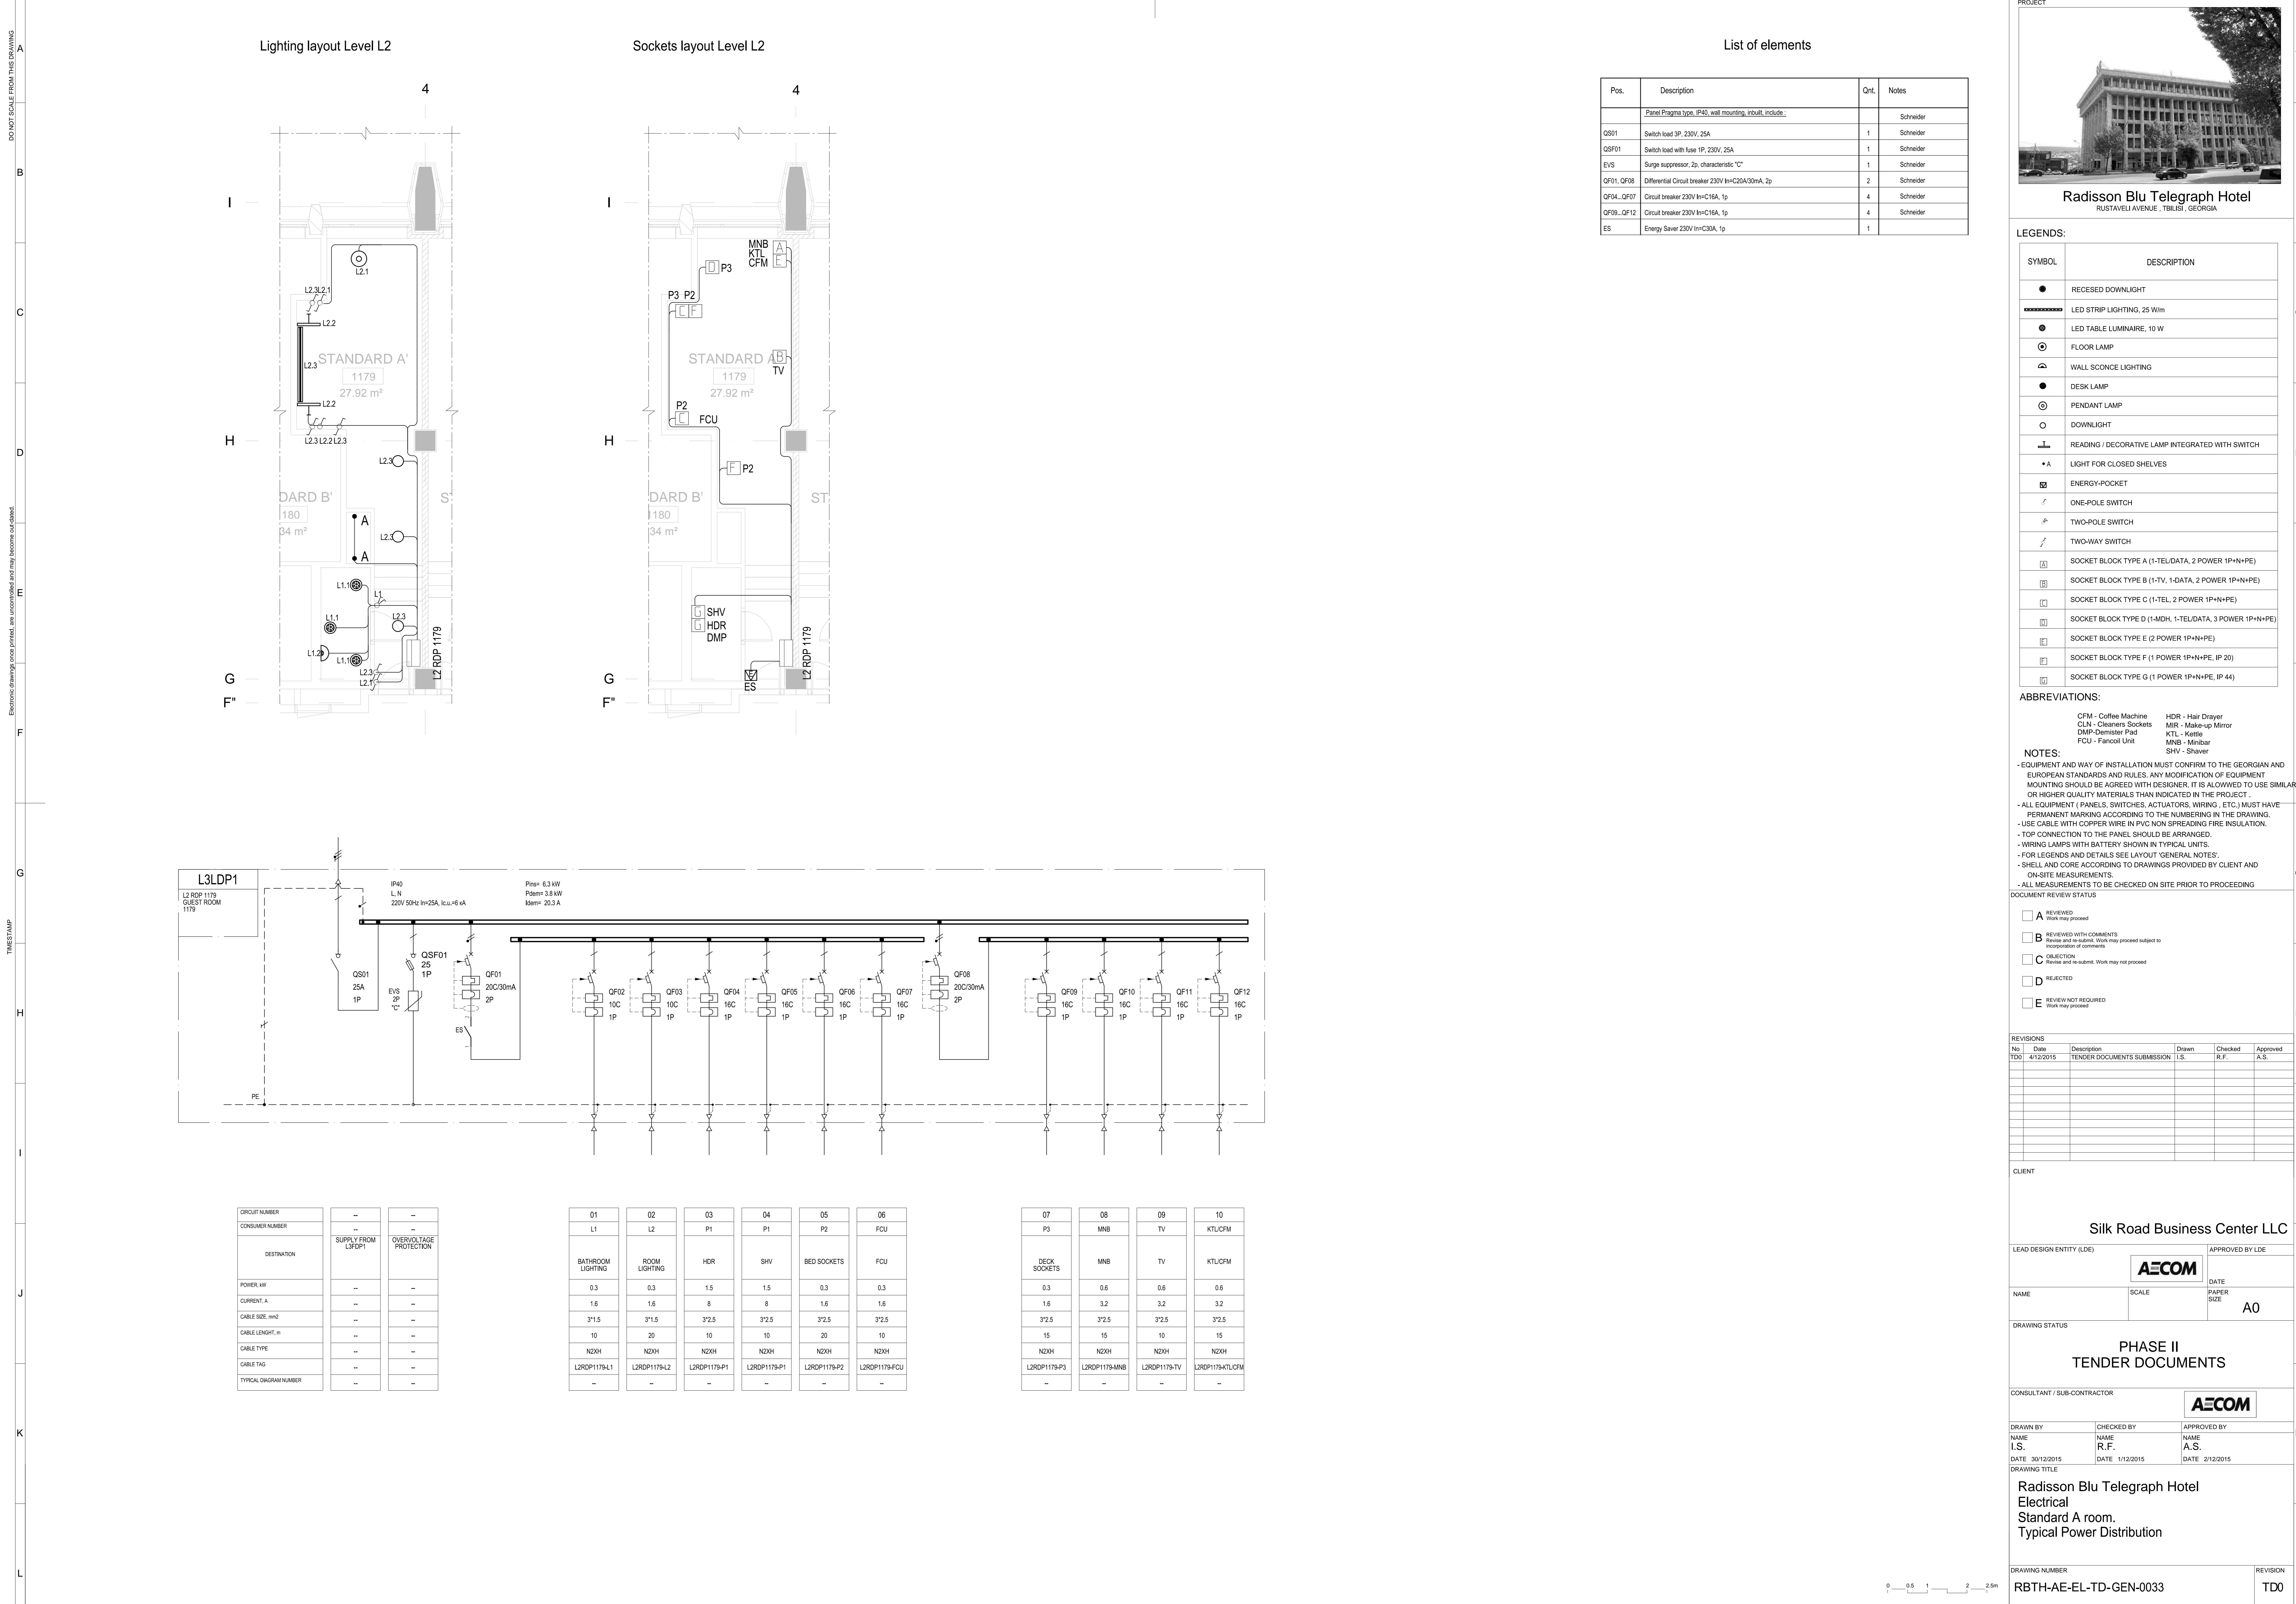

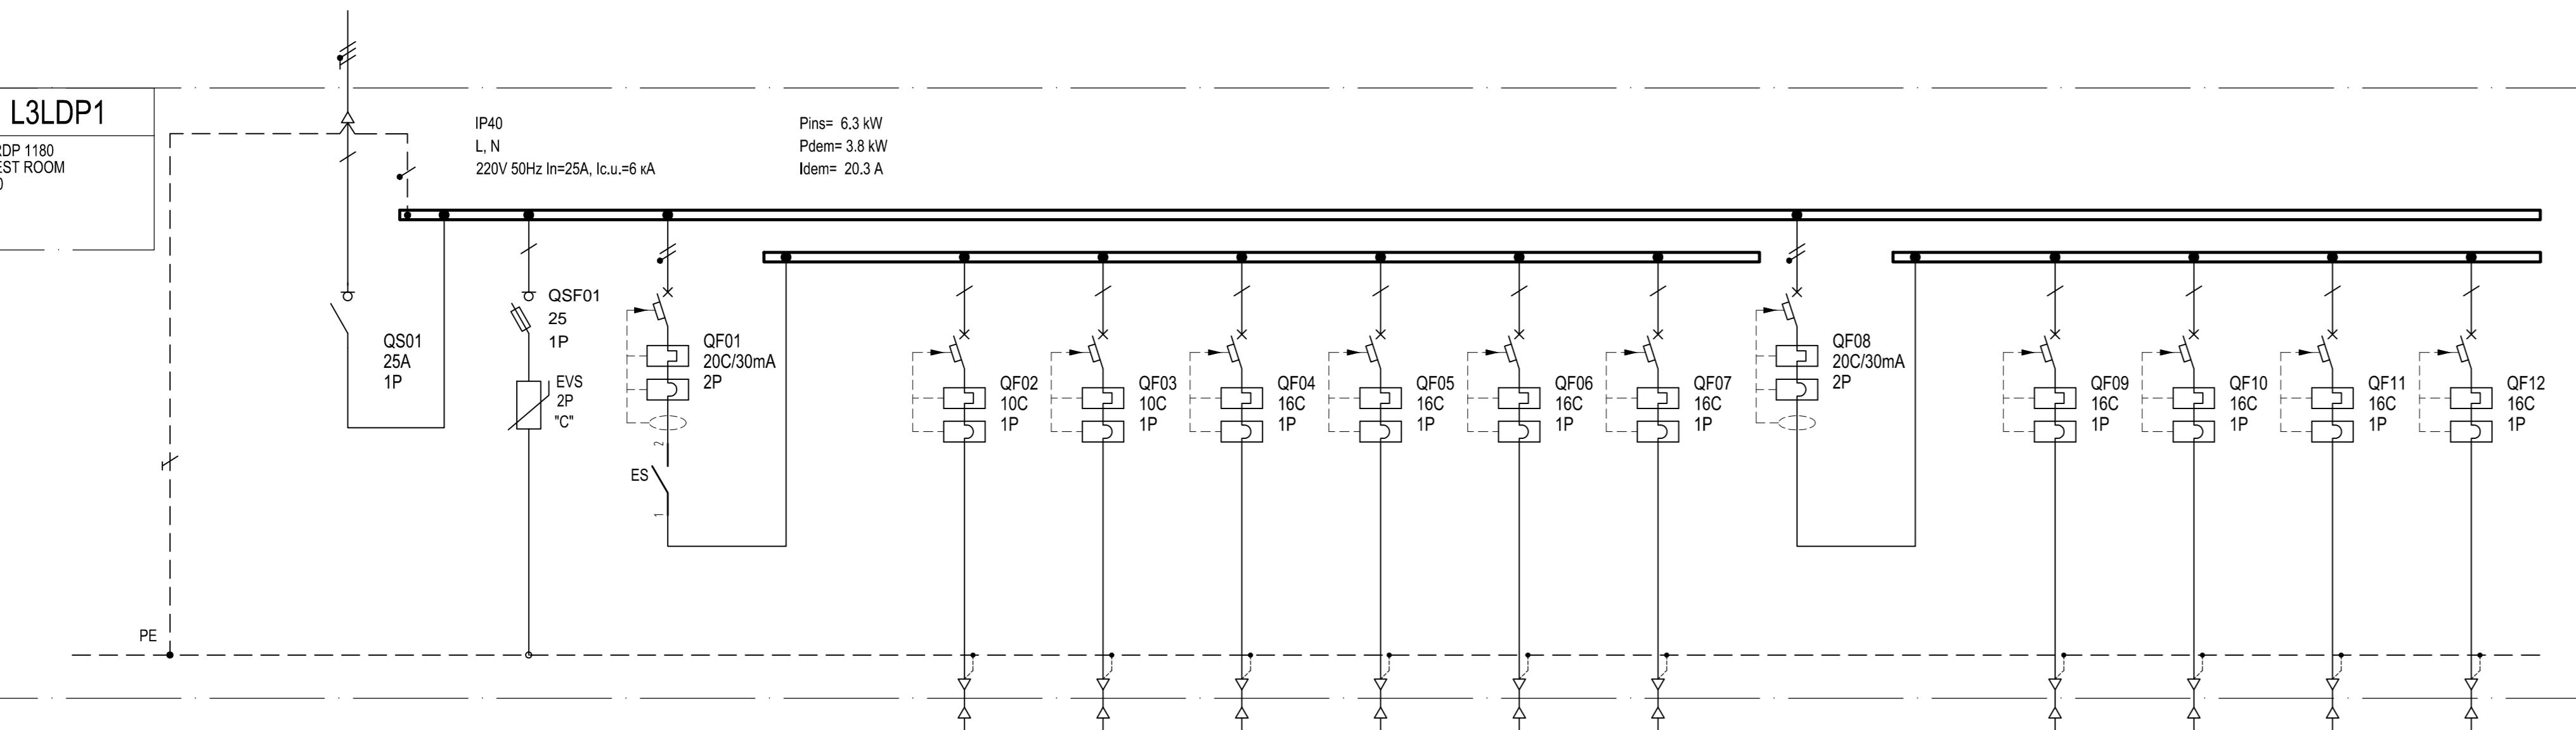

CIRCUIT NUMBER	CONSUMER NUMBER	—	—
—	—	—	—
—	—	—	—
01	02	03	04	05	06	07	08	09	10
L1	L2	P1	P1	P2	FCU	DECK SOCKETS	MNB	TV	KTL/CFM
BATHROOM LIGHTING	ROOM LIGHTING	HDR	SHV	BED SOCKETS	FCU	DECK SOCKETS	MNB	TV	KTL/CFM
0.3	0.3	1.5	0.3	0.3	0.3	0.3	0.6	0.6	0.6
1.6	1.6	8	8	1.6	1.6	1.6	3.2	3.2	3.2
31.5	31.5	32.5	32.5	32.5	32.5	32.5	32.5	32.5	32.5
10	20	10	10	20	10	15	10	15	15
NZXH	NZXH	NZXH	NZXH	NZXH	NZXH	NZXH	NZXH	NZXH	NZXH
L2RDP1180-A1	L2RDP1180-L2	L2RDP1180-P1	L2RDP1180-P2	L2RDP1180-FCU	L2RDP1180-P3	L2RDP1180-MNB	L2RDP1180-TV	L2RDP1180-KTL/CFM	—
—	—	—	—	—	—	—	—	—	—

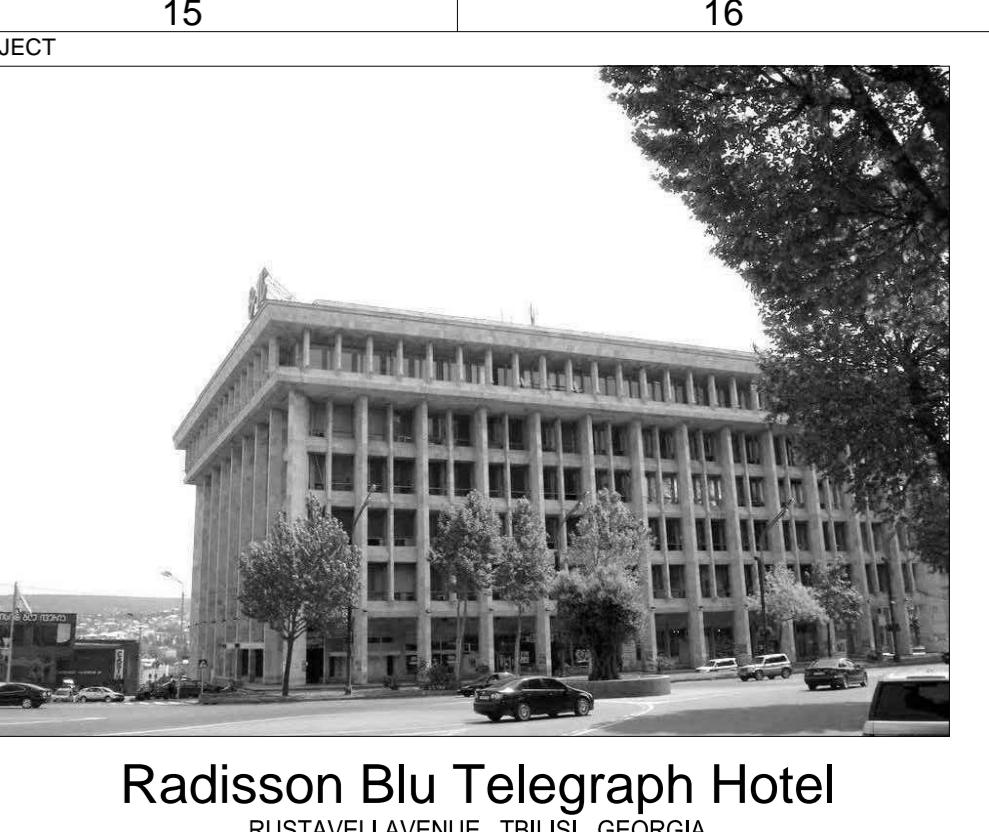

SYMBOL	DESCRIPTION
●	RECESSED DOWNLIGHT
=====	LED STRIP LIGHTING, 25 W/m
◎	LED TABLE LUMINAIRE, 10 W
○	FLOOR LAMP
△	WALL SCONCE LIGHTING
●	DESK LAMP
◎	PENDANT LAMP
○	DOWNLIGHT
—	READING L DECORATIVE LAMP INTEGRATED WITH SWITCH
• A	LIGHT FOR CLOSED SHELVES
☒	ENERGY-POCKET
□	ONE-POLE SWITCH
□	TWO-POLE SWITCH
□	TWO-WAY SWITCH
[A]	SOCKET BLOCK TYPE A (1-TEL/DATA, 2 POWER 1P+N+PE)
[B]	SOCKET BLOCK TYPE B (1-TV, 1-DATA, 2 POWER 1P+N+PE)
[C]	SOCKET BLOCK TYPE C (1-TEL, 2 POWER 1P+N+PE)
[D]	SOCKET BLOCK TYPE D (1-MDH, 1-TEL/DATA, 3 POWER 1P+N+PE)
[E]	SOCKET BLOCK TYPE E (2 POWER 1P+N+PE)
[F]	SOCKET BLOCK TYPE F (1 POWER 1P+N+PE, IP 20)
[G]	SOCKET BLOCK TYPE G (1 POWER 1P+N+PE, IP 44)

**ABBREVIATIONS:**

CFM - Coffee Machine HDR - Hair Dryer  
CLN - Cleaners CLN - Cleaners Sockets MIR - Make-up Mirror  
DMP - Demister Pad KTL - Kettle  
FCU - Fancoil Unit MNB - Minibar  
SHV - Shaver

**NOTES:**

- EQUIPMENT AND WAY OF INSTALLATION MUST CONFORM TO THE GEORGIAN AND EUROPEAN STANDARDS AND RULES. ANY MODIFICATION OF EQUIPMENT MOUNTING SHOULD BE AGREED WITH DESIGNER. IT IS ALLOWED TO USE SIMILAR OR EQUIVALENT EQUIPMENT AS THAT WHICH IS SHOWN IN THE DRAWINGS.
- ALL EQUIPMENT PANELS, SWITCHES, ACTUATORS, WIRES, ETC., MUST HAVE PERMANENT MARKING ACCORDING TO THE NUMBERING IN THE DRAWING.
- USE CABLE WITH COPPER WIRE IN PVC NON SPREADING FIRE INSULATION.
- TOP CONNECTION TO THE PANEL SHOULD BE ARRANGED.
- WIRING LAMPS WITH BATTERY SHOWN IN TYPICAL UNITS.
- FOR LEGENDS AND DETAILS SEE LAYOUT GENERAL NOTES.
- SHELL AND CORE ACCORDING TO DRAWINGS PROVIDED BY CLIENT AND ON-SITE MEASUREMENTS.
- ALL MEASUREMENTS TO BE CHECKED ON SITE PRIOR TO PROCEEDING.

DOCUMENT REVIEW STATUS				
<input type="checkbox"/> A	REVIEDED	Work may proceed		
<input type="checkbox"/> B	REVIEDED WITH COMMENTS	Review and re-submit. Work may proceed subject to comments.		
<input type="checkbox"/> C	OBJECTION	Objection and re-submit. Work may not proceed		
<input type="checkbox"/> D	REJECTED	Rejected. Work may not proceed		
<input type="checkbox"/> E	REVIEDED NOT REQUIRED	Review not required		

REVISIONS				
No	Date	Description	Drawn	Approved

T00	4/12/2015	TENDER DOCUMENTS SUBMISSION	I.S.	Checked R.F.	Approved A.S.
-----	-----------	-----------------------------	------	--------------	---------------

CLIENT	
--------	--

Silk Road Business Center LLC	
-------------------------------	--

LEAD DESIGN ENTITY (LDE)	APPROVED BY LDE
--------------------------	-----------------

AECOM	DATE
-------	------

NAME	SCALE
------	-------

PAPER SIZE	A0
------------	----

DRAWING STATUS	
----------------	--

PHASE II	
CONSULTANT / SUB-CONTRACTOR	AECOM

DRAWN BY	CHECKED BY	APPROVED BY
----------	------------	-------------

NAME	NAME
------	------

I.S.	R.F.	A.S.
------	------	------

DATE	2/12/2015
------	-----------

DRAWING TITLE	
---------------	--

Radisson Blu Telegraph Hotel	
------------------------------	--

Electrical	
------------	--


Standard B room.	
------------------	--


Typical Power Distribution	
----------------------------	--


DRAWING NUMBER	RBTH-AE-EL-TD-GEN-0034
----------------	------------------------


REVISION	L
----------	---

DRAWN	T00
-------	-----

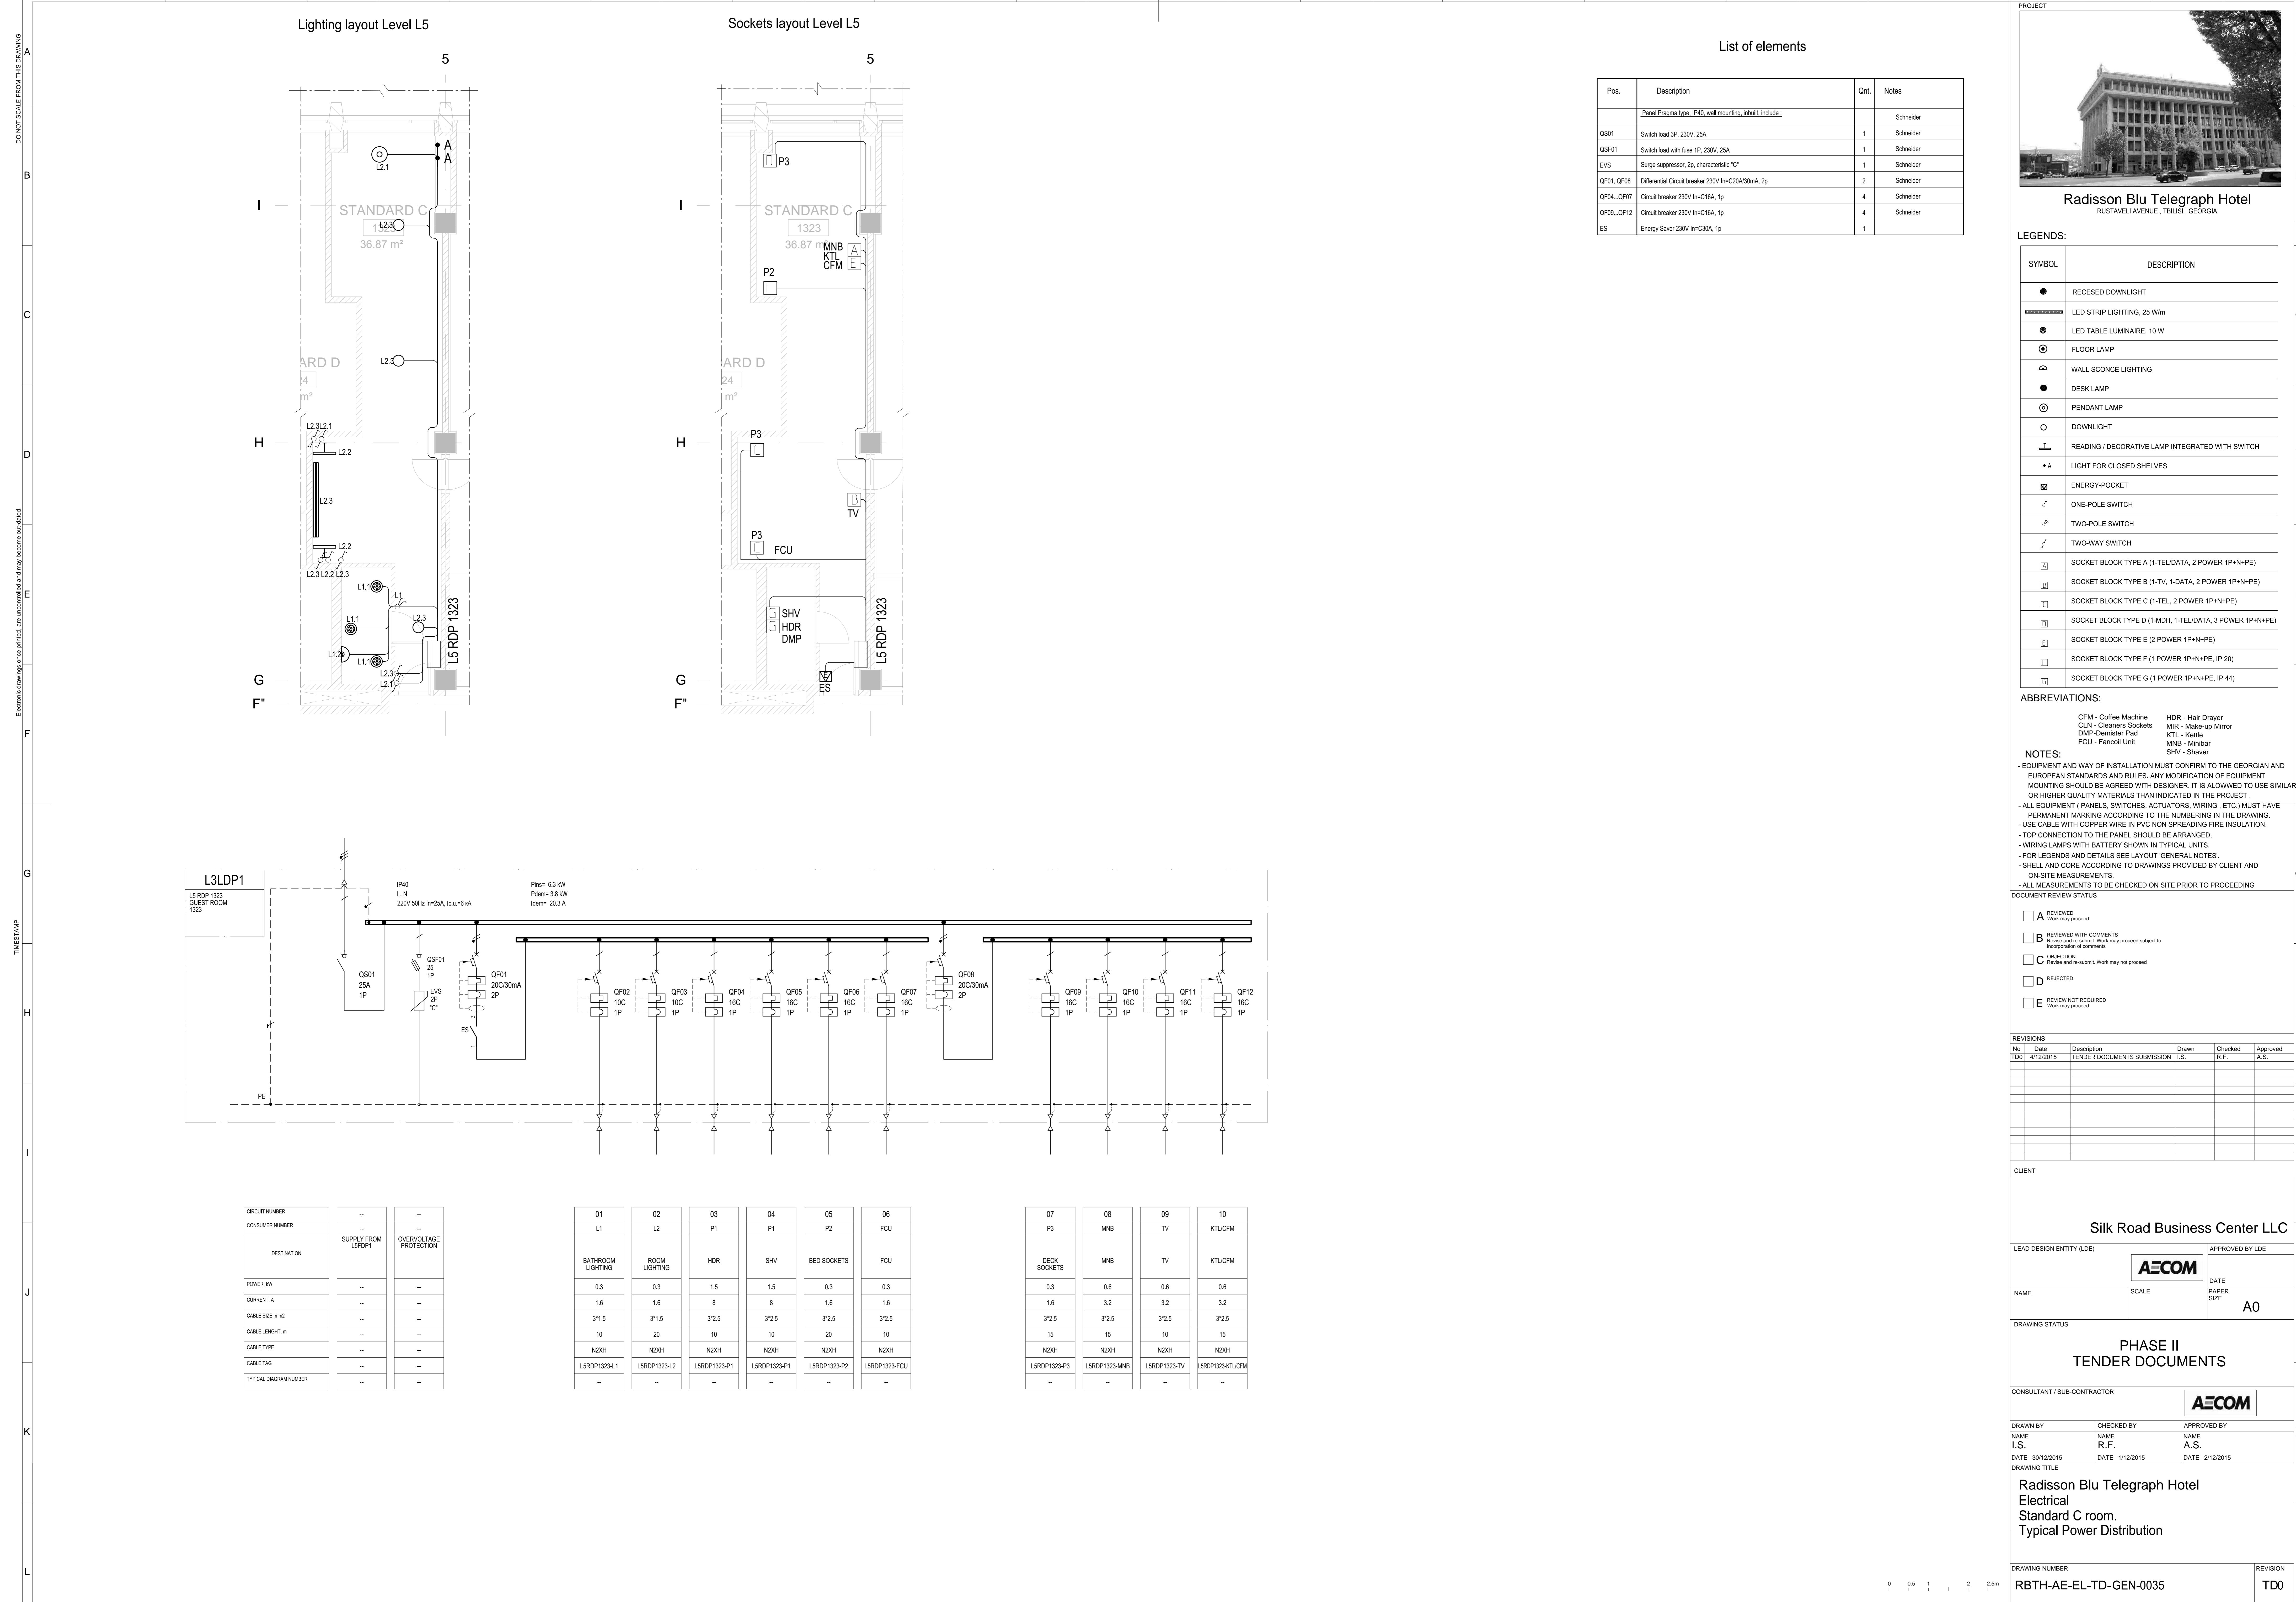


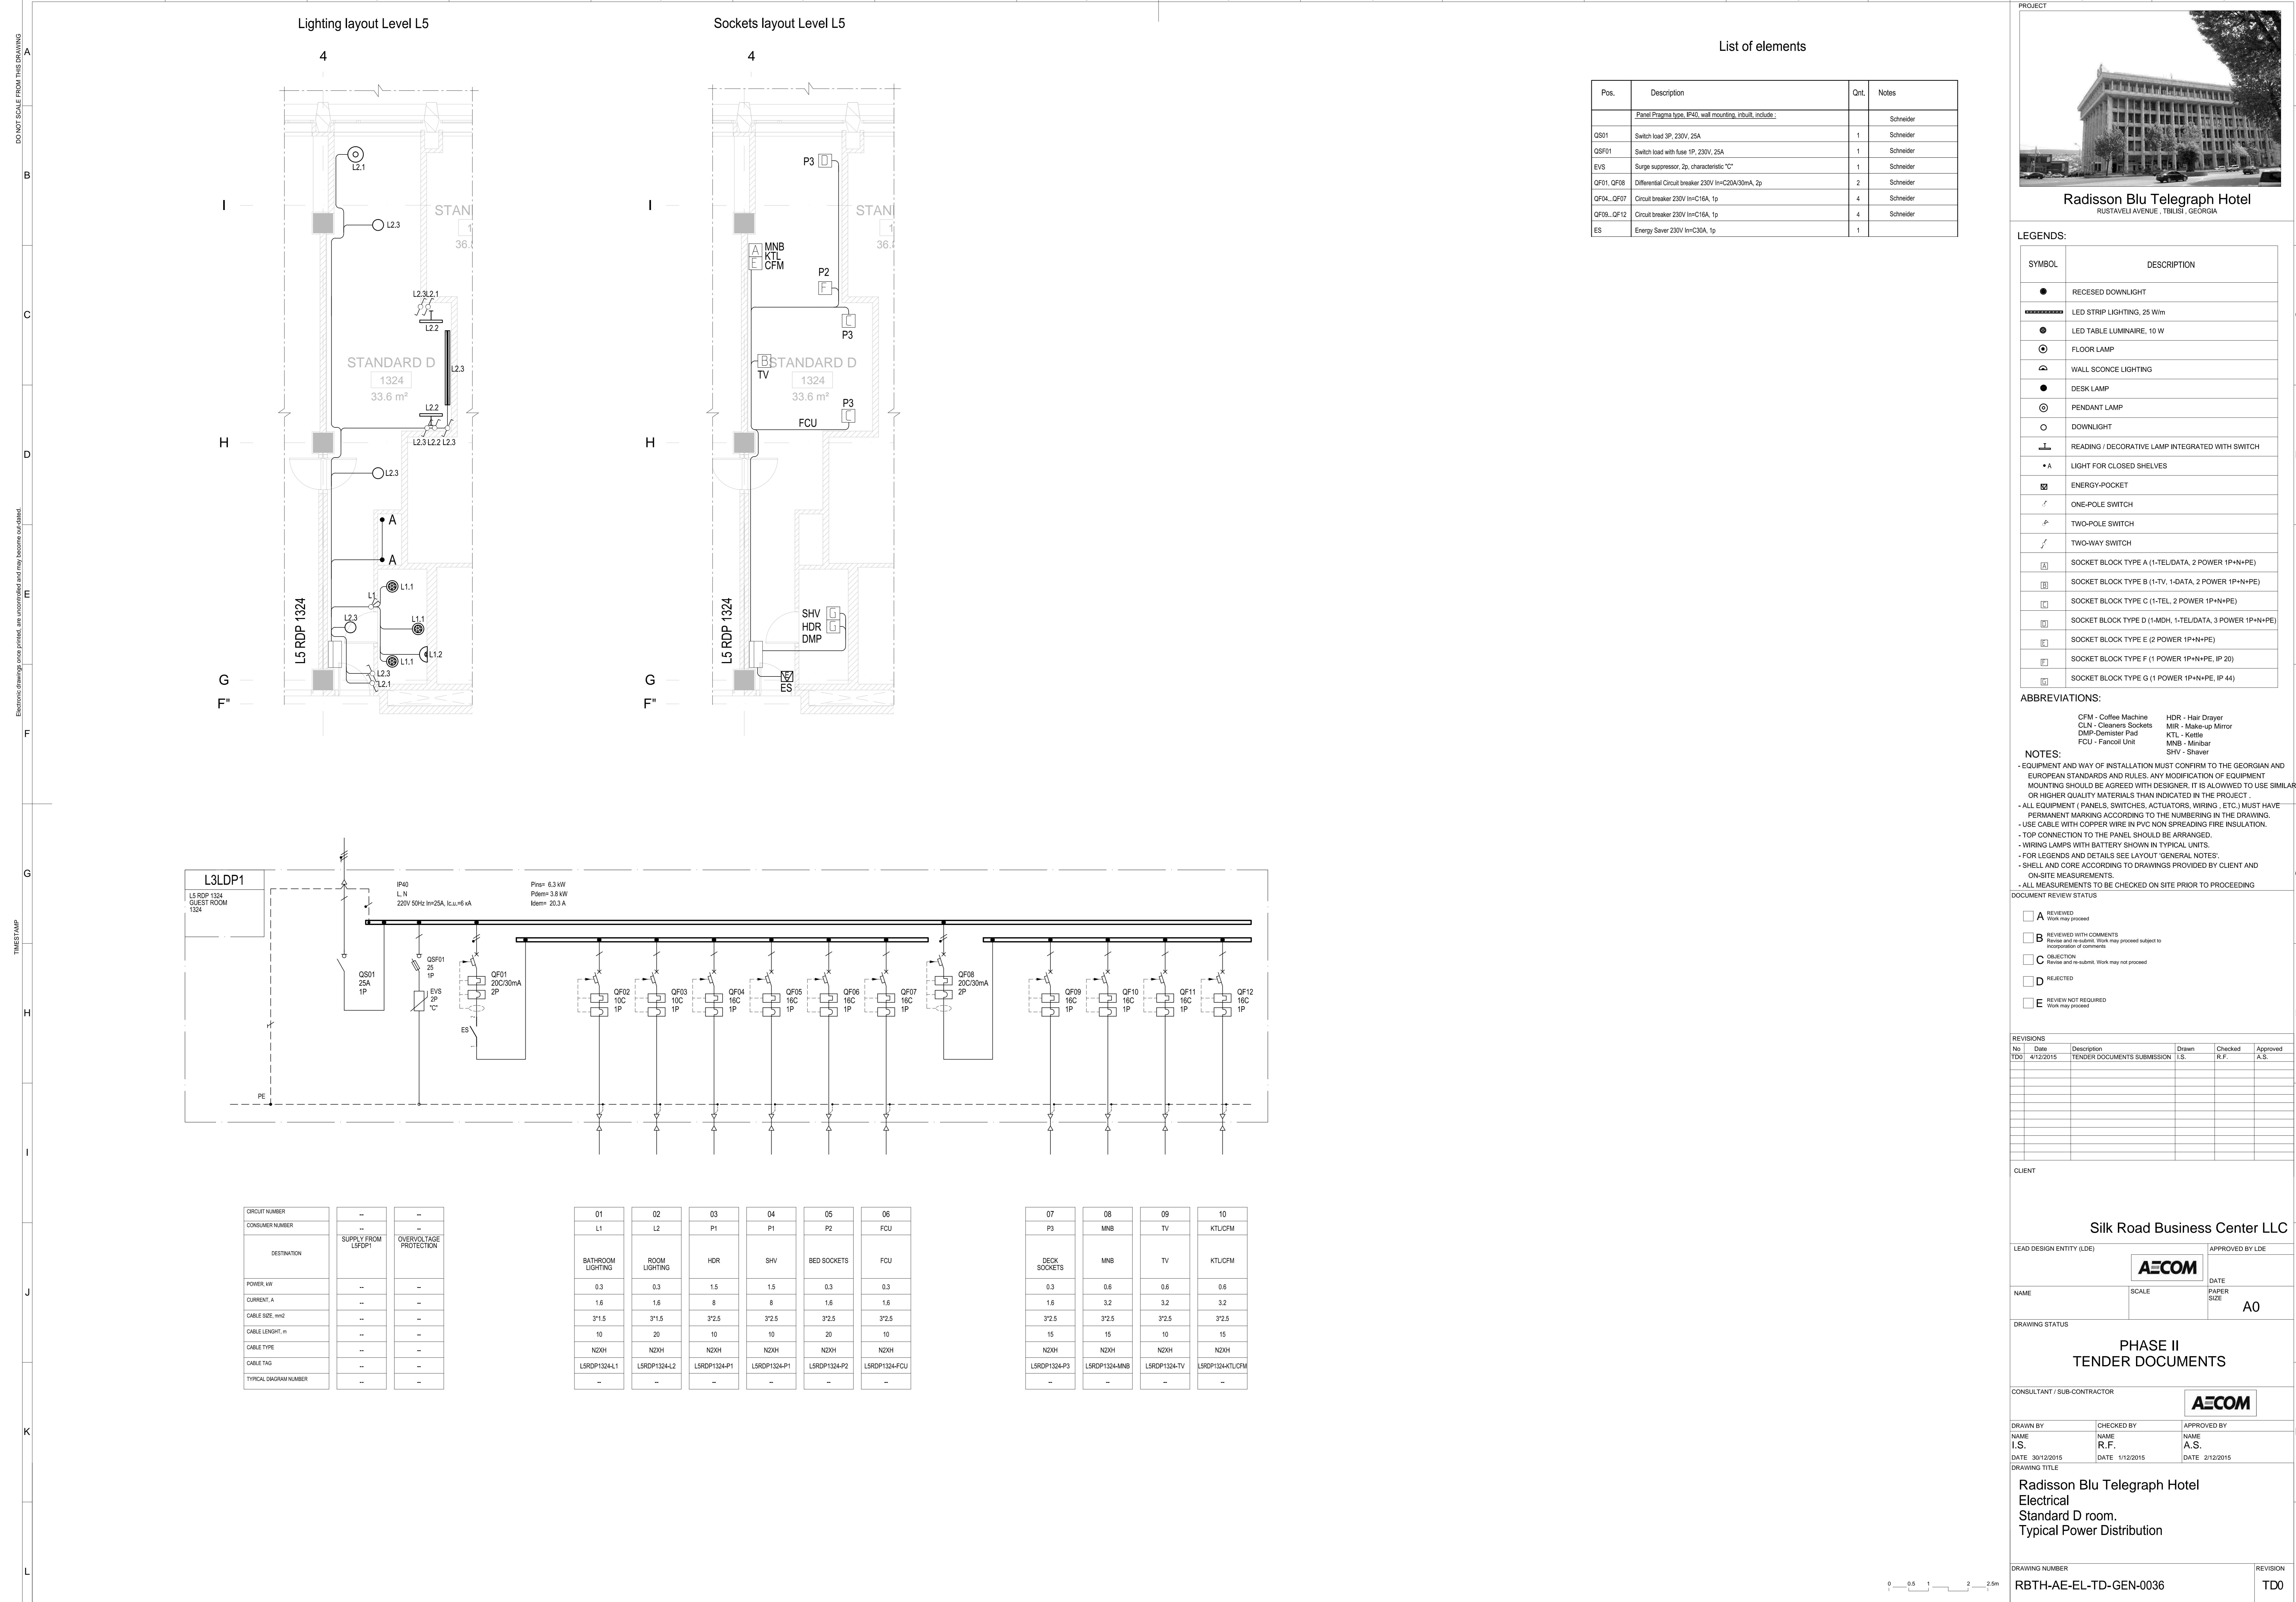

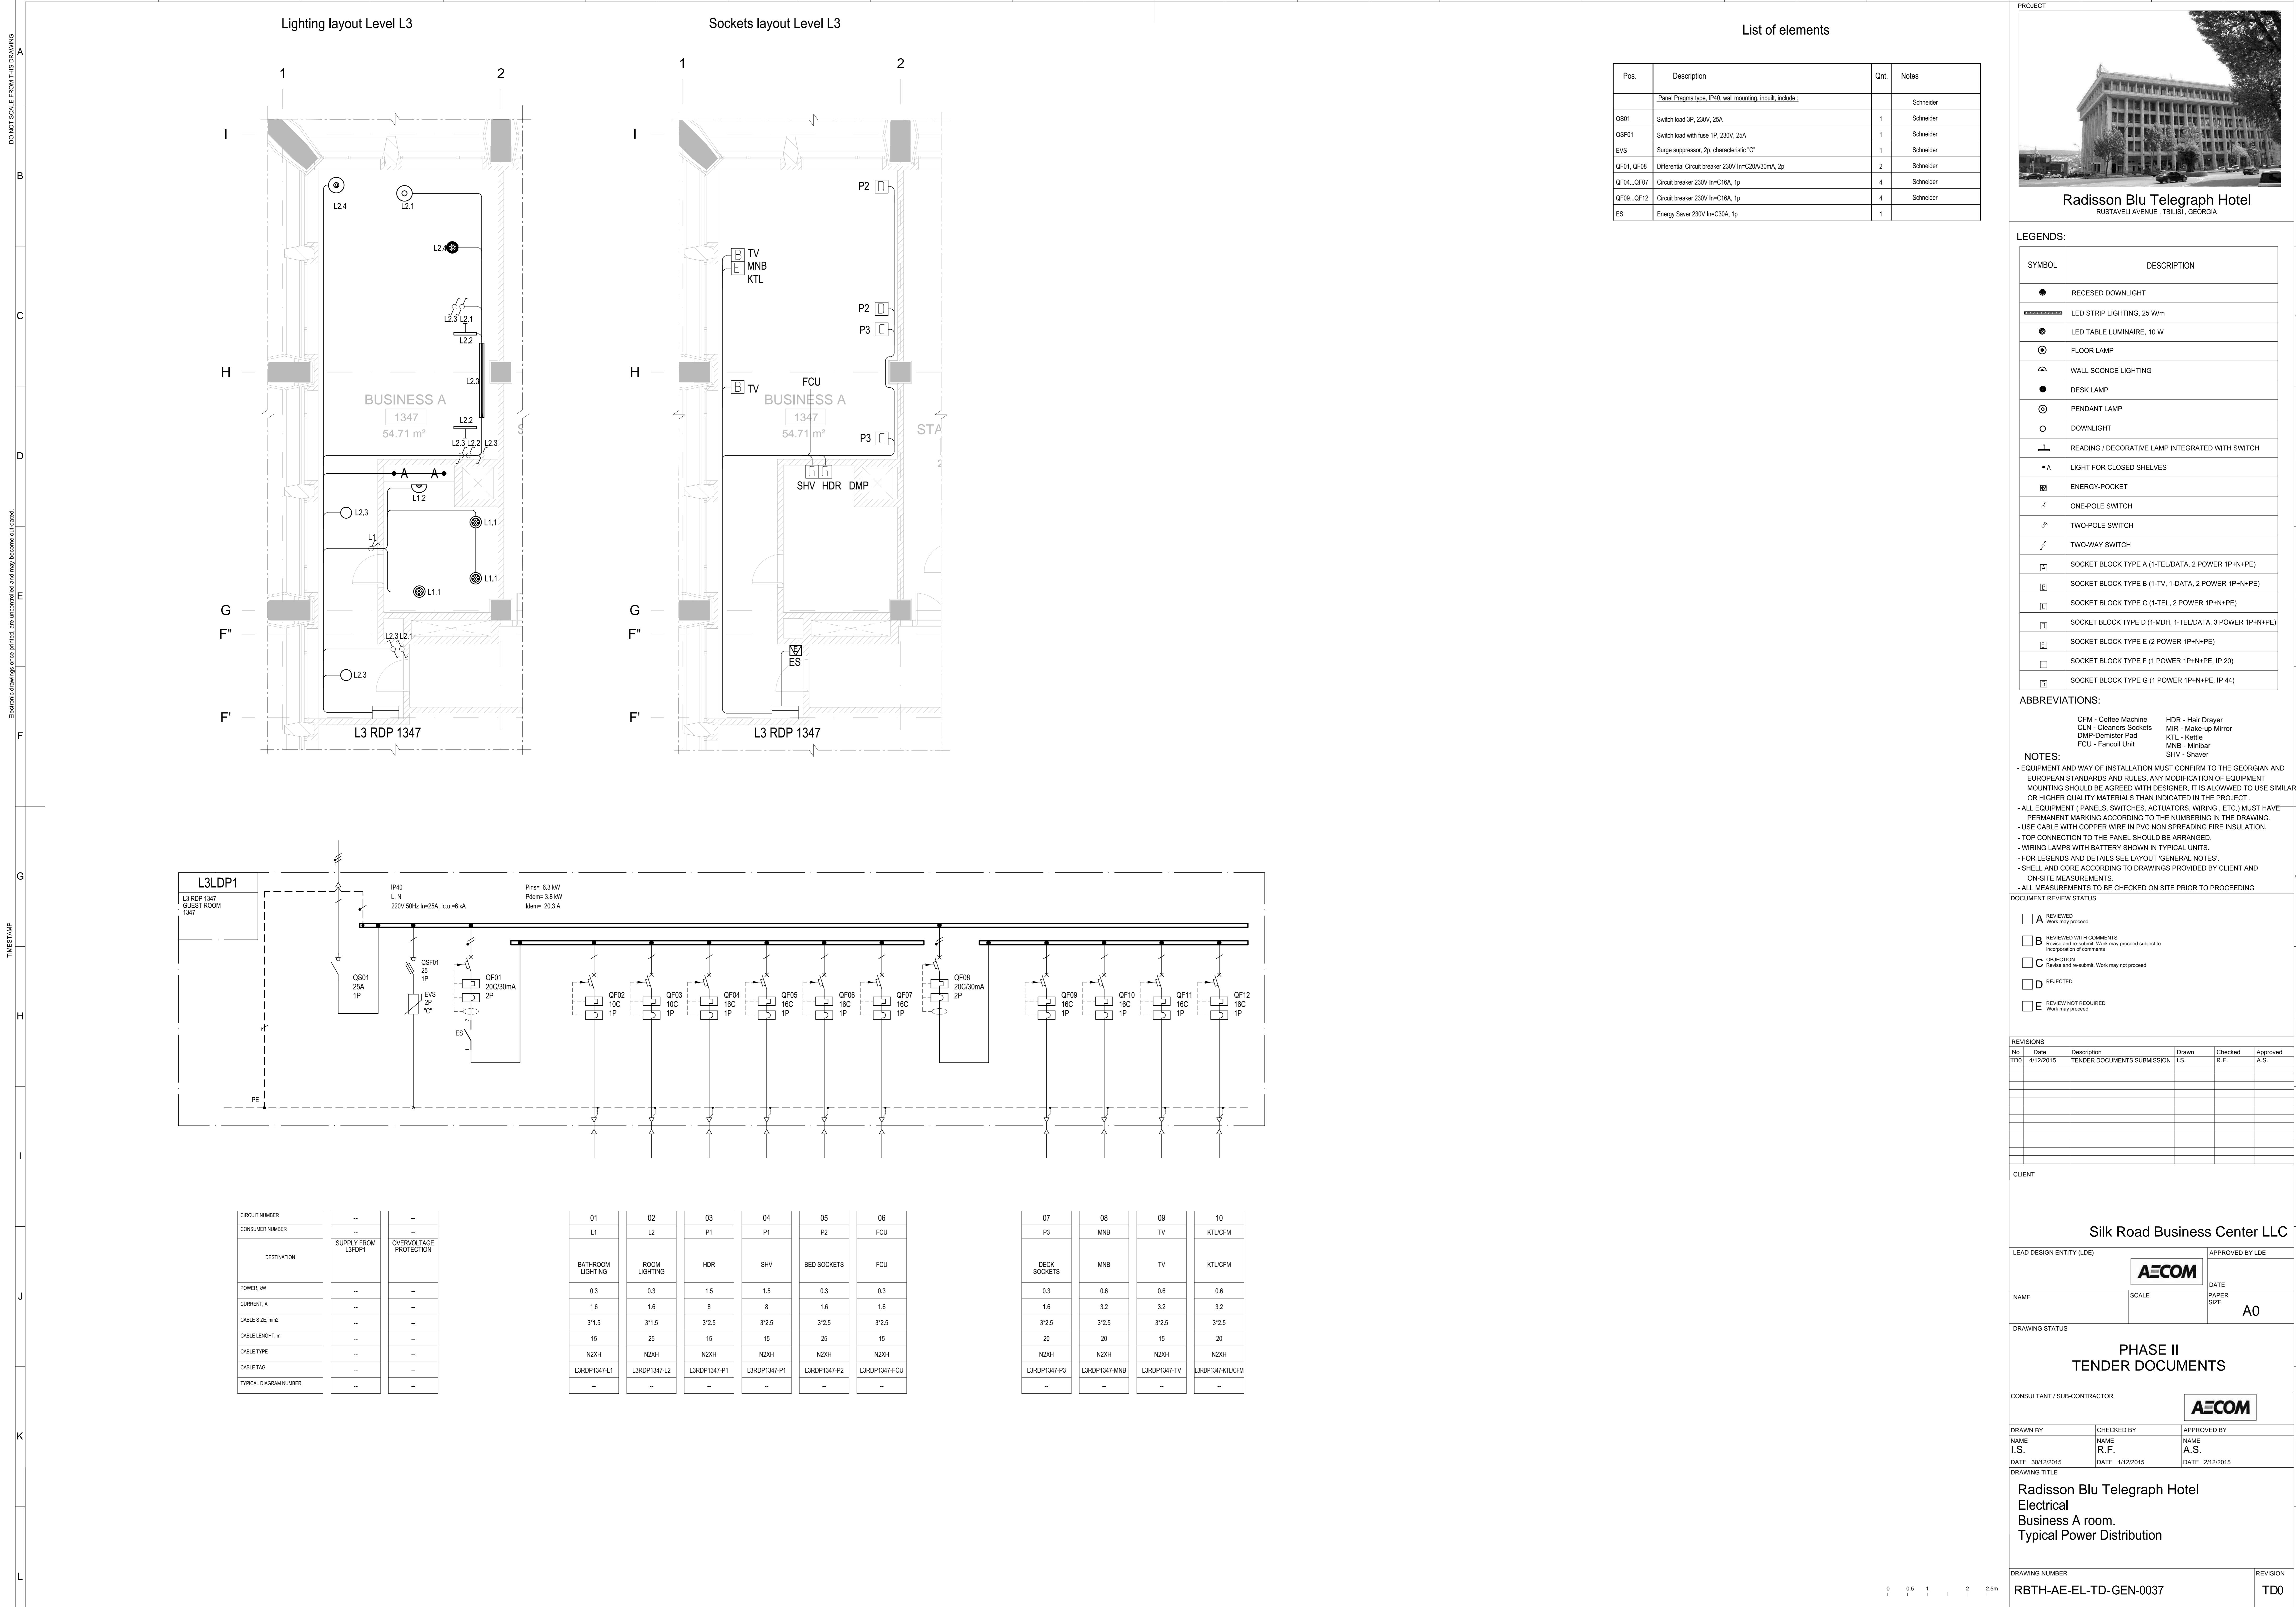

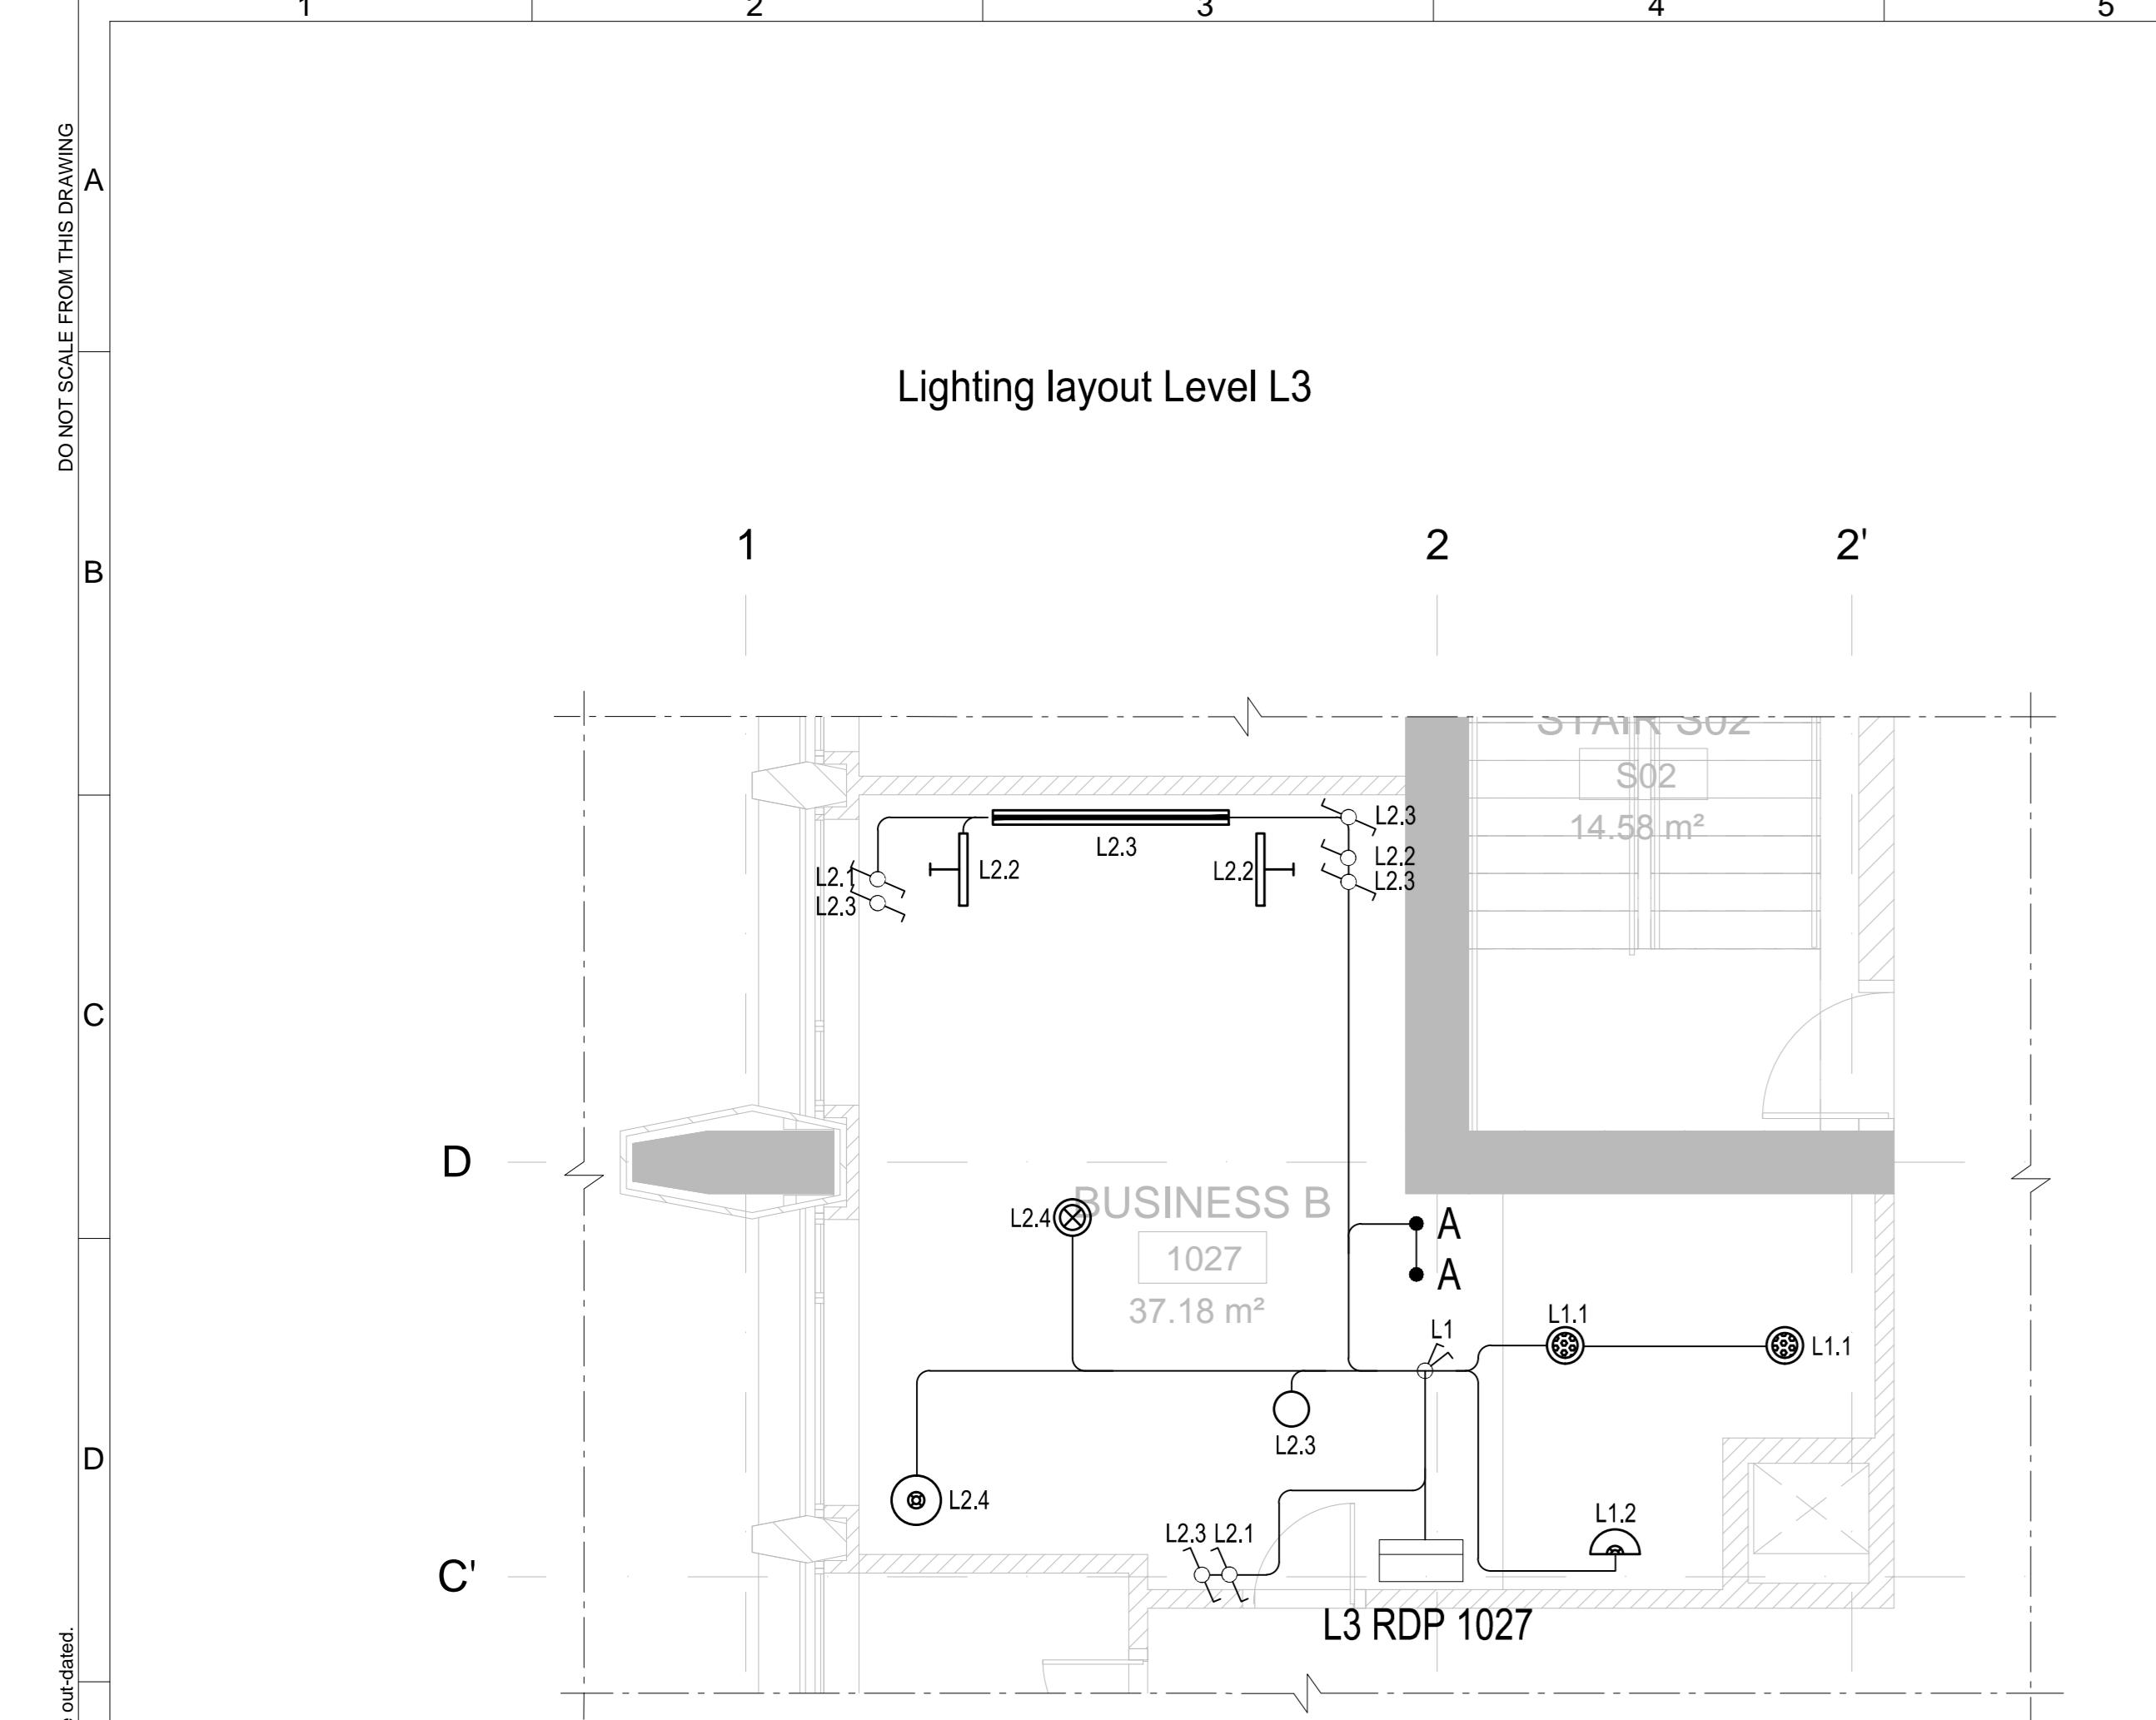

## Lighting layout Level L3

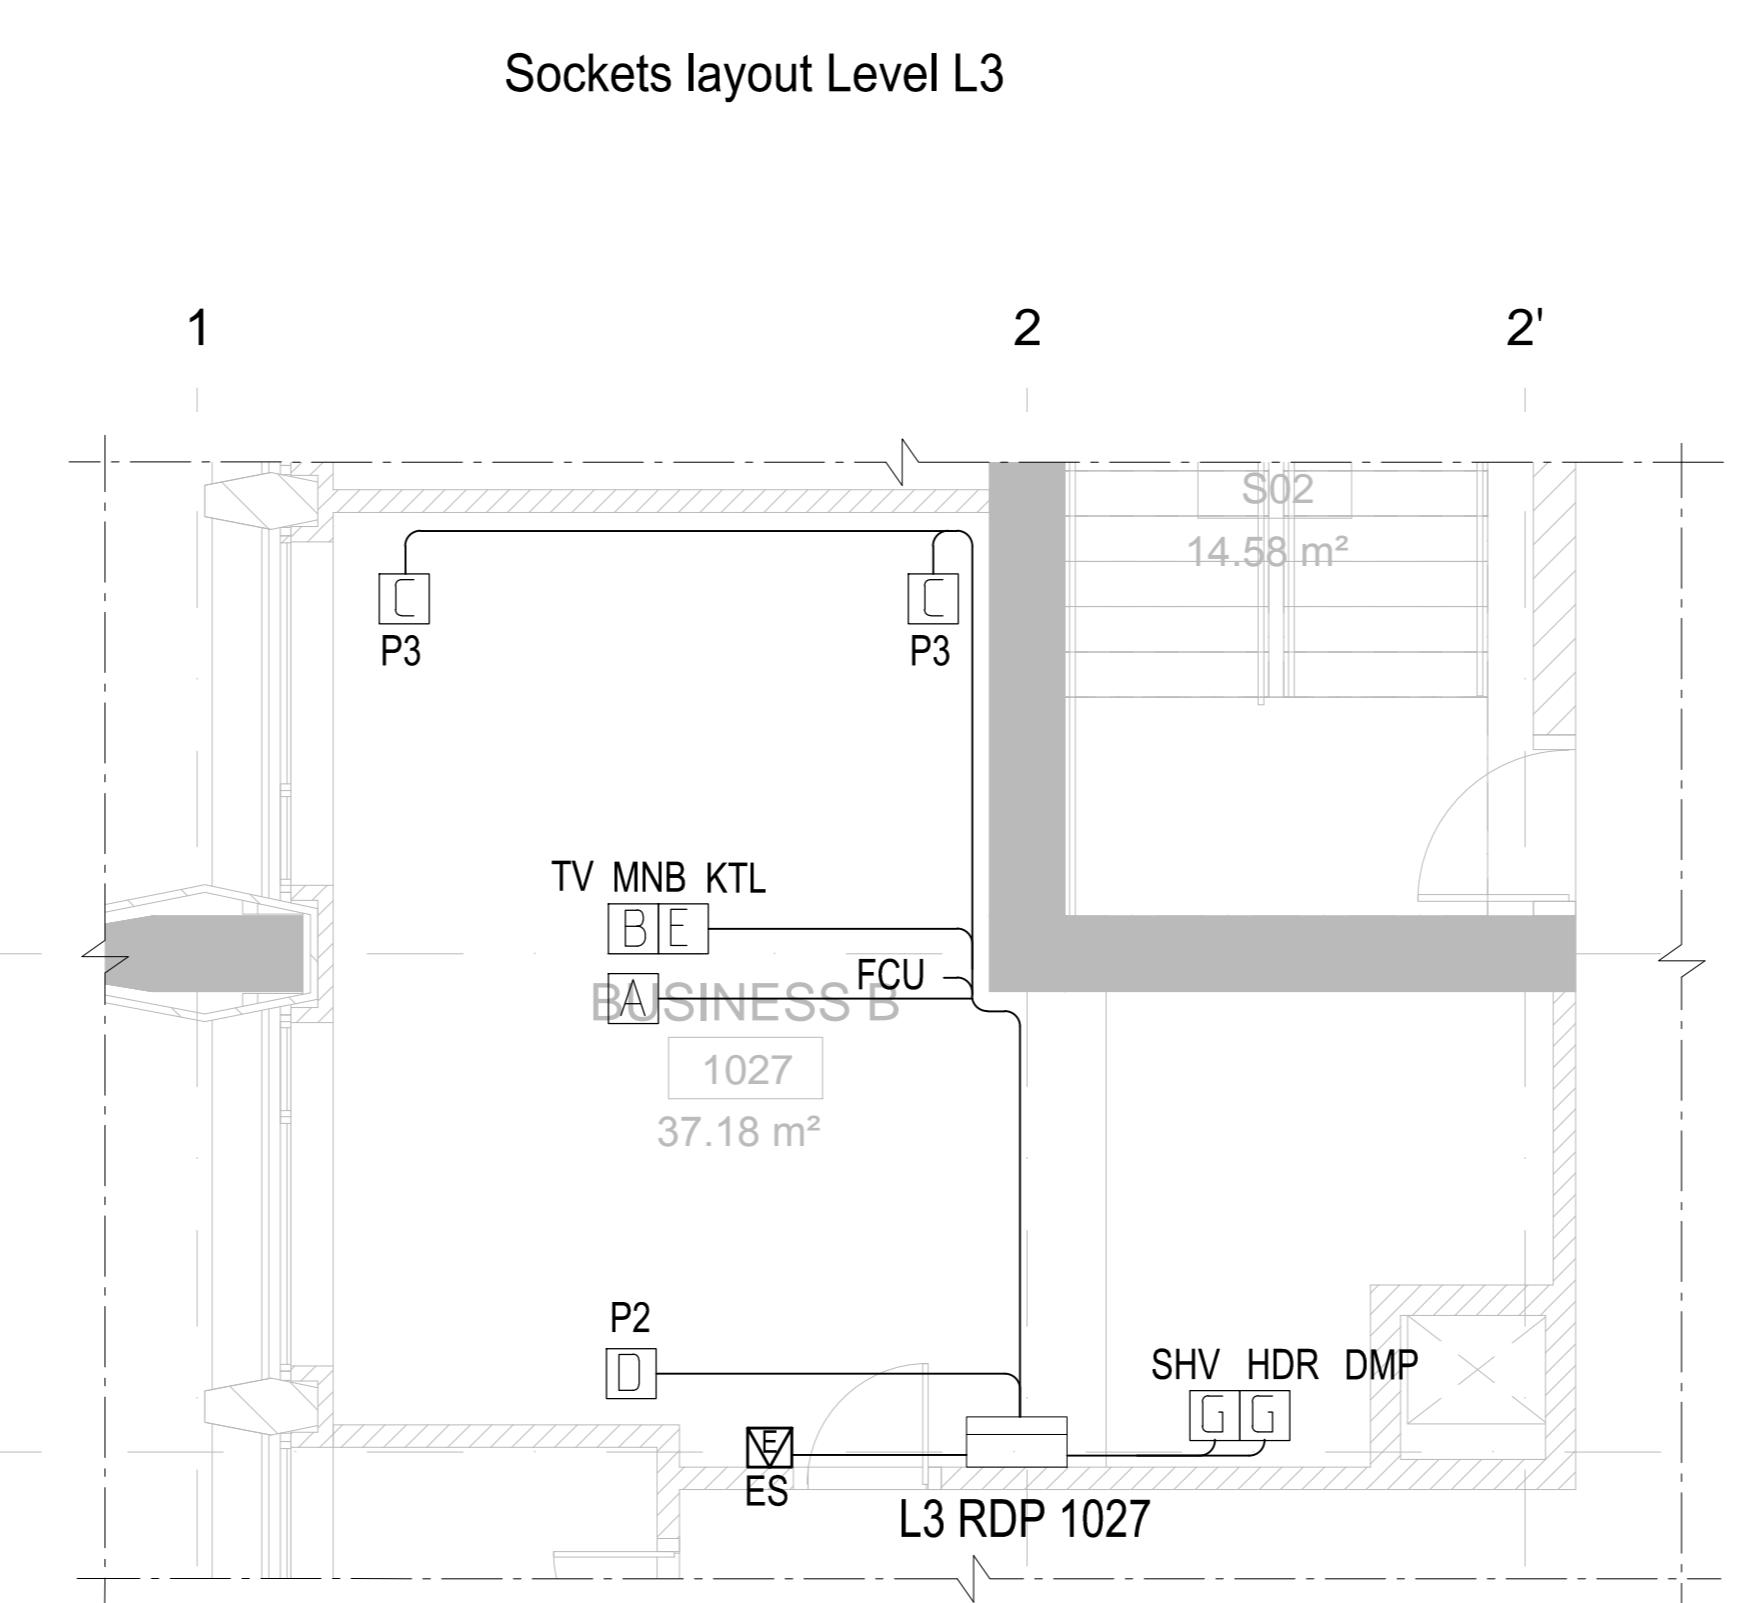

Sockets layout | level | 3

Pos.	Description	Qnt.	Notes
	<u>Panel Pragma type, IP40, wall mounting, inbuilt, include :</u>		Schneider
QS01	Switch load 3P, 230V, 25A	1	Schneider
QSF01	Switch load with fuse 1P, 230V, 25A	1	Schneider
EVS	Surge suppressor, 2p, characteristic "C"	1	Schneider
QF01, QF08	Differential Circuit breaker 230V In=C20A/30mA, 2p	2	Schneider
QF04...QF07	Circuit breaker 230V In=C16A, 1p	4	Schneider
QF09...QF12	Circuit breaker 230V In=C16A, 1p	4	Schneider
ES	Energy Saver 230V In=C30A, 1p	1	

## List of elements



# Radisson Blu Telegraph Hotel

BUSTAVELI AVENUE, TBILISI, GEORGIA

RUSTAVELI AVENUE , TBILISI , GEORGIA

SYMBOL	DESCRIPTION
●	RECESSED DOWNLIGHT
=====	LED STRIP LIGHTING, 25 W/m
⊗	LED TABLE LUMINAIRE, 10 W
◎	FLOOR LAMP
⌇	WALL SCONCE LIGHTING
●	DESK LAMP
○	PENDANT LAMP
○	DLWNLIGHT
— —	READING / DECORATIVE LAMP INTEGRATED WITH SWITCH
• A	LIGHT FOR CLOSED SHELVES
☒	ENERGY-POCKET
⌅	ONE-POLE SWITCH
⌆	TWO-POLE SWITCH
⌇	TWO-WAY SWITCH
[A]	SOCKET BLOCK TYPE A (1-TEL/DATA, 2 POWER 1P+N+PE)
[B]	SOCKET BLOCK TYPE B (1-TV, 1-DATA, 2 POWER 1P+N+PE)
[C]	SOCKET BLOCK TYPE C (1-TEL, 2 POWER 1P+N+PE)
[D]	SOCKET BLOCK TYPE D (1-MDH, 1-TEL/DATA, 3 POWER 1P+N+PE)
[E]	SOCKET BLOCK TYPE E (2 POWER 1P+N+PE)
[F]	SOCKET BLOCK TYPE F (1 POWER 1P+N+PE, IP 20)
[G]	SOCKET BLOCK TYPE G (1 POWER 1P+N+PE, IP 44)

## ABBREVIATIONS:

**OTES:**

EQUIPMENT AND WAY OF INSTALLATION MUST CONFIRM TO THE GEORGIAN AND EUROPEAN STANDARDS AND RULES. ANY MODIFICATION OF EQUIPMENT MOUNTING SHOULD BE AGREED WITH DESIGNER. IT IS ALLOWED TO USE SIMILAR HIGHER QUALITY MATERIALS THAN INDICATED IN THE PROJECT.

ALL EQUIPMENT ( PANELS, SWITCHES, ACTUATORS, WIRING , ETC.) MUST HAVE PERMANENT MARKING ACCORDING TO THE NUMBERING IN THE DRAWING.

USE CABLE WITH COPPER WIRE IN PVC NON SPREADING FIRE INSULATION.

TOP CONNECTION TO THE PANEL SHOULD BE ARRANGED.

BRING LAMPS WITH BATTERY SHOWN IN TYPICAL UNITS.

FOR LEGENDS AND DETAILS SEE LAYOUT 'GENERAL NOTES'.

SELL AND CORE ACCORDING TO DRAWINGS PROVIDED BY CLIENT AND ON-SITE MEASUREMENTS.

T

Silk Road Business Center LLC

DESIGN ENTITY (LDE)		APPROVED BY LDE
---------------------	---	-----------------

		DATE
	SCALE	PAPER SIZE


# PHASE II TENDER DOCUMENTS

CONSULTANT / SUB-CONTRACTOR		
BY	CHECKED BY	APPROVED BY
30/12/2015 N TITLE	NAME R.F. DATE 1/12/2015	NAME A.S. DATE 2/12/2015

adisson Blu Telegraph Hotel  
electrical  
usiness B room.  
ypical Power Distribution


NG NUMBER  
**TH-AE-EL-TD-GEN-0038**



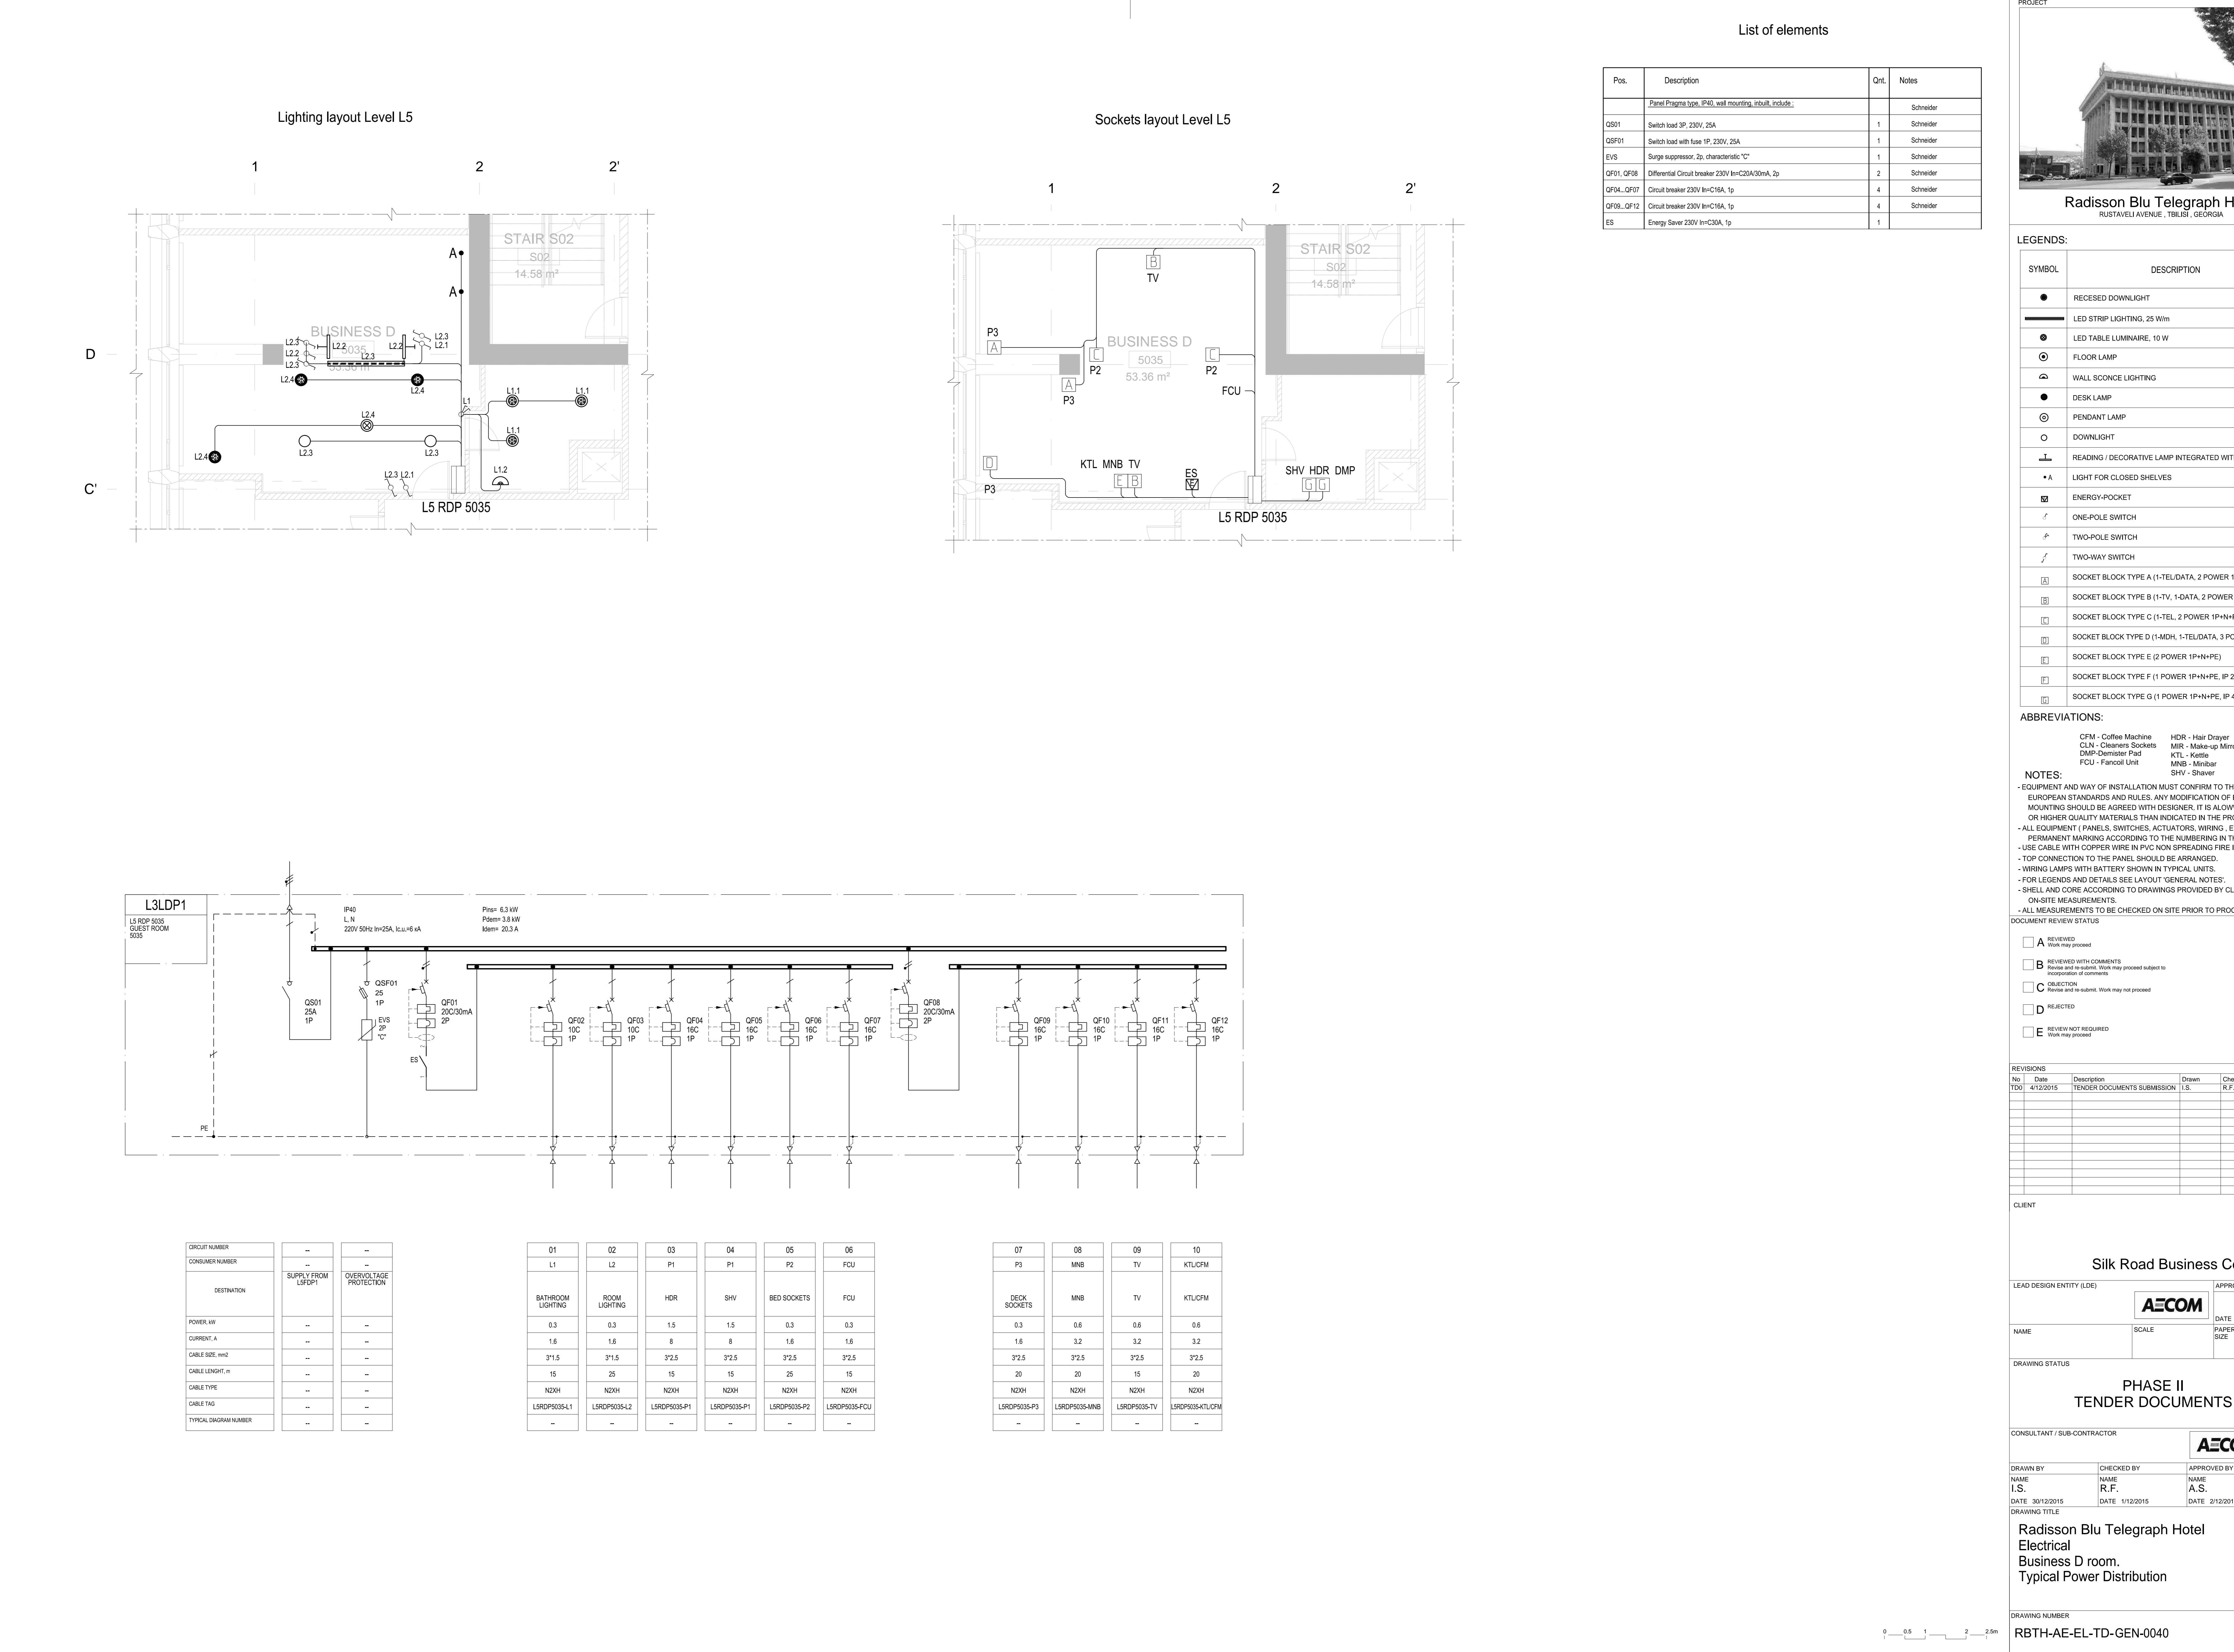

Radisson Blu Telegraph Hotel


RUSTAVELI AVENUE, TBILISI, GEORGIA

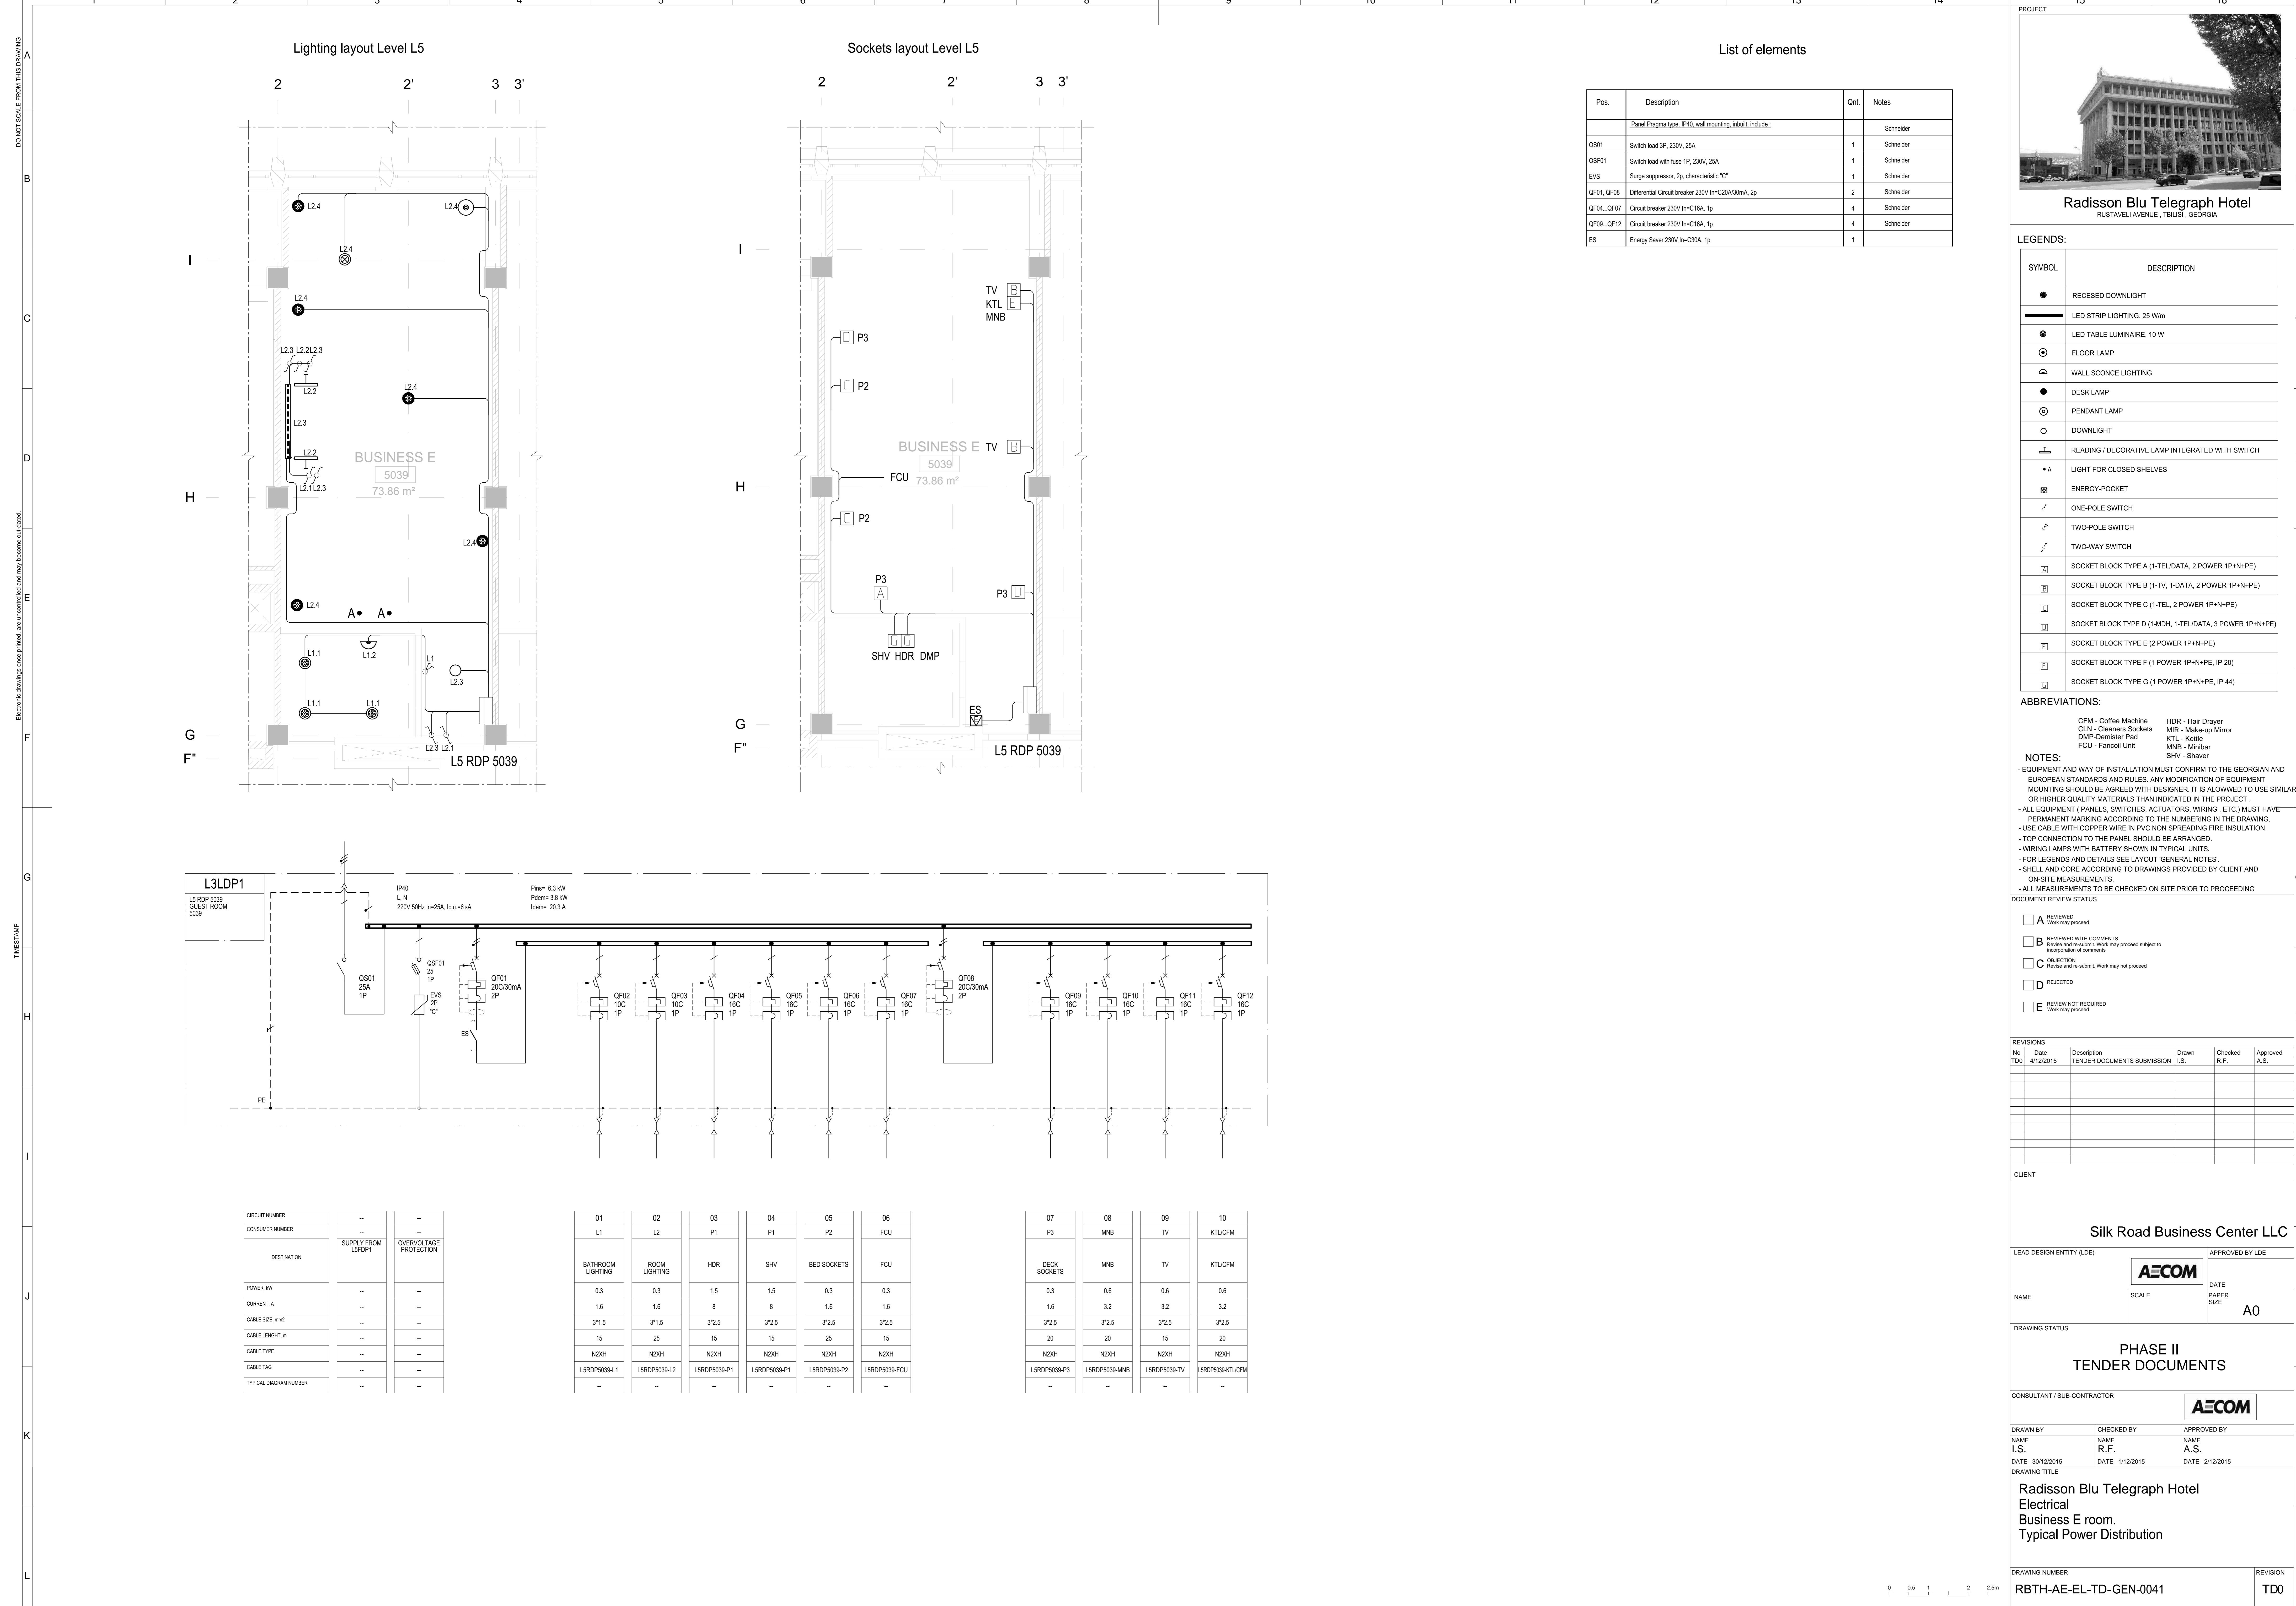



## List of elements

Pos.	Description	Qnt.	Notes
	Panel Pragia type, IP40, wall mounting, built-in;		Schneider
QS01	Switch load 3P, 230V, 25A	1	Schneider
QSFO1	Switch load with fuse 1P, 230V, 25A	1	Schneider
EVS	Surge suppressor, Zn, characteristic "C"	1	Schneider
QF01..QF08	Differential Circuit breaker 230V In=C20A/30mA, 2p	2	Schneider
QF04..QF07	Circuit breaker 230V In=C16A, 1p	4	Schneider
QF09..QF12	Circuit breaker 230V In=C16A, 1p	4	Schneider
ES	Energy Saver 230V In=C30A, 1p	1	Schneider

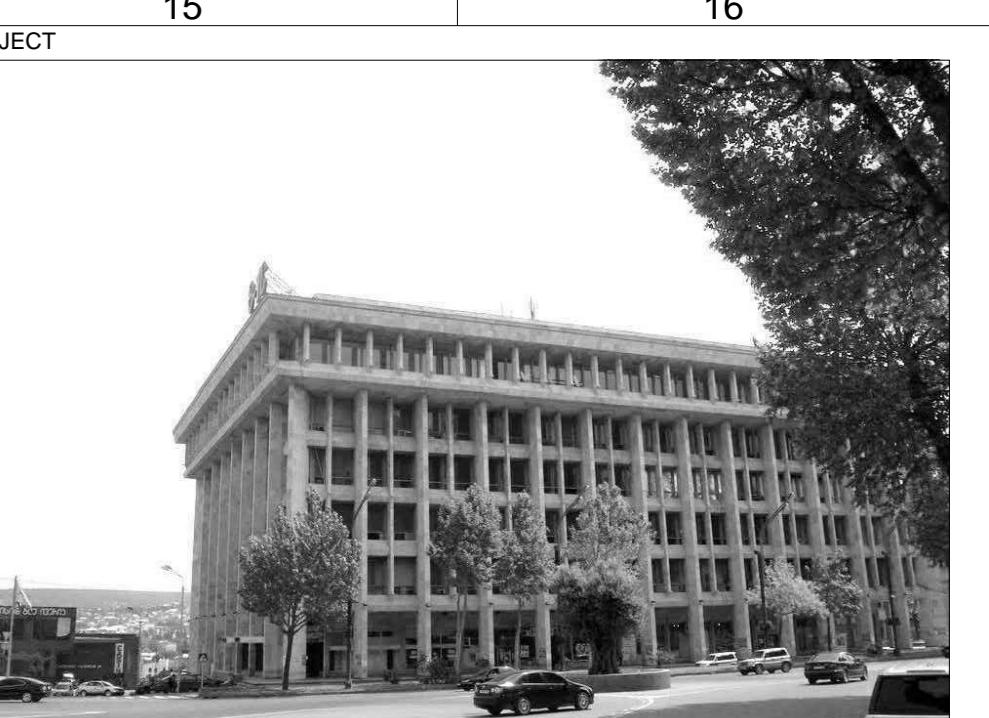Radisson Blu Telegraph Hotel  
RUSTAVELI AVENUE, TBILISI, GEORGIA

## LEGENDS:

SYMBOL	DESCRIPTION
●	RECESSED DOWNLIGHT
—	LED STRIP LIGHTING, 25 W/m
◎	LED TABLE LUMINAIRE, 10 W
○	FLOOR LAMP
△	WALL SCONCE LIGHTING
●	DESK LAMP
◎	PENDANT LAMP
○	DOWNLIGHT
—	READING L DECORATIVE LAMP INTEGRATED WITH SWITCH
• A	LIGHT FOR CLOSED SHELVES
☒	ENERGY-POCKET
□	ONE-POLE SWITCH
□	TWO-POLE SWITCH
□	TWO-WAY SWITCH
[A]	SOCKET BLOCK TYPE A (1-TEL/DATA, 2 POWER 1P+N+PE)
[B]	SOCKET BLOCK TYPE B (1-TV, 1-DATA, 2 POWER 1P+N+PE)
[C]	SOCKET BLOCK TYPE C (1-TEL, 2 POWER 1P+N+PE)
[D]	SOCKET BLOCK TYPE D (1-MDH, 1-TEL/DATA, 3 POWER 1P+N+PE)
[E]	SOCKET BLOCK TYPE E (2 POWER 1P+N+PE)
[F]	SOCKET BLOCK TYPE F (1 POWER 1P+N+PE, IP 20)
[G]	SOCKET BLOCK TYPE G (1 POWER 1P+N+PE, IP 44)

## ABBREVIATIONS:

CFM - Coffee Machine	HDR - Hair Dryer
CLN - Cleaners Sockets	MIR - Make-up Mirror
DMP - Demister Pad	KTL - Kettle
FCU - Fancoil Unit	MNB - Minibar
PL-2	SHV - Shaver

## NOTES:

- EQUIPMENT AND WAY OF INSTALLATION MUST CONFORM TO THE GEORGIAN AND EUROPEAN STANDARDS AND RULES. ANY MODIFICATION OF EQUIPMENT MOUNTING SHOULD BE AGREED WITH DESIGNER. IT IS ALLOWED TO USE SIMILAR OR HIGHER EQUIPMENT THAN THAT WHICH IS SHOWN IN THE DRAWINGS.
- ALL EQUIPMENT PANELS, SWITCHES, ACTUATORS, WIRING, ETC., MUST HAVE PERMANENT MARKING ACCORDING TO THE NUMBERING IN THE DRAWING.
- USE CABLE WITH COPPER WIRE IN PVC NON SPREADING FIRE INSULATION.
- TOP CONNECTION TO THE PANEL SHOULD BE ARRANGED.
- WIRING LAMPS WITH BATTERY SHOWN IN TYPICAL UNITS.
- FOR LEGENDS AND DETAILS SEE LAYOUT GENERAL NOTES.
- SHELL AND CORE ACCORDING TO DRAWINGS PROVIDED BY CLIENT AND ON-SITE MEASUREMENTS.
- ALL MEASUREMENTS TO BE CHECKED ON SITE PRIOR TO PROCEEDING.

## DOCUMENT REVIEW STATUS:

<input type="checkbox"/> A	REVIEWED	Work may proceed
<input type="checkbox"/> B	REVIEWED WITH COMMENTS	Review and re-submit. Work may proceed subject to comments.
<input type="checkbox"/> C	OBJECTION	Object and re-submit. Work may not proceed.
<input type="checkbox"/> D	REJECTED	
<input type="checkbox"/> E	REVIEW NOT REQUIRED	

## REVISIONS:

No

Date

Description

Drawn

Checked

Approved

TDD

4/12/2015

TENDER DOCUMENTS SUBMISSION

I.S.

R.F.

A.S.

## CLIENT:

Silk Road Business Center LLC

LEAD DESIGN ENTITY (LDE)

APPROVED BY LDE

AECOM

DATE

A0

NAME

SCALE

PAPER SIZE

J

DRAWING STATUS

PHASE II

TENDER DOCUMENTS

CONSULTANT / SUB-CONTRACTOR

AECOM

DRAWN BY

CHECKED BY

APPROVED BY

I.S.

NAME

R.F.

A.S.

DATE

30/12/2015

DATE

1/12/2015

DATE

2/12/2015

DRAWING TITLE

Radisson Blu Telegraph Hotel

Electrical

Supperior B room.

Typical Power Distribution

DRAWING NUMBER


RBTH-AE-EL-TD-GEN-0043

REVISION



L

TDD

## Lighting layout Level L3

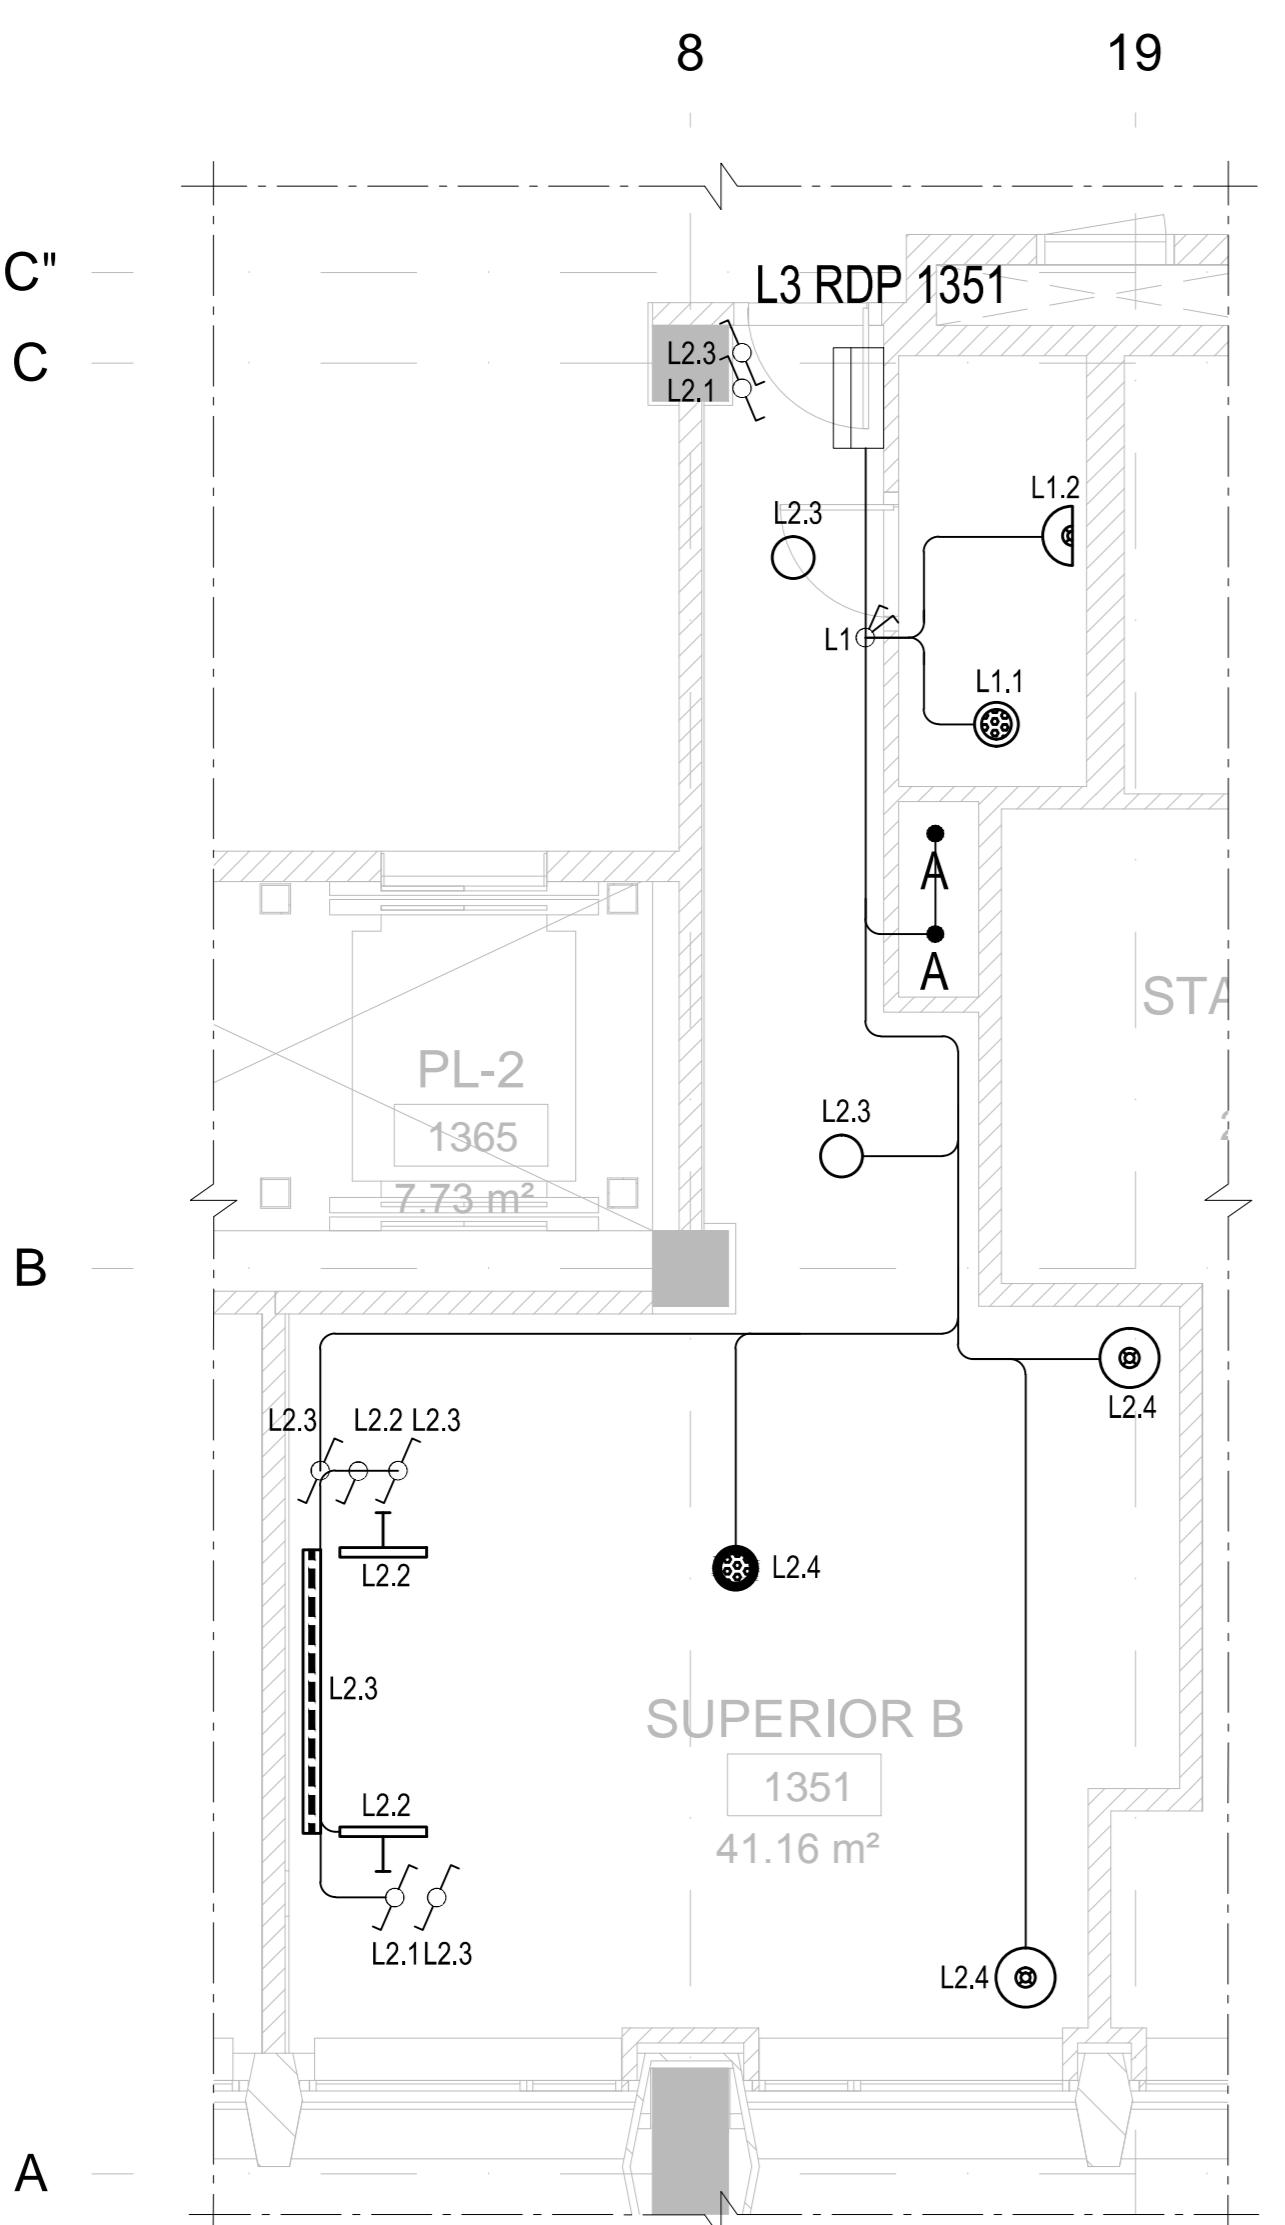



## Sockets layout Level L3

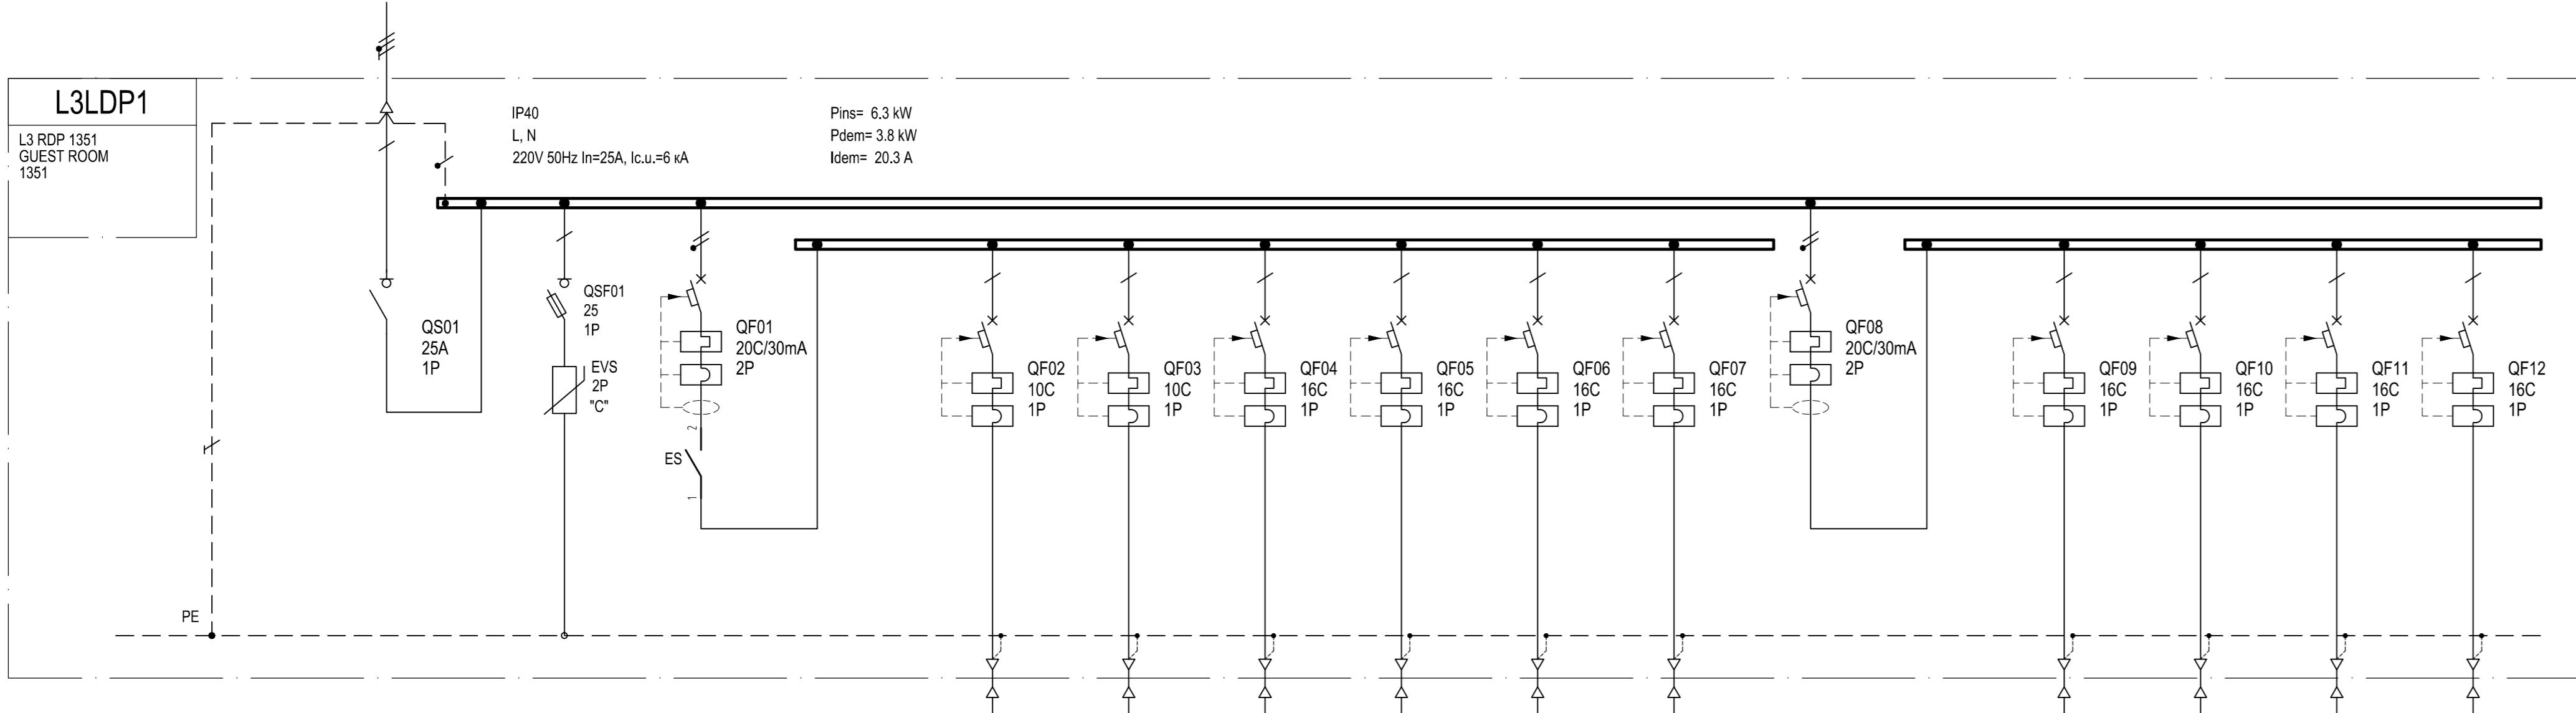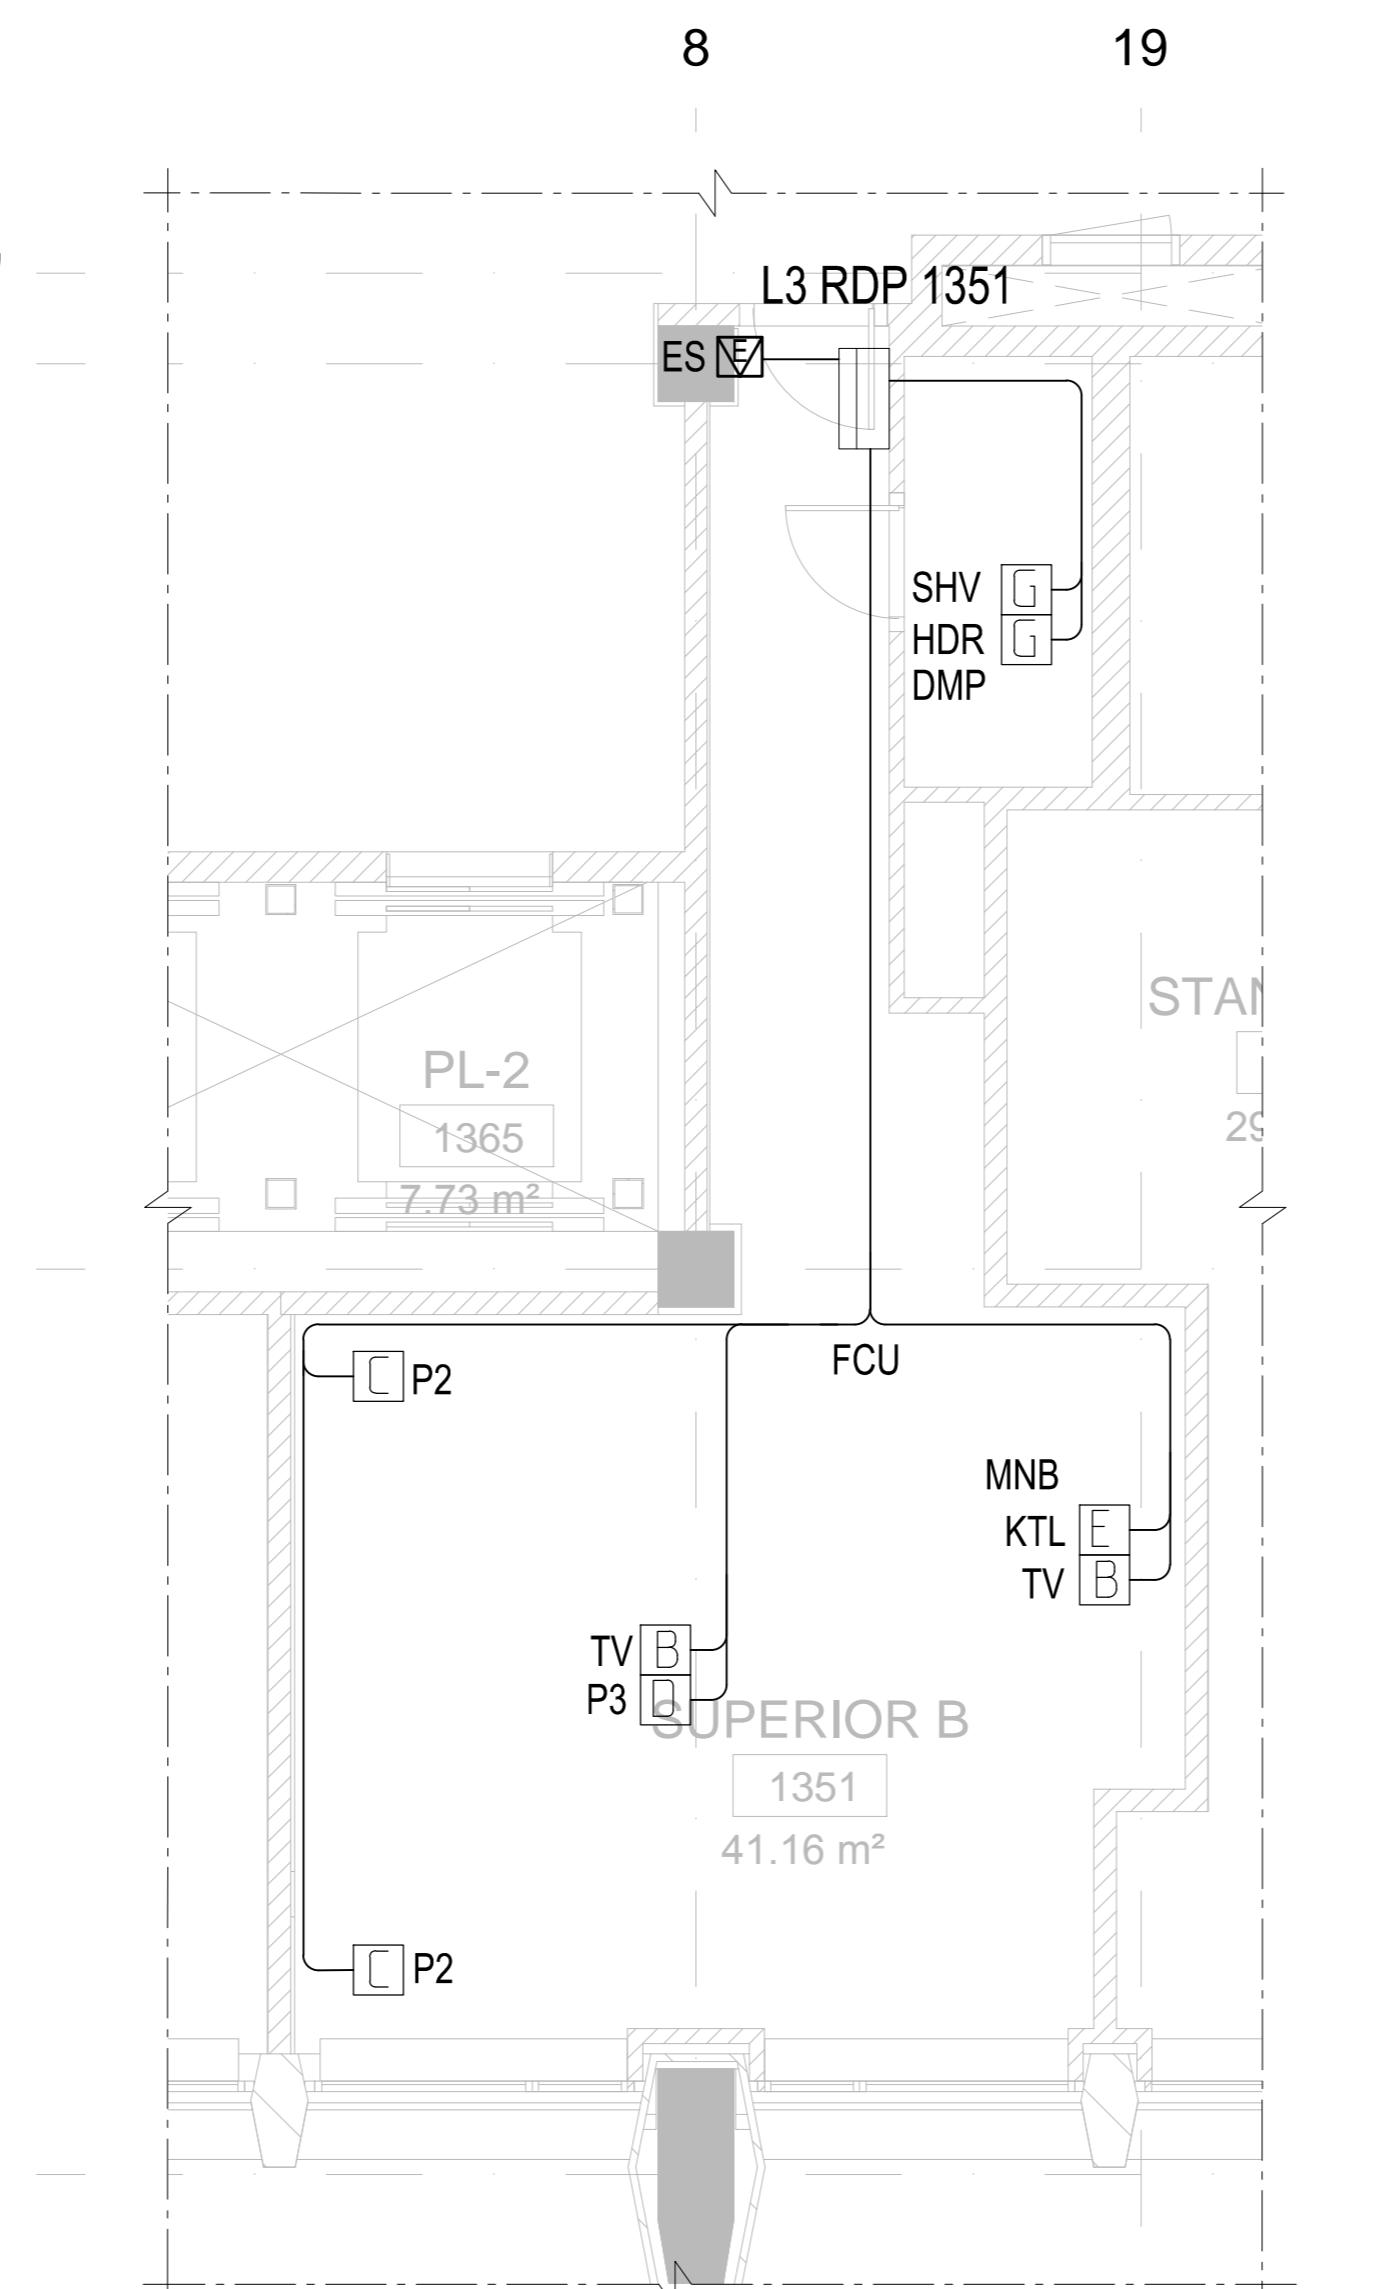

CIRCUIT NUMBER	CONSUMER NUMBER	—	—	—
POWER kW	—	—	—	—
CURRENT A	—	—	—	—
CABLE SIZE, mm²	—	—	—	—
CABLE LENGTH, m	—	—	—	—
CABLE TYPE	—	—	—	—
CABLE TAG	—	—	—	—
TYPICAL DIAGRAM NUMBER	—	—	—	—

01	02	03	04	05	06	07	08	09	10
BATHROOM LIGHTING	ROOM LIGHTING	HDR	SHV	BED SOCKETS	FCU	DECK SOCKETS	MNB	TV	KTL/CFM
0.3	0.3	1.5	0.3	0.3	0.3	0.3	0.6	0.6	0.6
1.6	1.6	8	8	1.6	1.6	1.6	3.2	3.2	3.2
31.5	31.5	3'2.5	3'2.5	3'2.5	3'2.5	3'2.5	3'2.5	3'2.5	3'2.5
15	25	15	15	25	25	20	15	20	20
NZXH	NZXH	NZXH	NZXH	NZXH	NZXH	NZXH	NZXH	NZXH	NZXH
L3RDP1351-A1	L3RDP1351-B2	L3RDP1351-C1	L3RDP1351-P1	L3RDP1351-P2	L3RDP1351-FCU	L3RDP1351-P3	L3RDP1351-MNB	L3RDP1351-TV	L3RDP1351-KTL/CFM

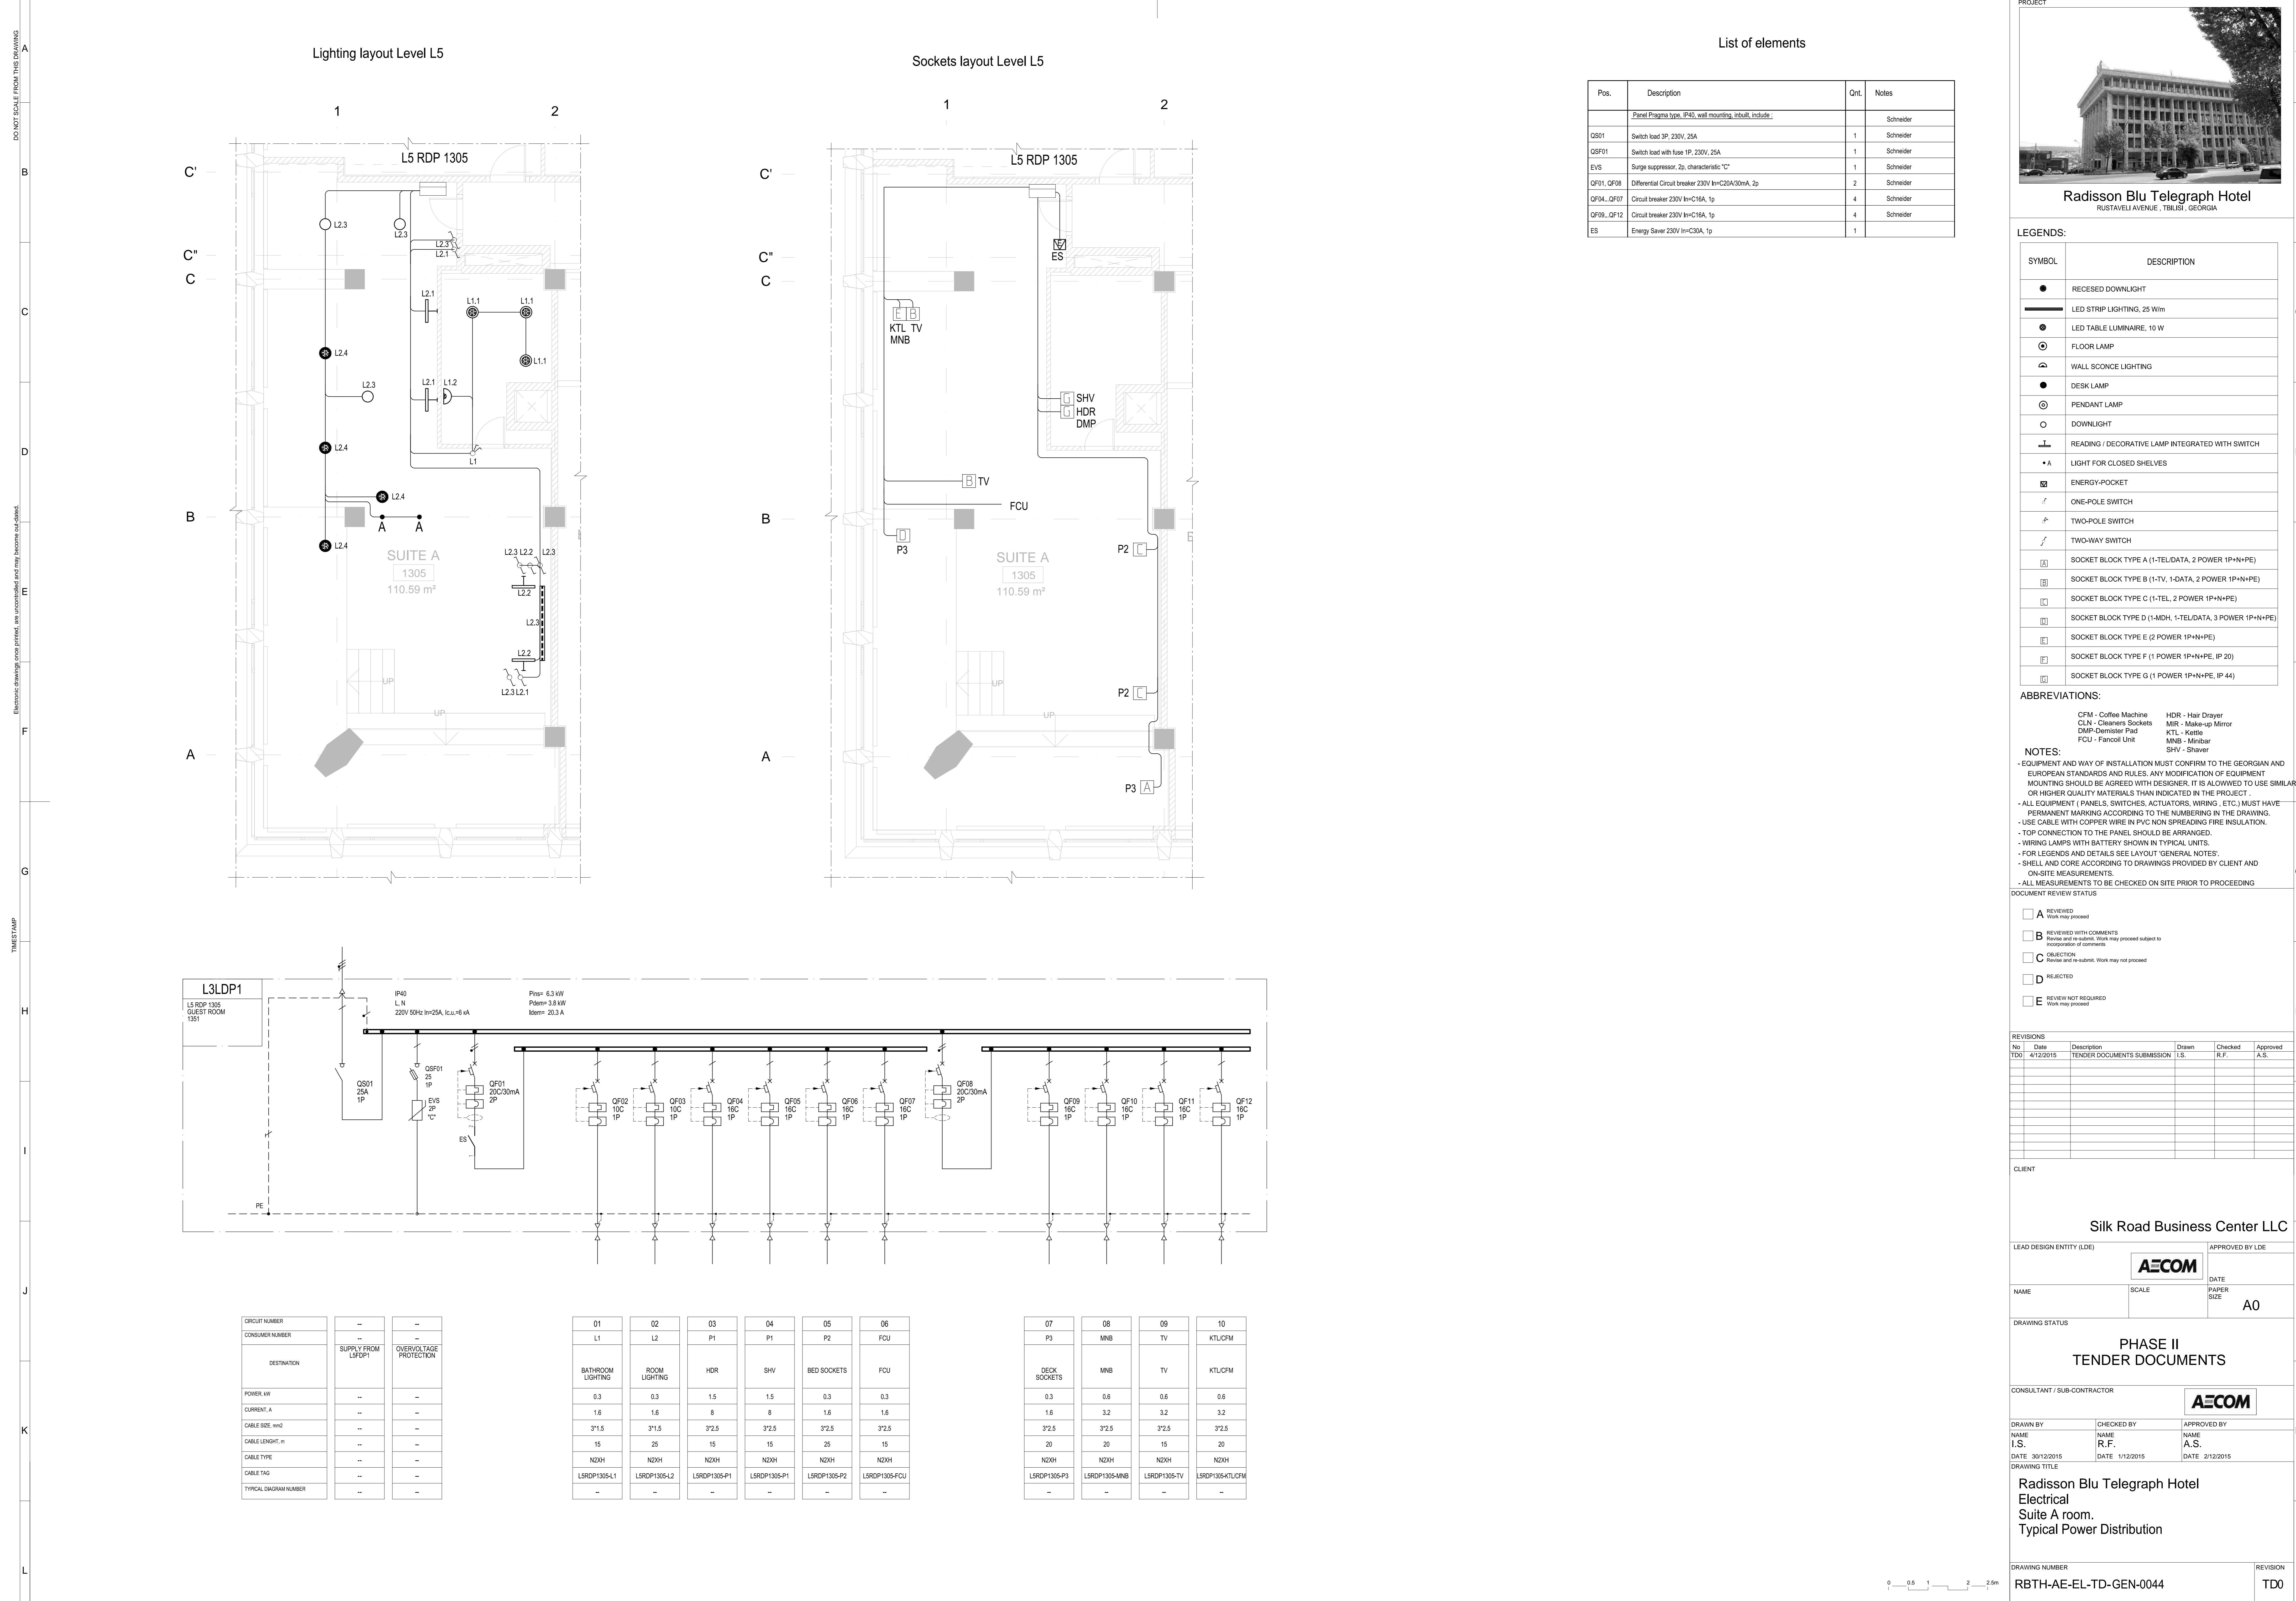

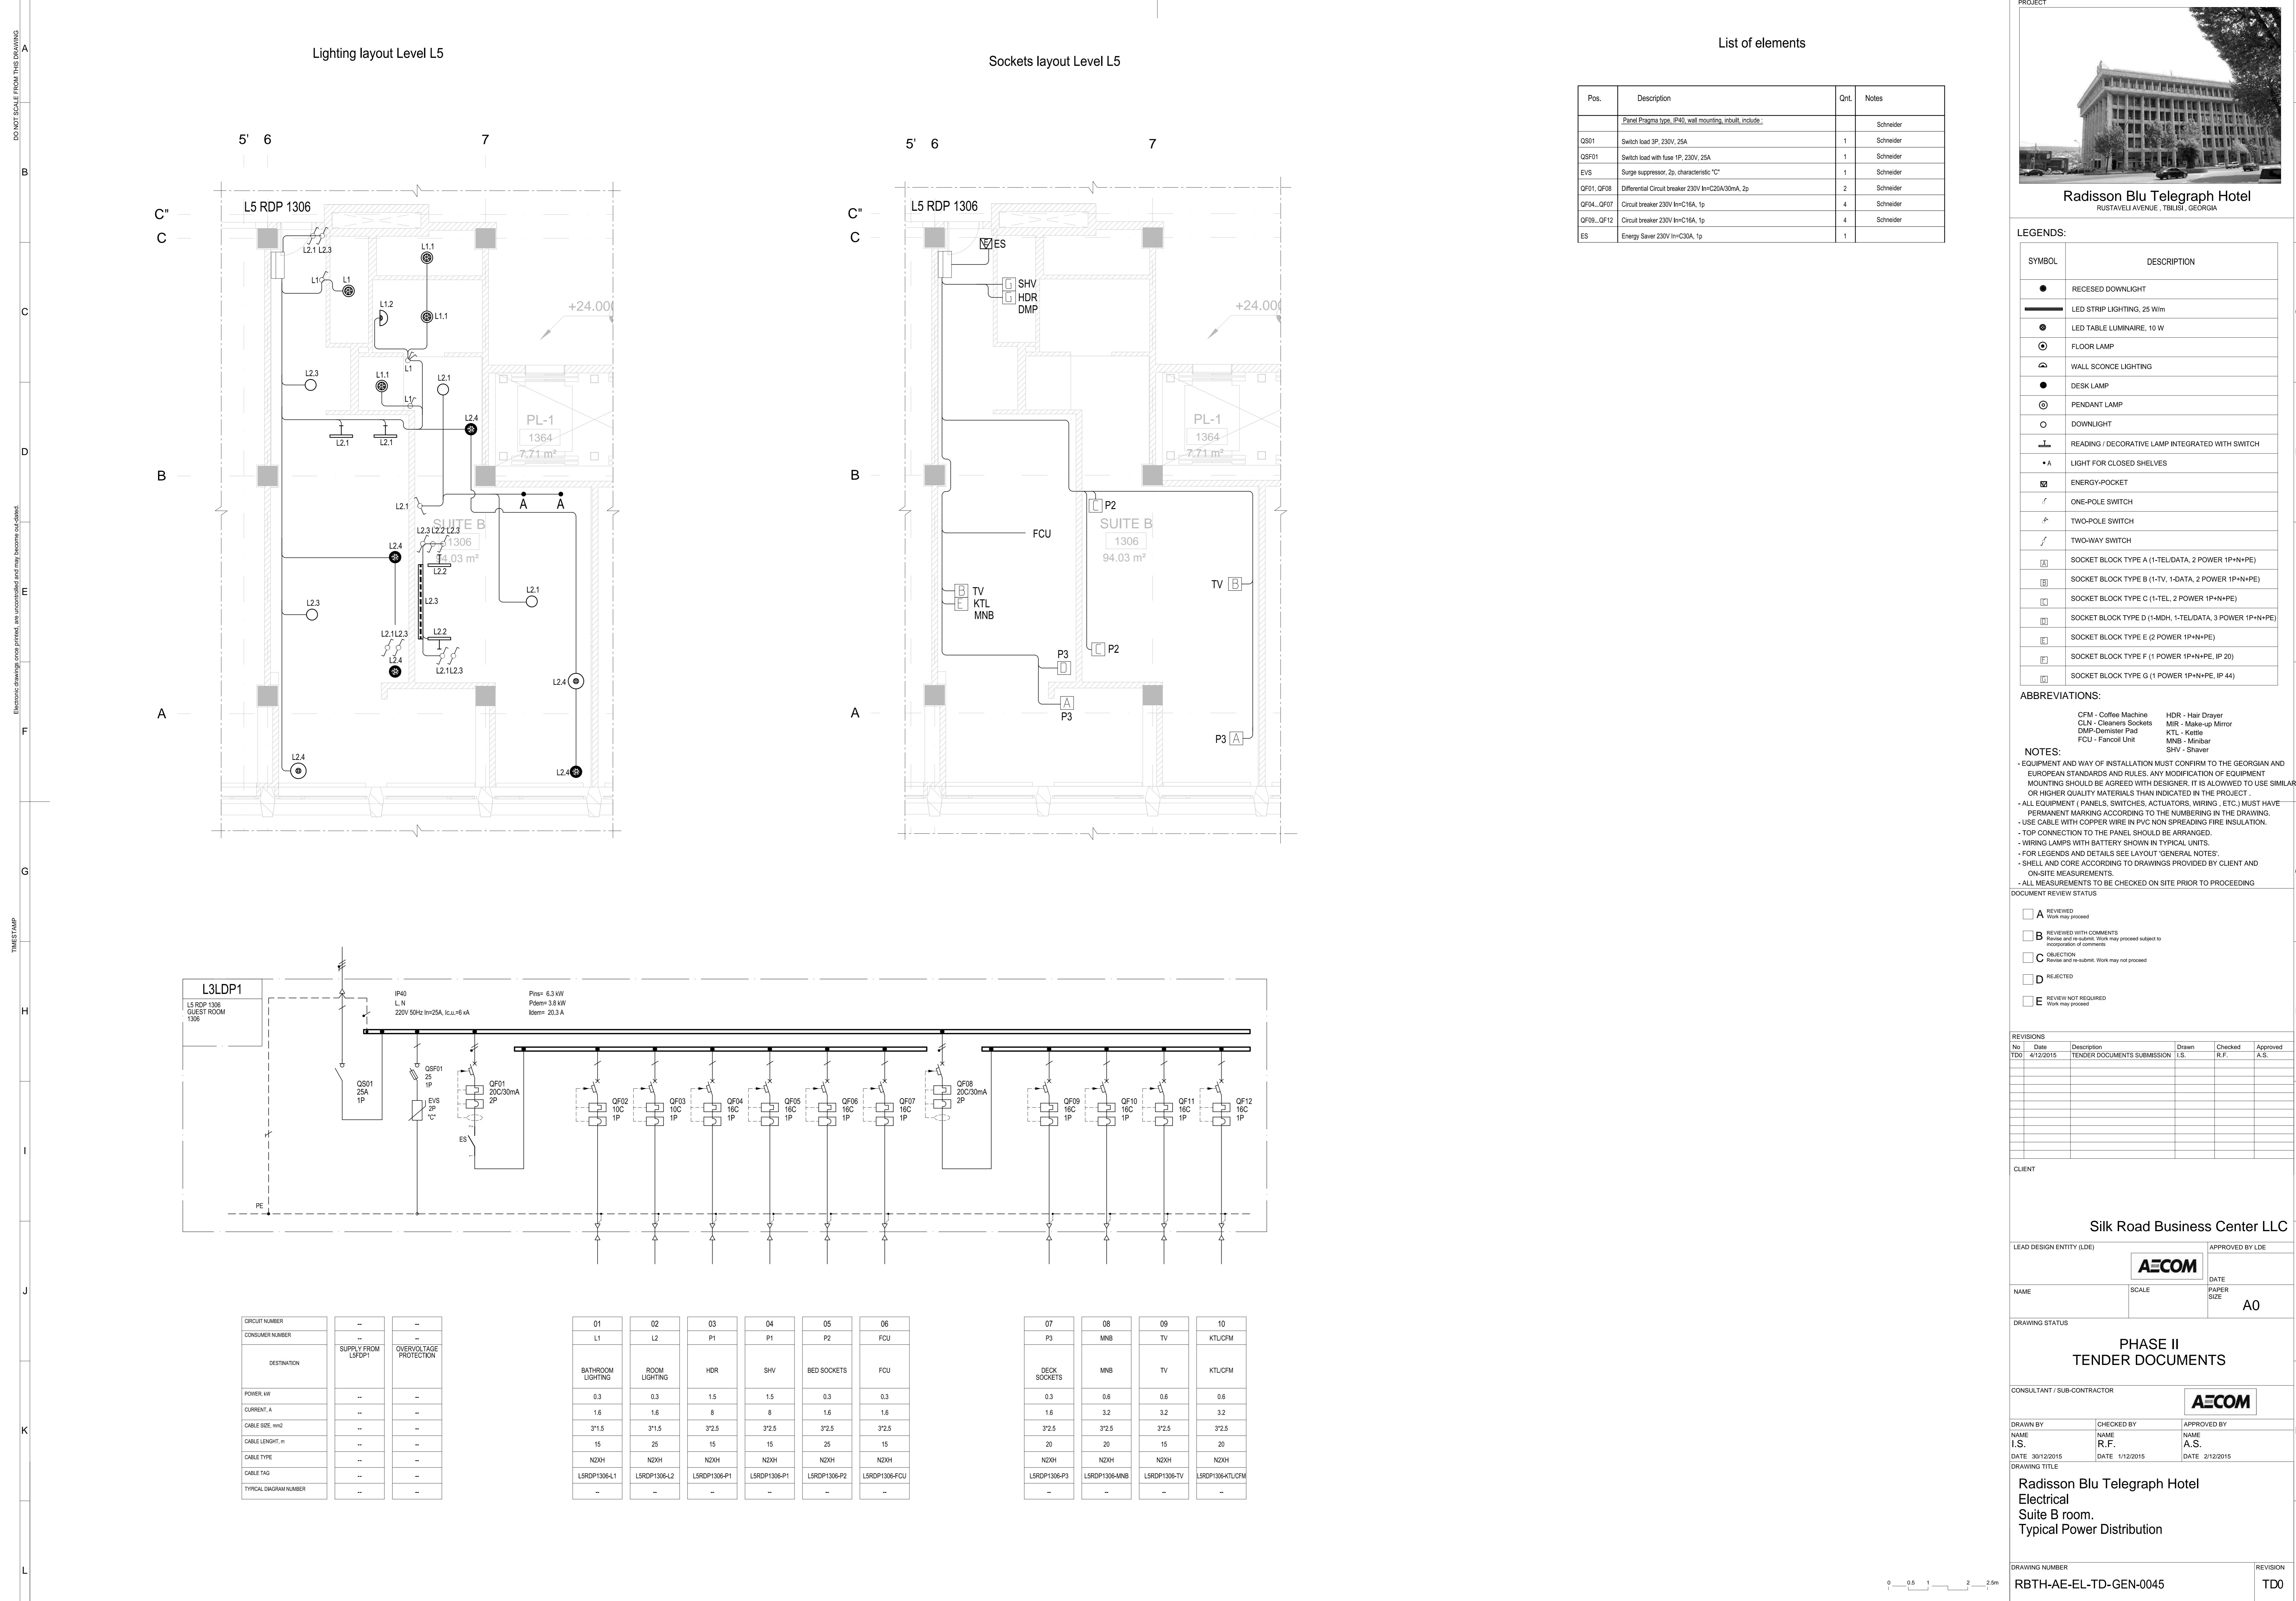

## List of elements

Pos.	Description	Qnt.	Notes
	Panel Pragma type, IP40, wall mounting, inbuilt, include:		Schneider
GS01	Switch load 3P, 230V, 25A	1	Schneider
GSF01	Switch load with fuse 1P, 230V, 25A	1	Schneider
EVS	Surge suppressor, Z <sub>0</sub> , characteristic 'C'	1	Schneider
QF01..QF08	Differential Circuit breaker 230V In=200A/30mA, 2P	2	Schneider
QF04..QF07	Circuit breaker 230V In=C16A, 1P	4	Schneider
QF09..QF12	Circuit breaker 230V In=C16A, 1P	4	Schneider
ES	Energy Saver 230V In=C30A, 1P	1	Schneider



Radisson Blu Telegraph Hotel

RUSTAVELI AVENUE, TBILISI, GEORGIA

## LEGENDS:

SYMBOL	DESCRIPTION
●	RECESSED DOWNLIGHT
—	LED STRIP LIGHTING, 25 W/m
◎	LED TABLE LUMINAIRE, 10 W
□	FLOOR LAMP
△	WALL SCONCE LIGHTING
●	DESK LAMP
○	PENDANT LAMP
○	DOWNLIGHT
—	READING L DECORATIVE LAMP INTEGRATED WITH SWITCH
• A	LIGHT FOR CLOSED SHELVES
☒	ENERGY-POCKET
□	ONE-POLE SWITCH
□	TWO-POLE SWITCH
□	TWO-WAY SWITCH
[A]	SOCKET BLOCK TYPE A (1-TEL/DATA, 2 POWER 1P+N+PE)
[B]	SOCKET BLOCK TYPE B (1-TV, 1-DATA, 2 POWER 1P+N+PE)
[C]	SOCKET BLOCK TYPE C (1-TEL, 2 POWER 1P+N+PE)
[D]	SOCKET BLOCK TYPE D (1-MDH, 1-TEL/DATA, 3 POWER 1P+N+PE)
[E]	SOCKET BLOCK TYPE E (2 POWER 1P+N+PE)
[F]	SOCKET BLOCK TYPE F (1 POWER 1P+N+PE, IP 20)
[G]	SOCKET BLOCK TYPE G (1 POWER 1P+N+PE, IP 44)

## ABBREVIATIONS:

CFM - Coffee Machine	HDR - Hair Dryer
CLN - Cleaners Sockets	MIR - Make-up Mirror
DMP - Demister Pad	KTL - Kettle
FCU - Fancoil Unit	MNB - Minibar
TV - Television	SHV - Shaver

## NOTES:

- EQUIPMENT AND WAY OF INSTALLATION MUST CONFORM TO THE GEORGIAN AND EUROPEAN STANDARDS AND RULES. ANY MODIFICATION OF EQUIPMENT MOUNTING SHOULD BE AGREED WITH DESIGNER. IT IS ALLOWED TO USE SIMILAR OR EQUIVALENT EQUIPMENT THAT HAS BEEN APPROVED BY THE OWNER.
- ALL EQUIPMENT (PANELS, SWITCHES, ACTUATORS, WIRES, ETC.) MUST HAVE PERMANENT MARKING ACCORDING TO THE NUMBERING IN THE DRAWING.
- USE CABLE WITH COPPER WIRE IN PVC NON SPREADING FIRE INSULATION.
- TOP CONNECTION TO THE PANEL SHOULD BE ARRANGED.
- WIRING LAMPS WITH BATTERY SHOWN IN TYPICAL UNITS.
- FOR LEGENDS AND DETAILS SEE LAYOUT GENERAL NOTES.
- SHELL AND CORE ACCORDING TO DRAWINGS PROVIDED BY CLIENT AND ON-SITE MEASUREMENTS.
- ALL MEASUREMENTS TO BE CHECKED ON SITE PRIOR TO PROCEEDING.

## DOCUMENT REVIEW STATUS:

<input type="checkbox"/> A	REVIEWED	Work may proceed
<input type="checkbox"/> B	REVIEWED WITH COMMENTS	Review and re-submit. Work may proceed subject to comments.
<input type="checkbox"/> C	OBJECTION	Objection. Review and re-submit. Work may not proceed.
<input type="checkbox"/> D	REJECTED	Rejected. Work may not proceed.
<input type="checkbox"/> E	REVIEW NOT REQUIRED	Work may proceed

## REVISIONS:

No	Date	Description	Drawn	Checked	Approved
T00	4/12/2015	TENDER DOCUMENTS SUBMISSION	I.S.	R.F.	A.S.

## CLIENT:

Silk Road Business Center LLC

LEAD DESIGN ENTITY (LDE) APPROVED BY LDE

AECOM DATE

NAME SCALE PAPER SIZE A0

## DRAWING STATUS

PHASE II  
TENDER DOCUMENTS

CONSULTANT / SUB-CONTRACTOR

AECOM

DRAWN BY CHECKED BY APPROVED BY

I.S. NAME NAME NAME

R.F. NAME NAME NAME

A.S. DATE 2/12/2015

DATE 30/12/2015

DRAWING TITLE

Radisson Blu Telegraph Hotel

Electrical


Suite C room.

Typical Power Distribution



DRAWING NUMBER REVISION

RBTH-AE-EL-TD-GEN-0046 TDO

## Lighting layout Level L5

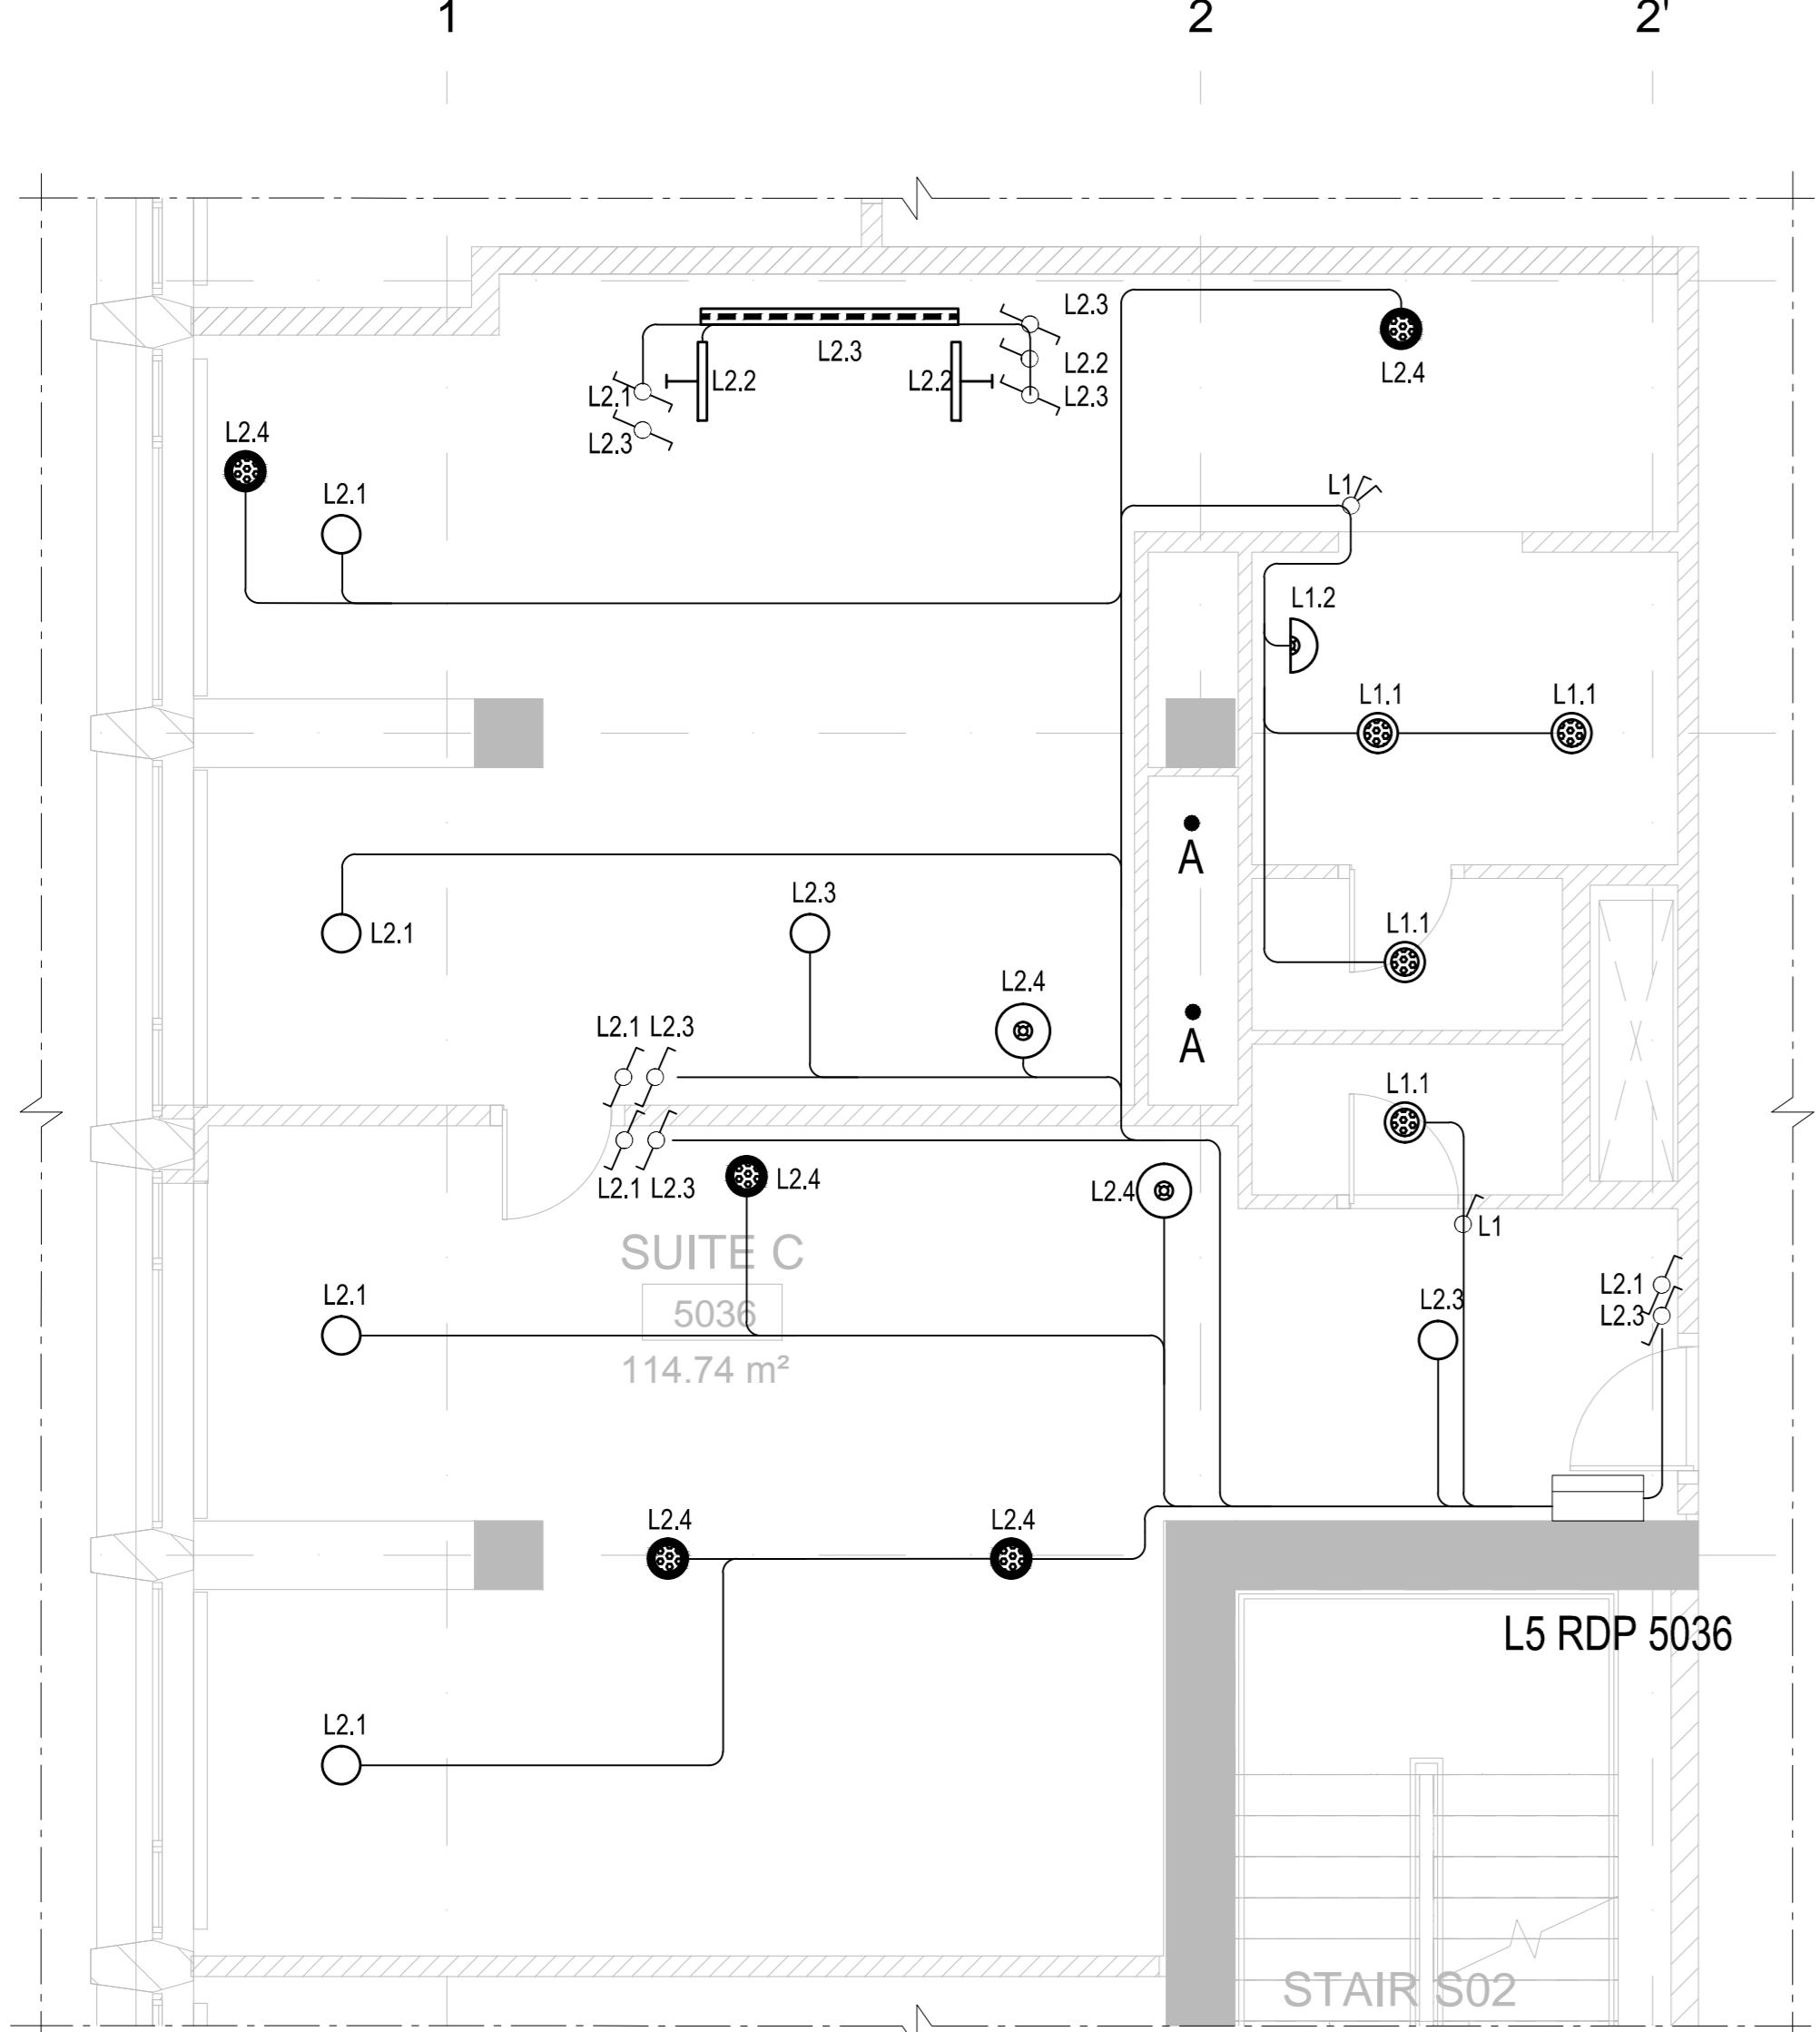

## Sockets layout Level L5

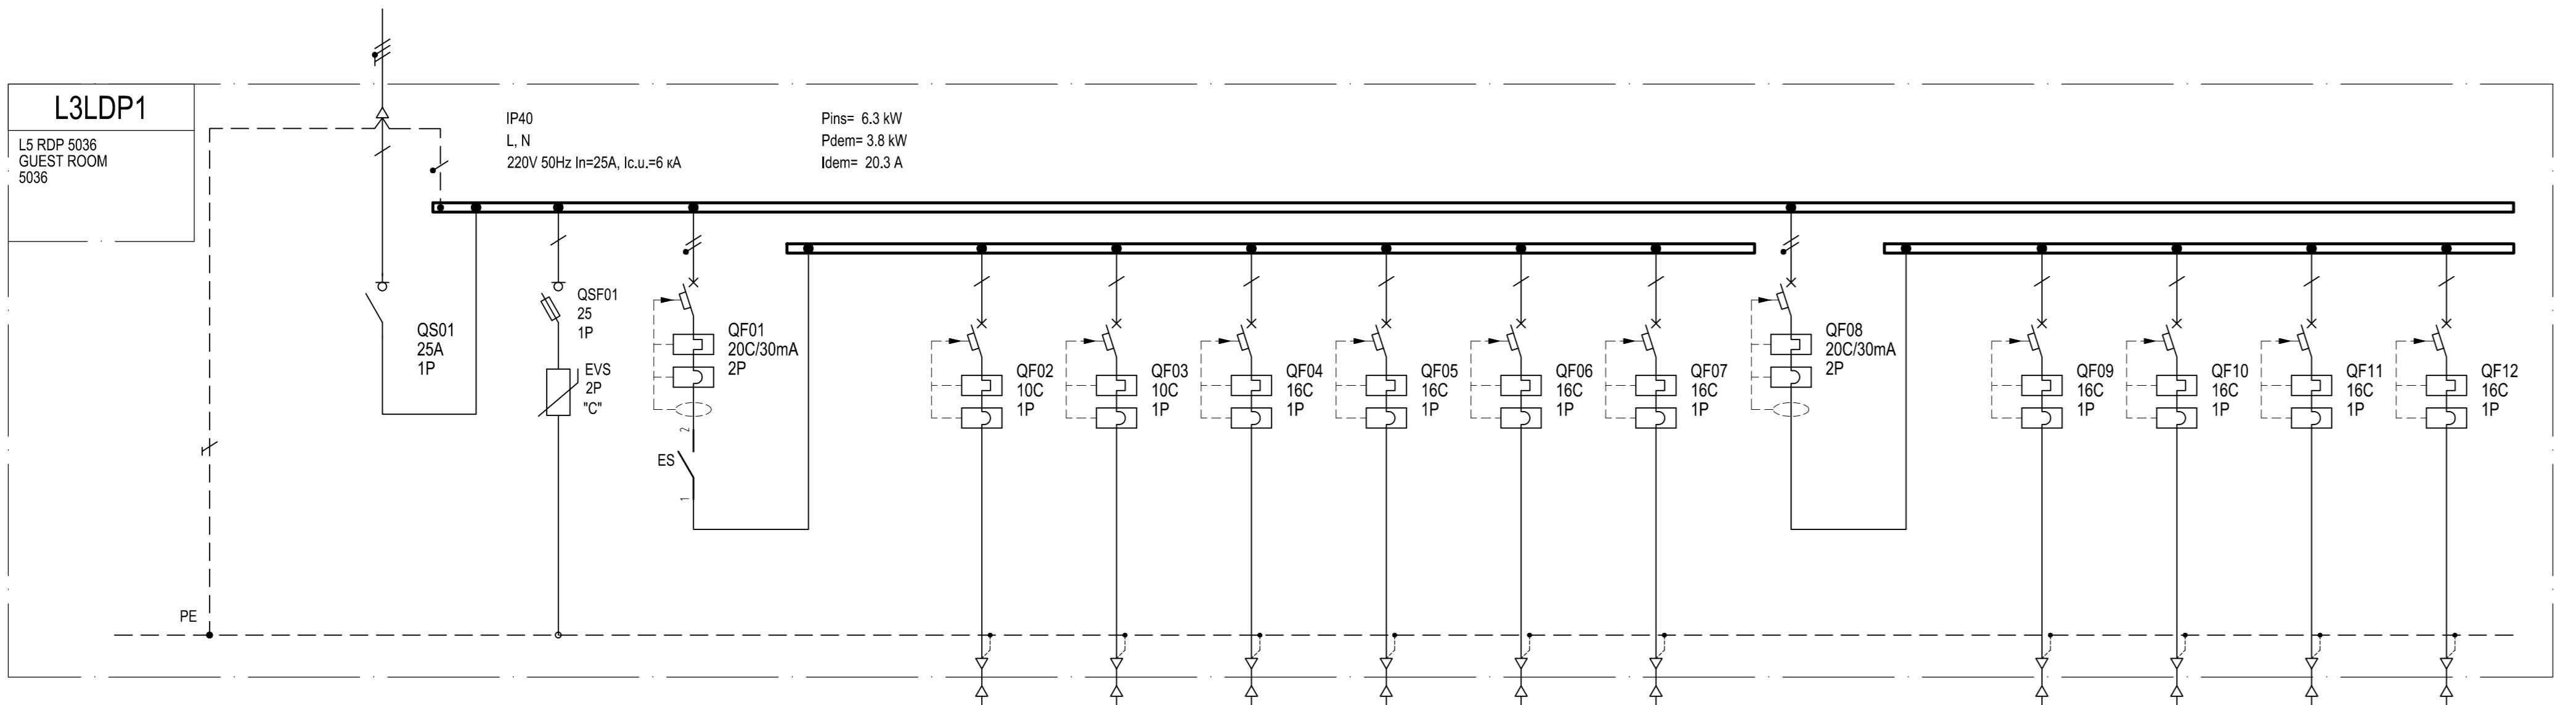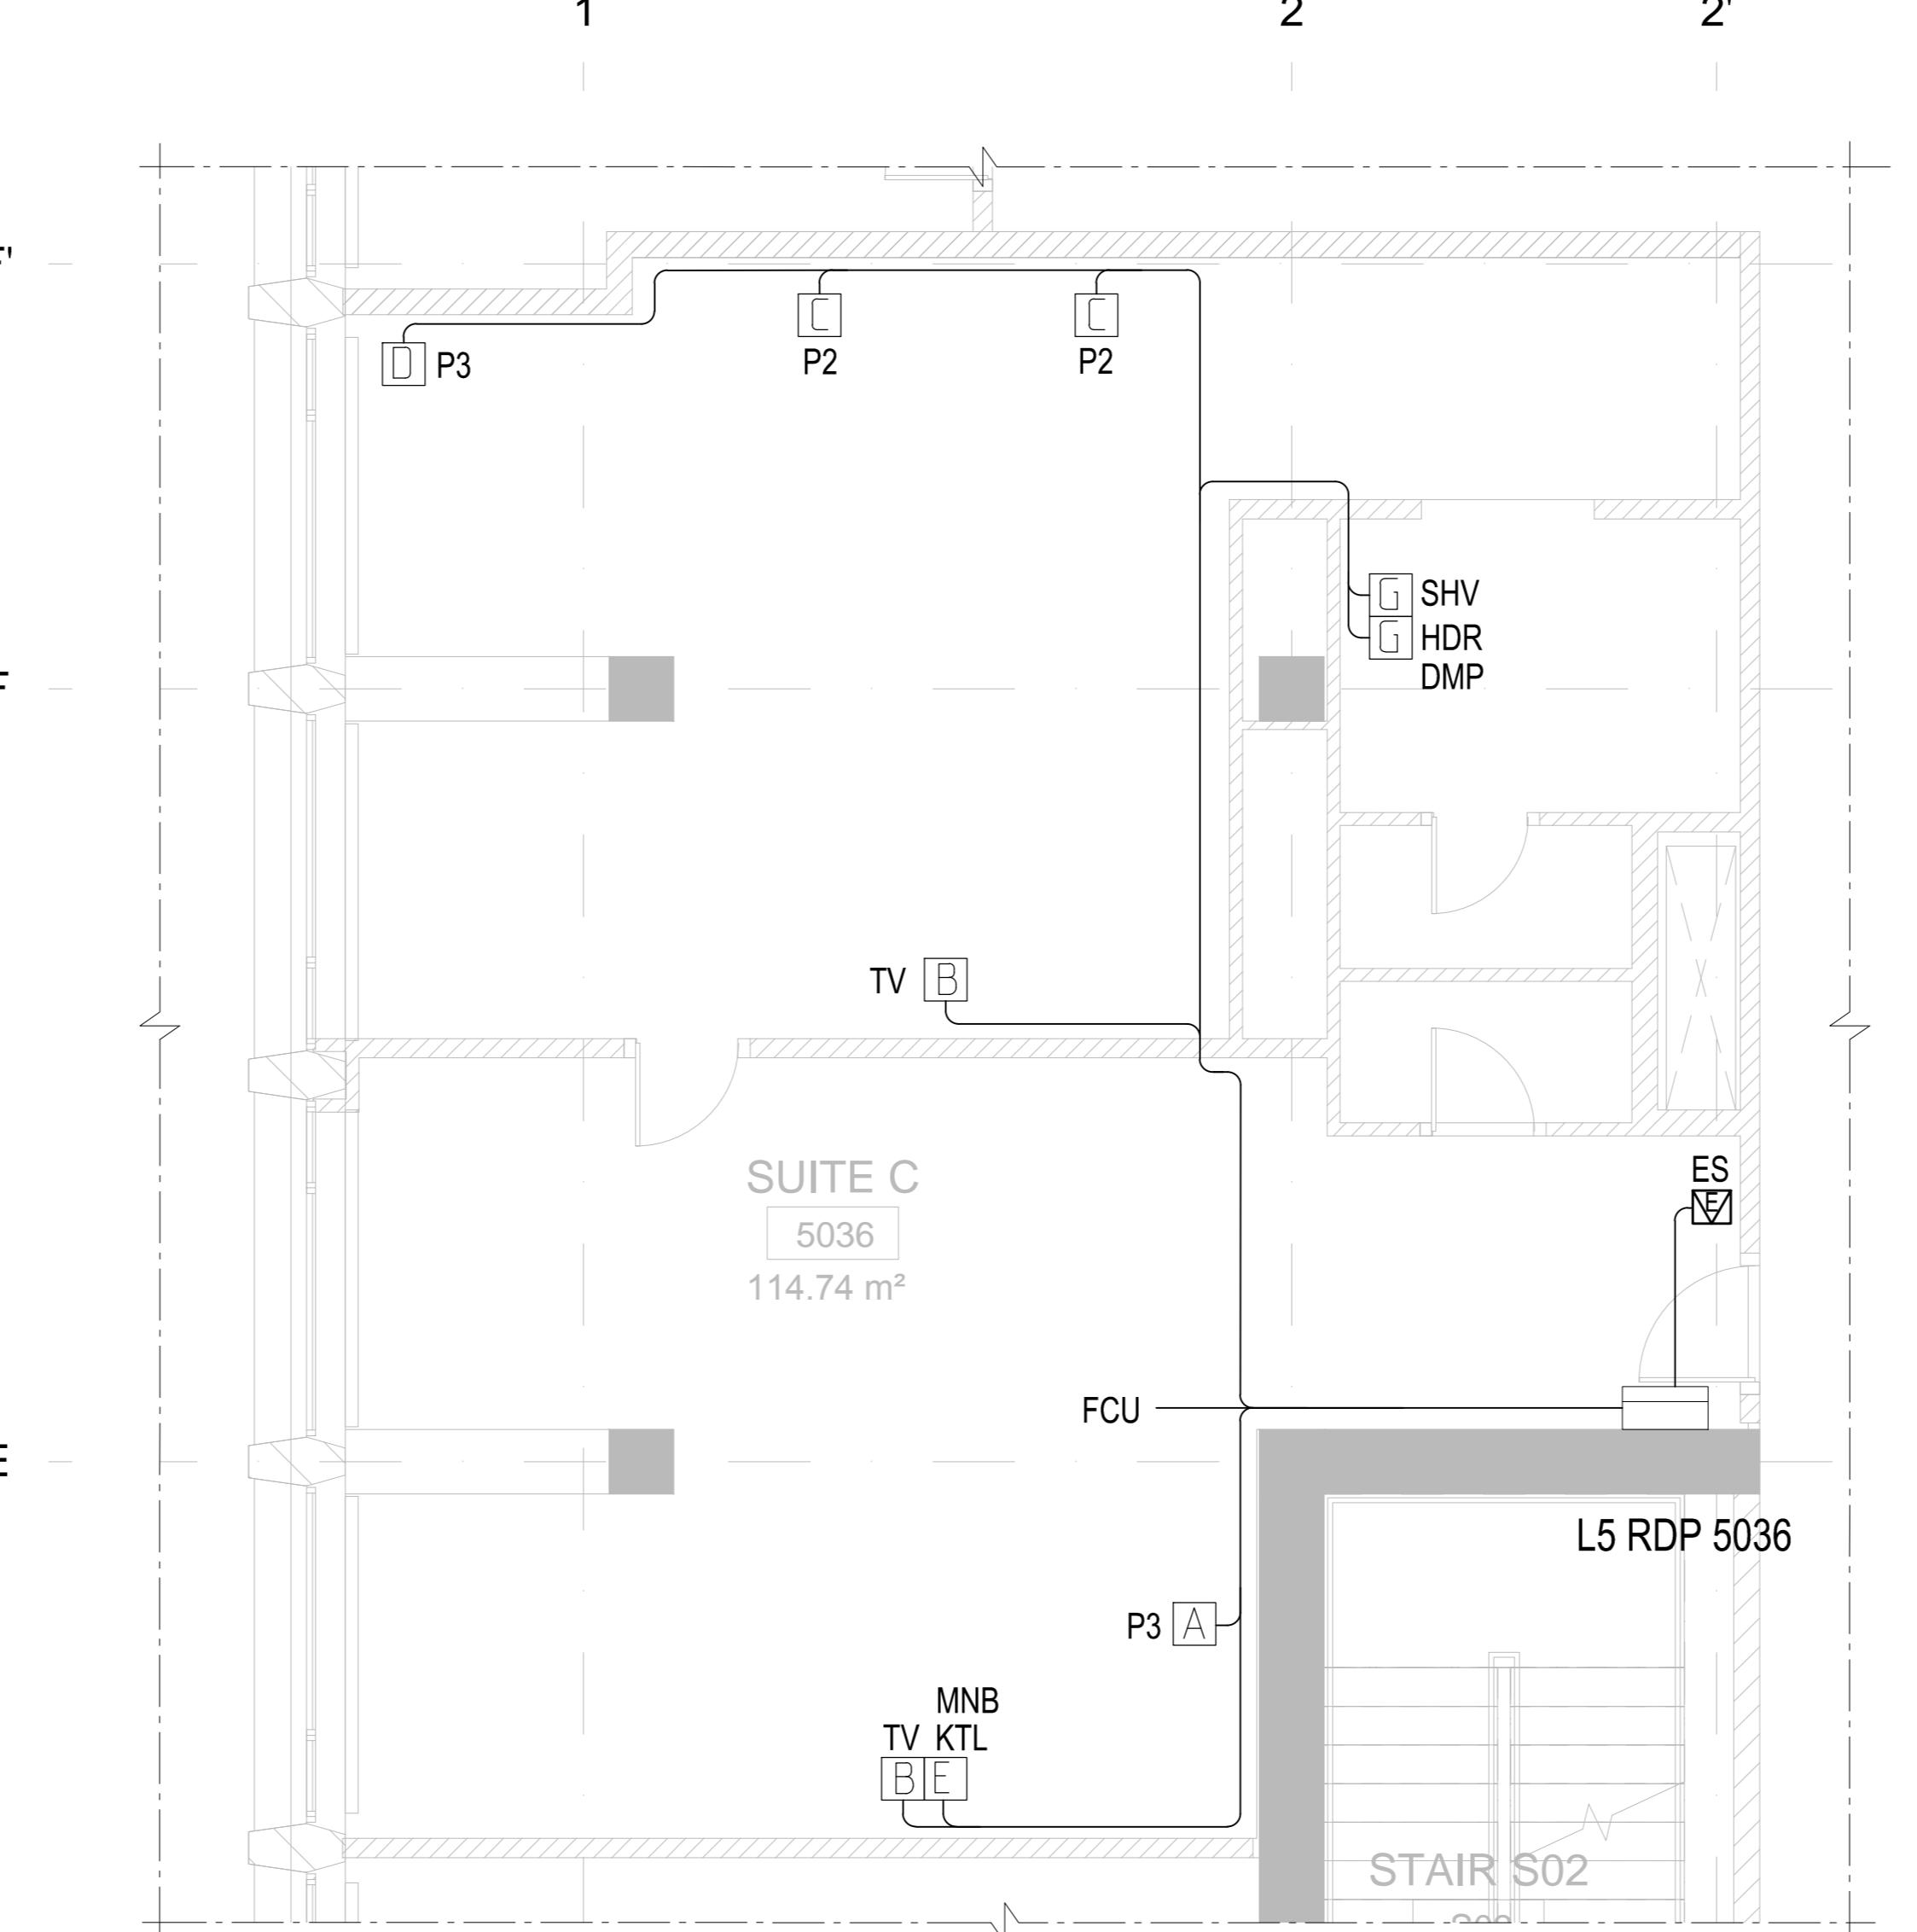

CIRCUIT NUMBER	CONSUMER NUMBER	—	—
DESTINATION	SUPPLY FROM L3LDP1	OVERVOLTAGE PROTECTION	—
POWER kW	—	—	—
CURRENT A	—	—	—
CABLE SIZE, mm²	—	—	—
CABLE LENGTH, m	—	—	—
CABLE TYPE	—	—	—
CABLE TAG	—	—	—
TYPICAL DIAGRAM NUMBER	—	—	—

01	02	03	04	05	06	07	08	09	10
L1	L2	P1	P1	P2	FCU	DECK SOCKETS	MNB	TV	KTL/CFM
BATHROOM LIGHTING	ROOM LIGHTING	HDR	SHV	BED SOCKETS	FCU	DECK SOCKETS	MNB	TV	KTL/CFM
0.3	0.3	1.5	1.5	0.3	0.3	0.3	0.6	0.6	0.6
1.6	1.6	8	8	1.6	1.6	1.6	3.2	3.2	3.2
31.5	31.5	32.5	32.5	32.5	32.5	32.5	20	15	20
15	25	15	15	25	15	20	20	15	20
NZXH	NZXH	NZXH	NZXH	NZXH	NZXH	NZXH	NZXH	NZXH	NZXH
L5RDP5036-L1	L5RDP5036-L2	L5RDP5036-P1	L5RDP5036-P1	L5RDP5036-P2	L5RDP5036-FCU	L5RDP5036-P3	L5RDP5036-MNB	L5RDP5036-TV	L5RDP5036-KTL/CFM

## List of elements

Pos.	Description	Qnt.	Notes
	Panel Pragma type IP40, wall mounting, built-in:		Schneider
QS01	Switch load 3P, 230V, 25A	1	Schneider
QSFO1	Switch load with fuse 1P, 230V, 25A	1	Schneider
EVS	Surge suppressor, 2p, characteristic "C"	1	Schneider
QF01..QF08	Differential Circuit breaker 230V In=C16A/30mA, 2p	2	Schneider
QF04..QF07	Circuit breaker 230V In=C16A, 1p	4	Schneider
QF09..QF12	Circuit breaker 230V In=C16A, 1p	4	Schneider
ES	Energy Saver 230V In=C30A, 1p	1	Schneider



Radisson Blu Telegraph Hotel

RUSTAVELI AVENUE, TBILISI, GEORGIA

## LEGENDS:

SYMBOL	DESCRIPTION
●	RECESSED DOWNLIGHT
—	LED STRIP LIGHTING, 25 W/m
○	LED TABLE LUMINAIRE, 10 W
□	FLOOR LAMP
△	WALL SCONCE LIGHTING
●	DESK LAMP
◎	PENDANT LAMP
○	DOWNLIGHT
—	READING L/ DECORATIVE LAMP INTEGRATED WITH SWITCH
• A	LIGHT FOR CLOSED SHELVES
☒	ENERGY-POCKET
▢	ONE-POLE SWITCH
▢	TWO-POLE SWITCH
▢	TWO-WAY SWITCH
▢ A	SOCKET BLOCK TYPE A (1-TEL/DATA, 2 POWER 1P+N+PE)
▢ B	SOCKET BLOCK TYPE B (1-TV, 1-DATA, 2 POWER 1P+N+PE)
▢ C	SOCKET BLOCK TYPE C (1-TEL, 2 POWER 1P+N+PE)
▢ D	SOCKET BLOCK TYPE D (1-MDH, 1-TEL/DATA, 3 POWER 1P+N+PE)
▢ E	SOCKET BLOCK TYPE E (2 POWER 1P+N+PE)
▢ F	SOCKET BLOCK TYPE F (1 POWER 1P+N+PE, IP 20)
▢ G	SOCKET BLOCK TYPE G (1 POWER 1P+N+PE, IP 44)

## ABBREVIATIONS:

CFM - Coffee Machine HDR - Hair Dryer  
 CLN - Cleaners Sockets MIR - Make-up Mirror  
 DMP - Demister Pad KTL - Kettle  
 FCU - Fancoil Unit MNH - Minibar  
 SHV - Shaver

## NOTES:

- EQUIPMENT AND WAY OF INSTALLATION MUST CONFORM TO THE GEORGIAN AND EUROPEAN STANDARDS AND RULES. ANY MODIFICATION OF EQUIPMENT MOUNTING SHOULD BE AGREED WITH DESIGNER. IT IS ALLOWED TO USE SIMILAR OR EQUIVALENT EQUIPMENT AS THAT WHICH IS SHOWN IN THE DRAWINGS.
- ALL EQUIPMENT PANELS, SWITCHES, ACTUATORS, WIRES, ETC., MUST HAVE PERMANENT MARKING ACCORDING TO THE NUMBERING IN THE DRAWING.
- USE CABLE WITH COPPER WIRE IN PVC NON SPREADING FIRE INSULATION.
- TOP CONNECTION TO THE PANEL SHOULD BE ARRANGED.
- WIRING LAMPS WITH BATTERY SHOWN IN TYPICAL UNITS.
- FOR LEGENDS AND DETAILS SEE LAYOUT GENERAL NOTES.
- SHELL AND CORE ACCORDING TO DRAWINGS PROVIDED BY CLIENT AND ON-SITE MEASUREMENTS.
- ALL MEASUREMENTS TO BE CHECKED ON SITE PRIOR TO PROCEEDING.

## DOCUMENT REVIEW STATUS:

- A REVIEWED Work may proceed  
 B REVIEWED WITH COMMENTS Review and re-submit. Work may proceed subject to comments.  
 C OBJECTION Review and re-submit. Work may not proceed.  
 D REJECTED Work may not proceed.  
 E REVIEW NOT REQUIRED Work may proceed.

## REVISIONS:

No	Date	Description	Drawn	Checked	Approved
T00	4/12/2015	TENDER DOCUMENTS SUBMISSION	I.S.	R.F.	A.S.

## CLIENT:

Silk Road Business Center LLC

LEAD DESIGN ENTITY (LDE) APPROVED BY LDE  
**AECOM**

NAME SCALE PAPER SIZE  
**A0**

## DRAWING STATUS

## PHASE II

## TENDER DOCUMENTS

## CONSULTANT / SUB-CONTRACTOR

DRAWN BY CHECKED BY APPROVED BY  
**AECOM**

NAME NAME NAME  
**I.S.** **R.F.** **A.S.**

DATE DATE DATE  
**30/12/2015** **1/12/2015** **2/12/2015**




DRAWING TITLE  
**Radisson Blu Telegraph Hotel**

Electrical  
 Suite D room.  
 Typical Power Distribution

DRAWING NUMBER REVISION  
**RBTH-AE-EL-TD-GEN-0047** **T00**

## Lighting layout Level L6


## Sockets layout Level L6

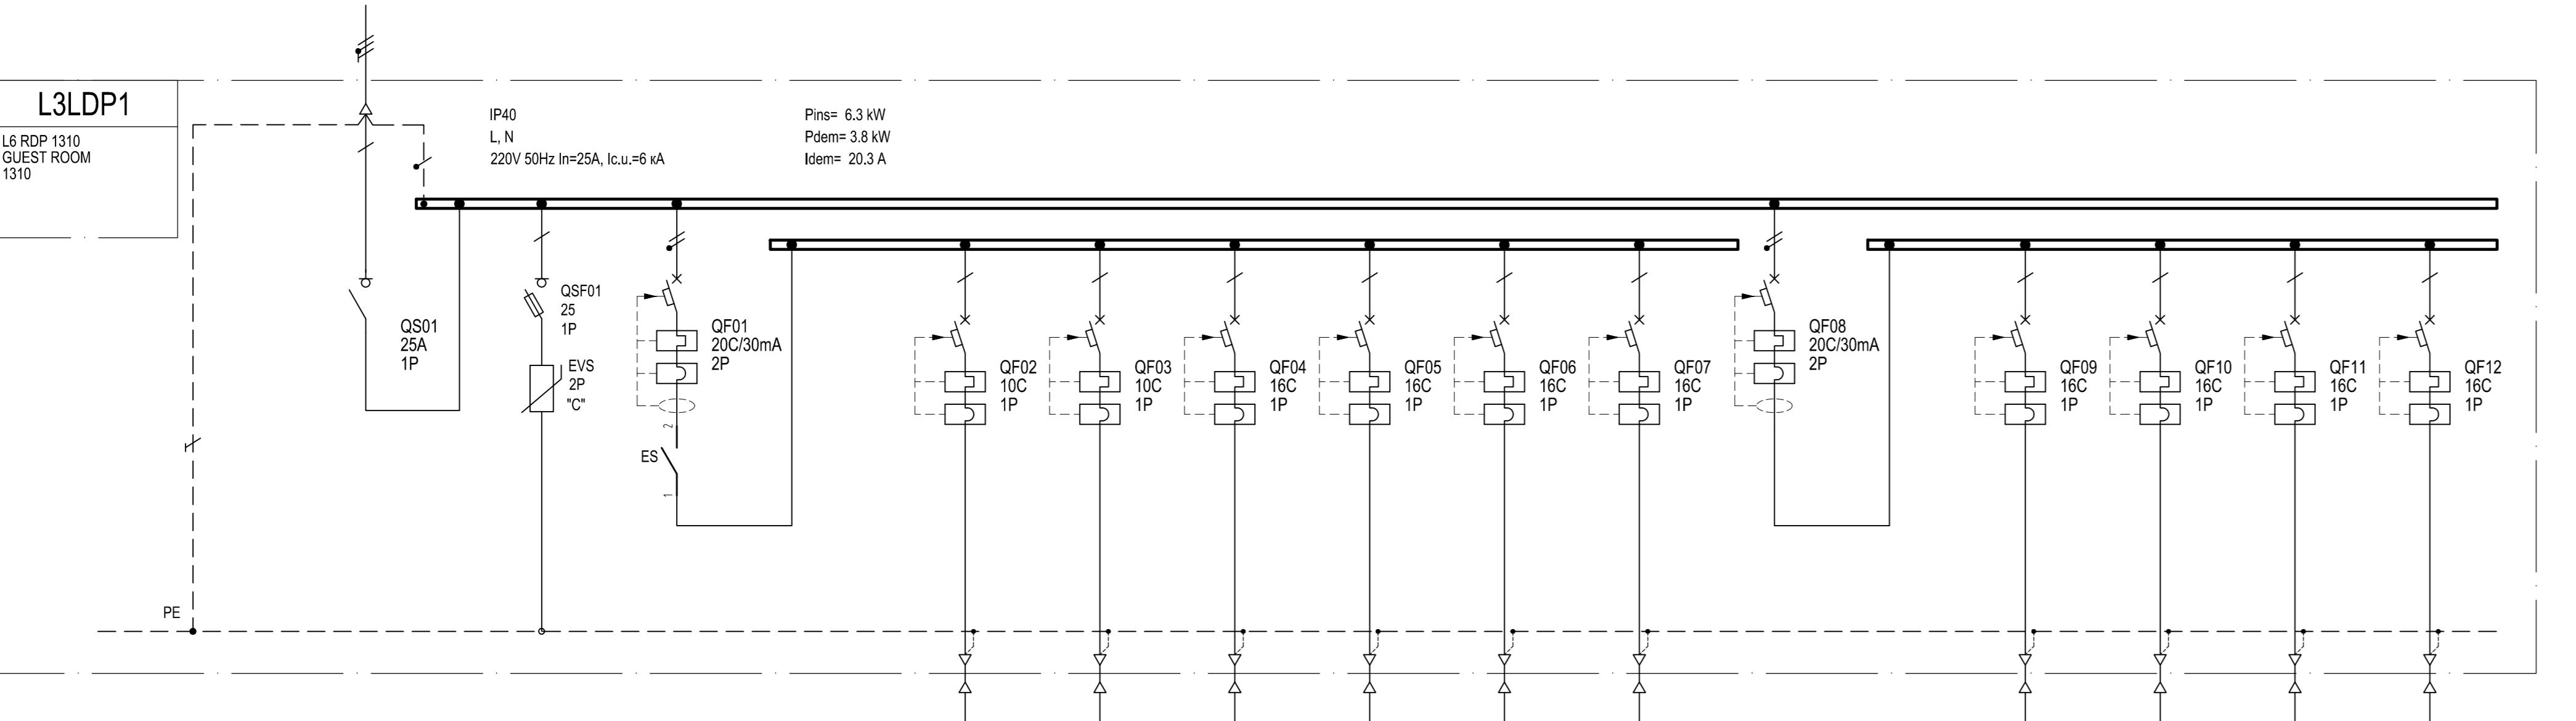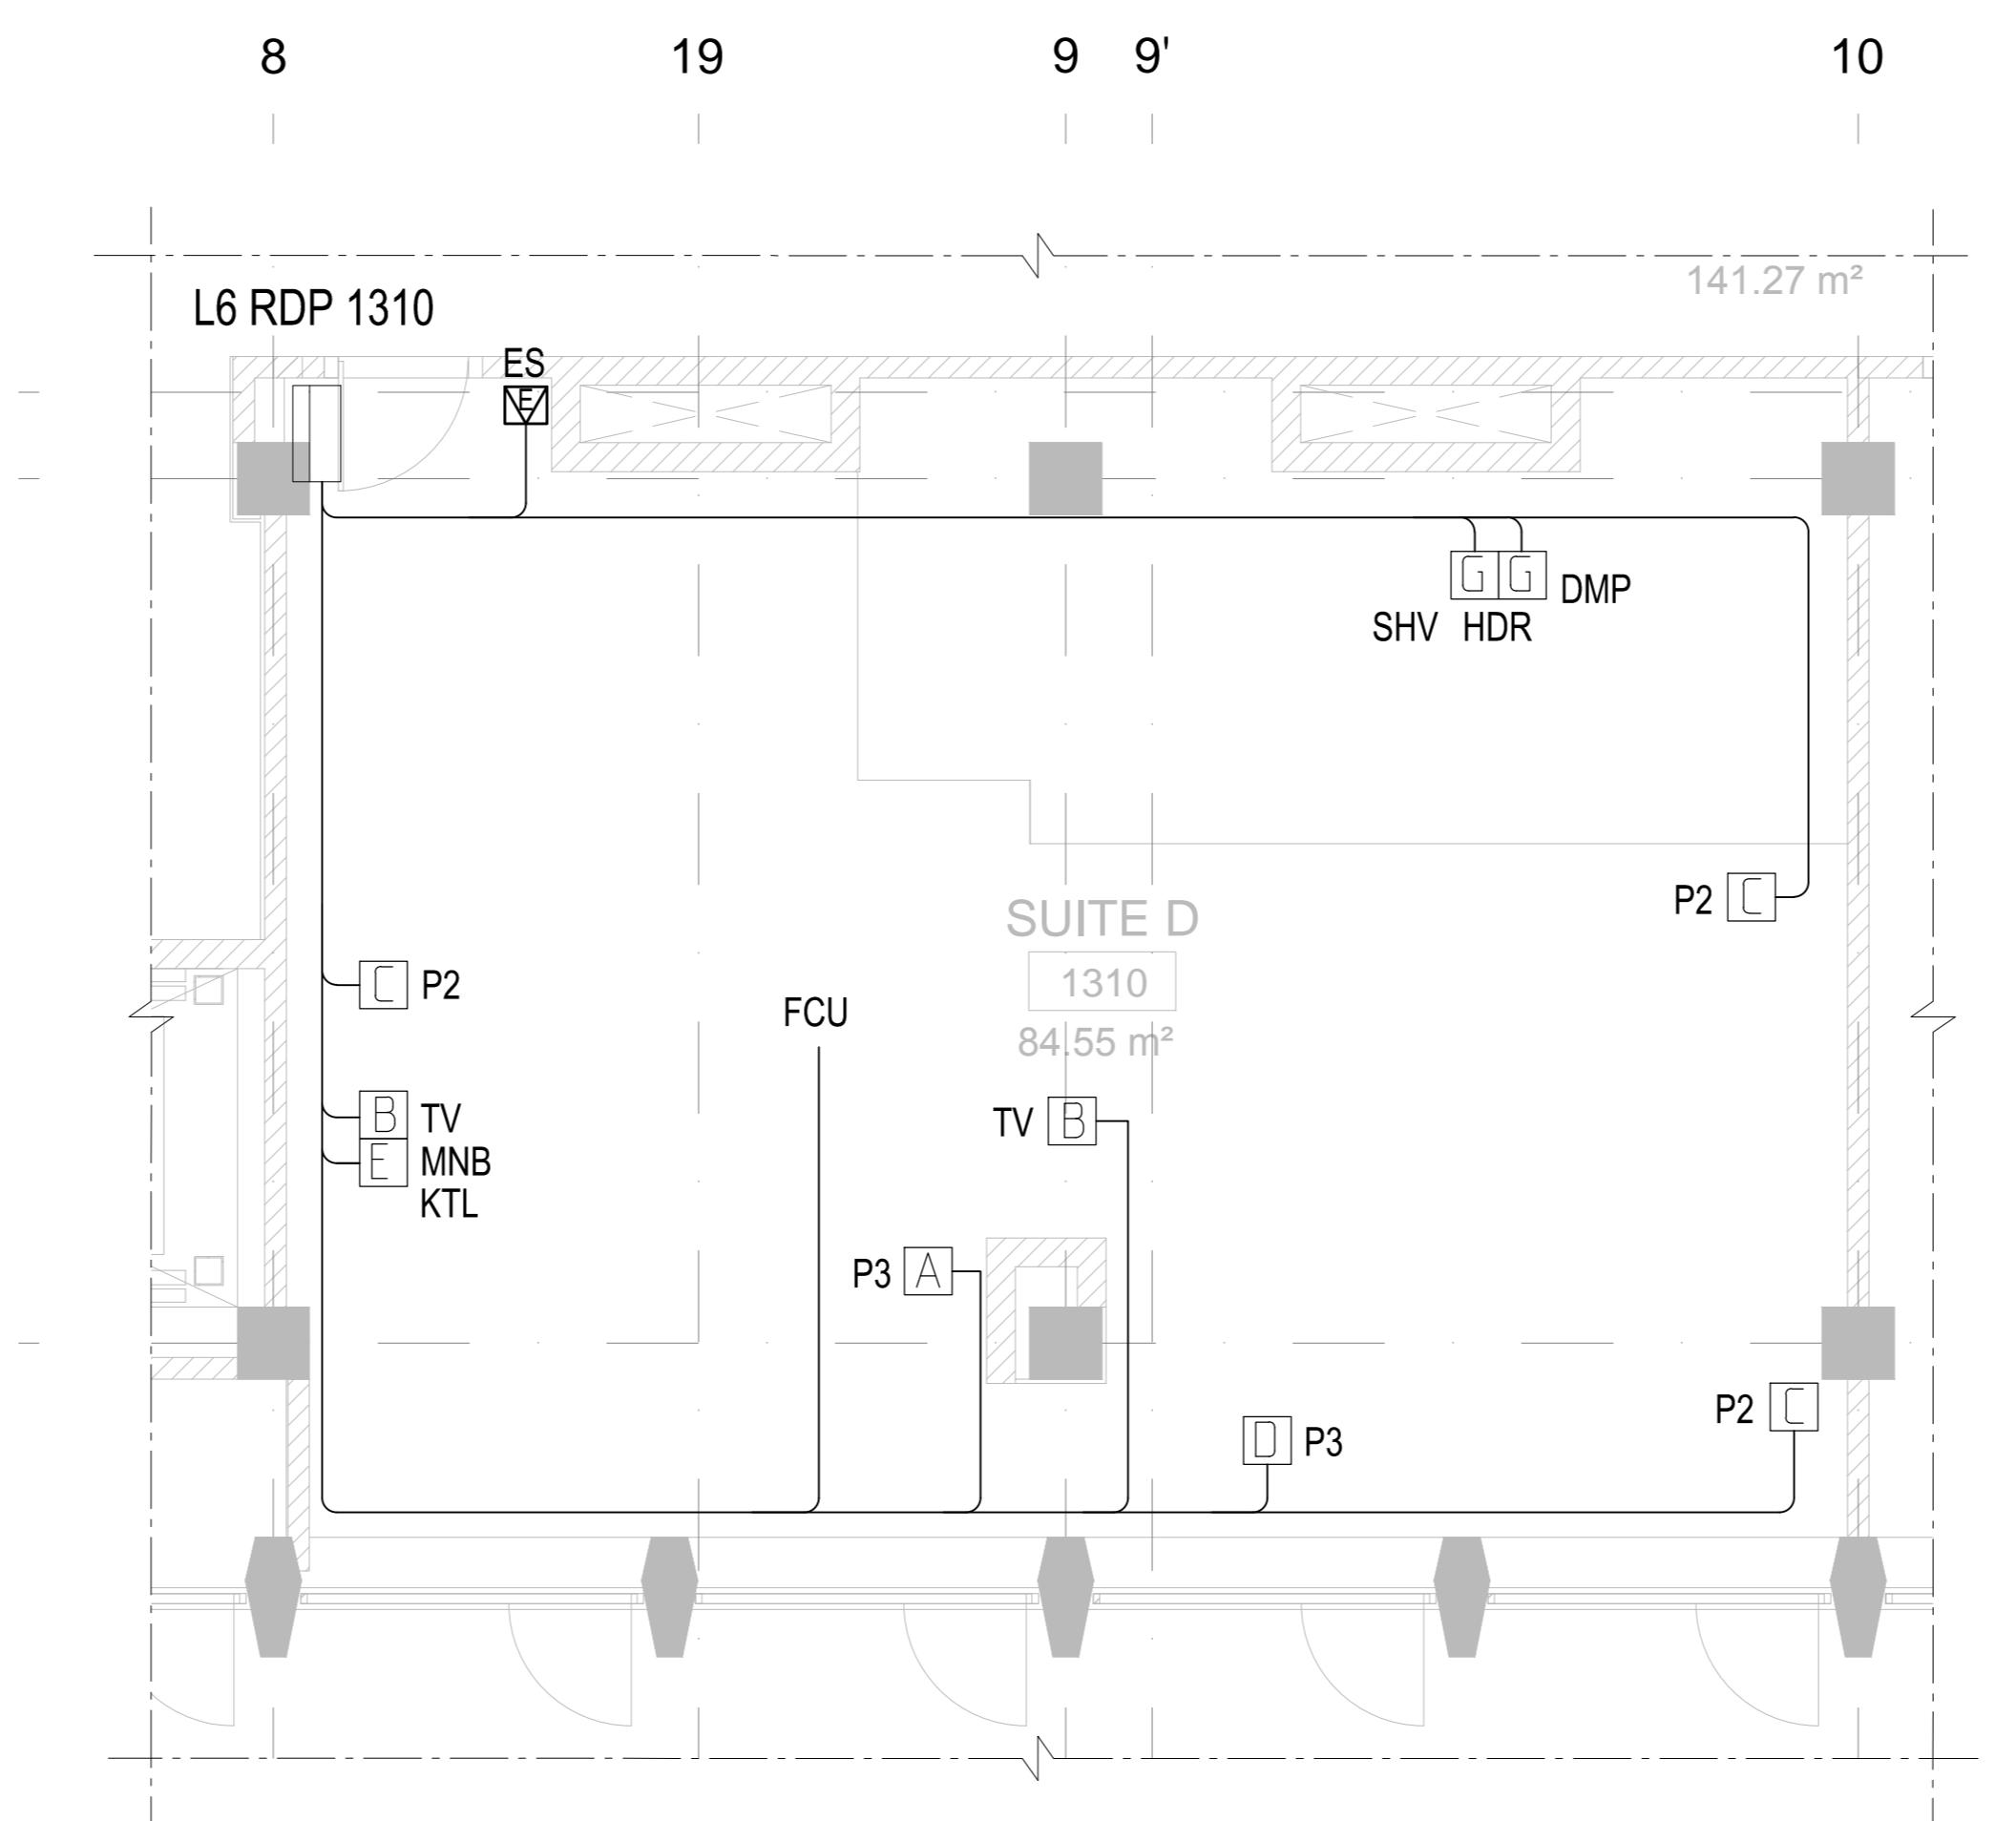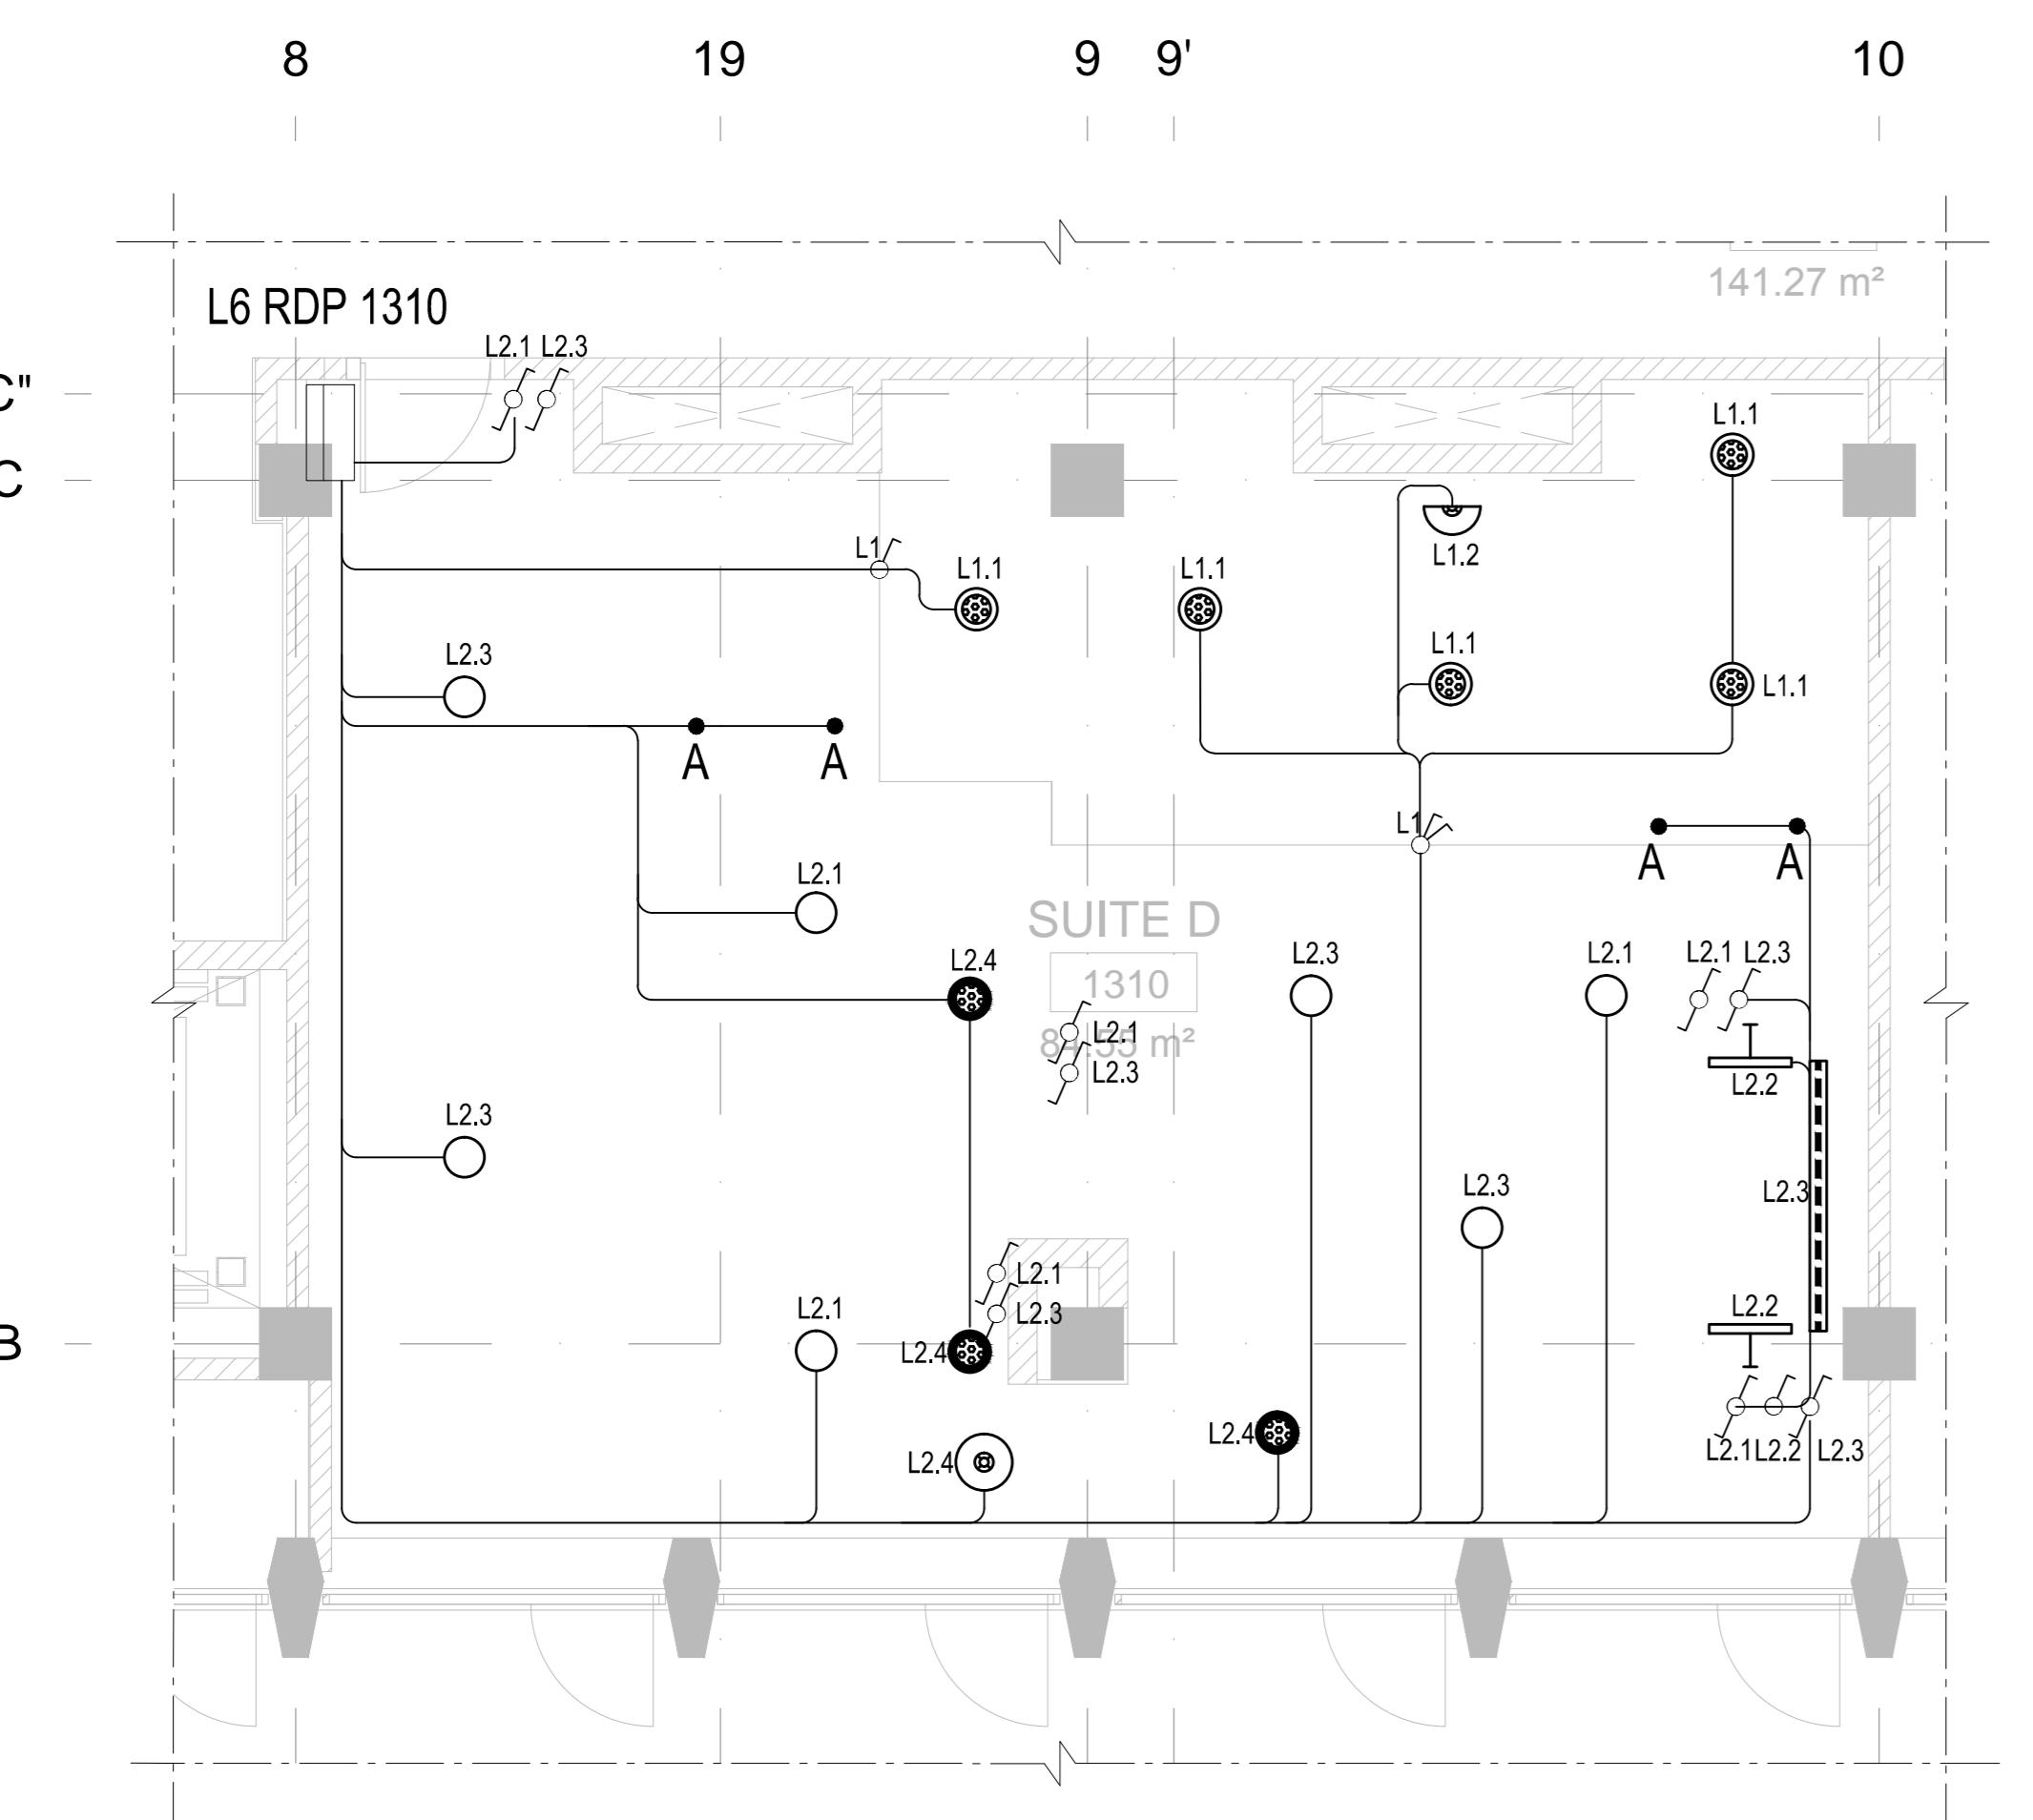



CIRCUIT NUMBER	CONSUMER NUMBER	—	—
DESTINATION	SUPPLY FROM UBDP1	OVERVOLTAGE PROTECTION	—
POWER kW	—	—	—
CURRENT A	—	—	—
CABLE SIZE, mm²	—	—	—
CABLE LENGTH, m	—	—	—
CABLE TYPE	—	—	—
CABLE TAG	—	—	—
TYPICAL DIAGRAM NUMBER	—	—	—


01	02	03	04	05	06	07	08	09	10
BATHROOM LIGHTING	ROOM LIGHTING	HDR	SHV	BED SOCKETS	FCU	DECK SOCKETS	MNH	TV	KTL/CFM
0.3	0.3	1.5	1.5	0.3	0.3	0.3	0.6	0.6	0.6
1.6	1.6	8	8	1.6	1.6	1.6	3.2	3.2	3.2
31.5	31.5	3'2.5	3'2.5	3'2.5	3'2.5	3'2.5	3'2.5	3'2.5	3'2.5
15	25	15	15	25	15	20	20	15	20
NZXH	NZXH	NZXH	NZXH	NZXH	NZXH	NZXH	NZXH	NZXH	NZXH
L6RDP1310-L1	L6RDP1310-L2	L6RDP1310-P1	L6RDP1310-P2	L6RDP1310-FCU	L6RDP1310-P3	L6RDP1310-MNH	L6RDP1310-TV	L6RDP1310-KTL/CFM	—


0 0.5 1 2 2.5m

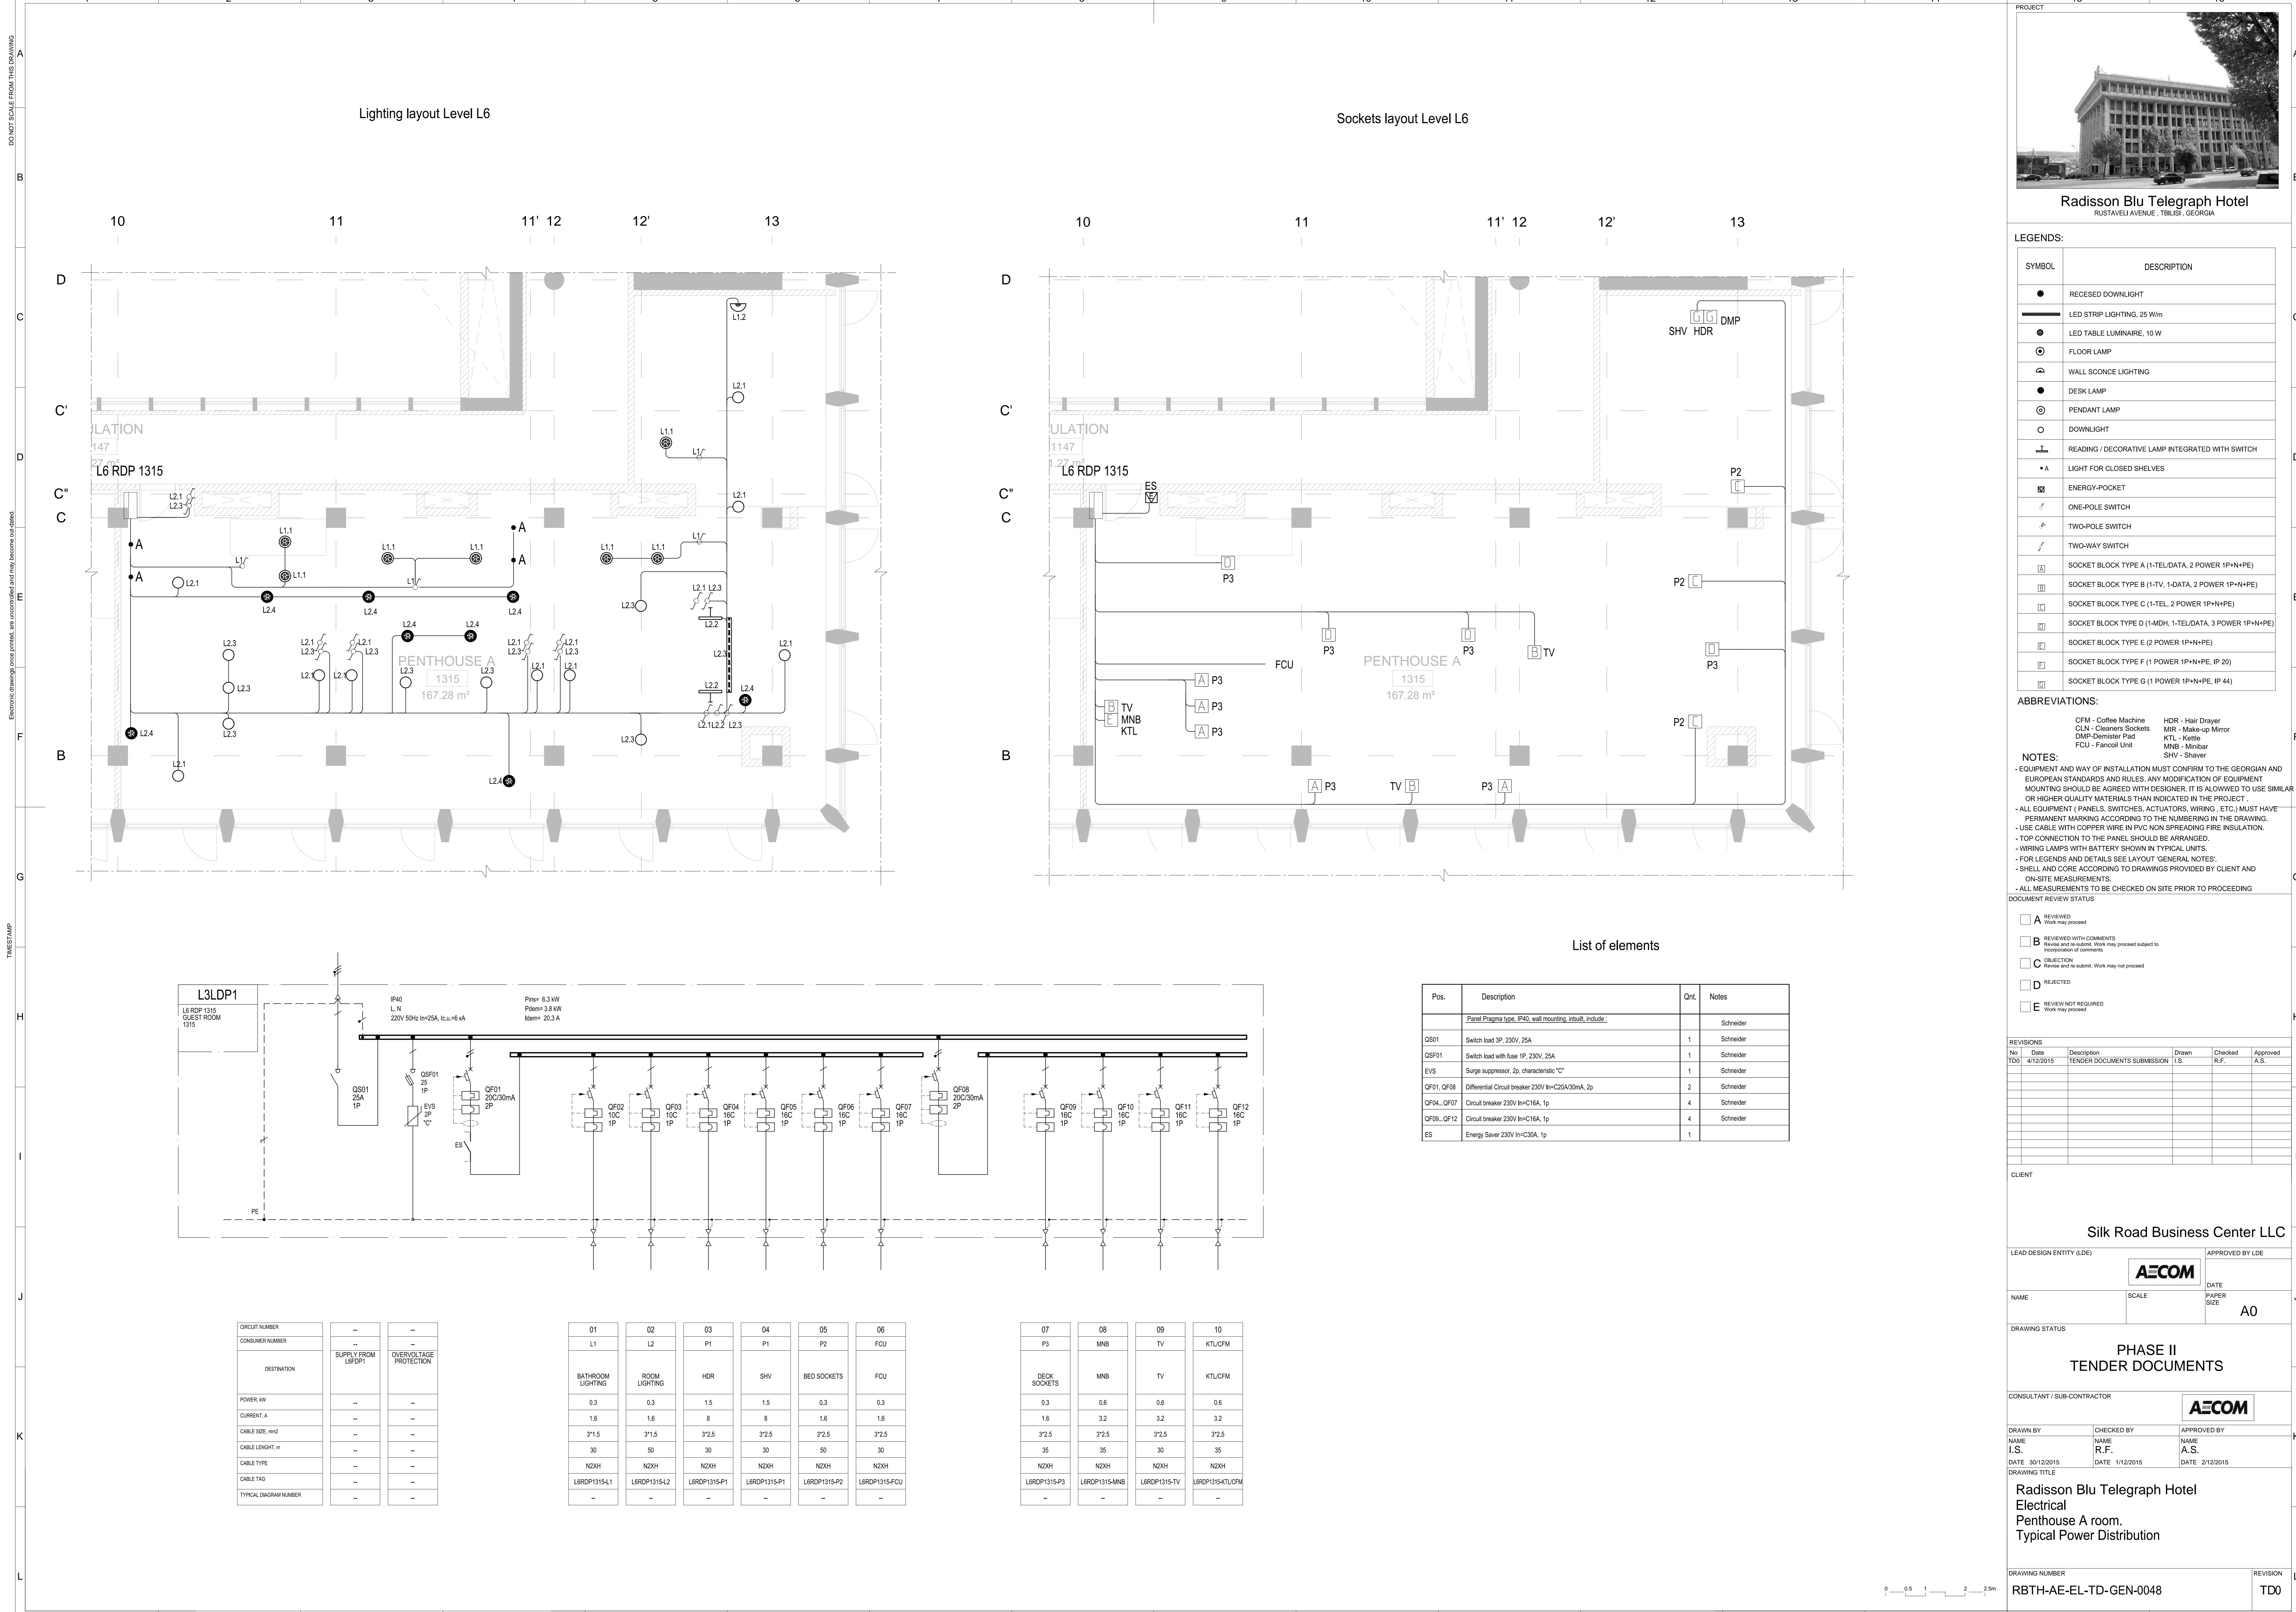

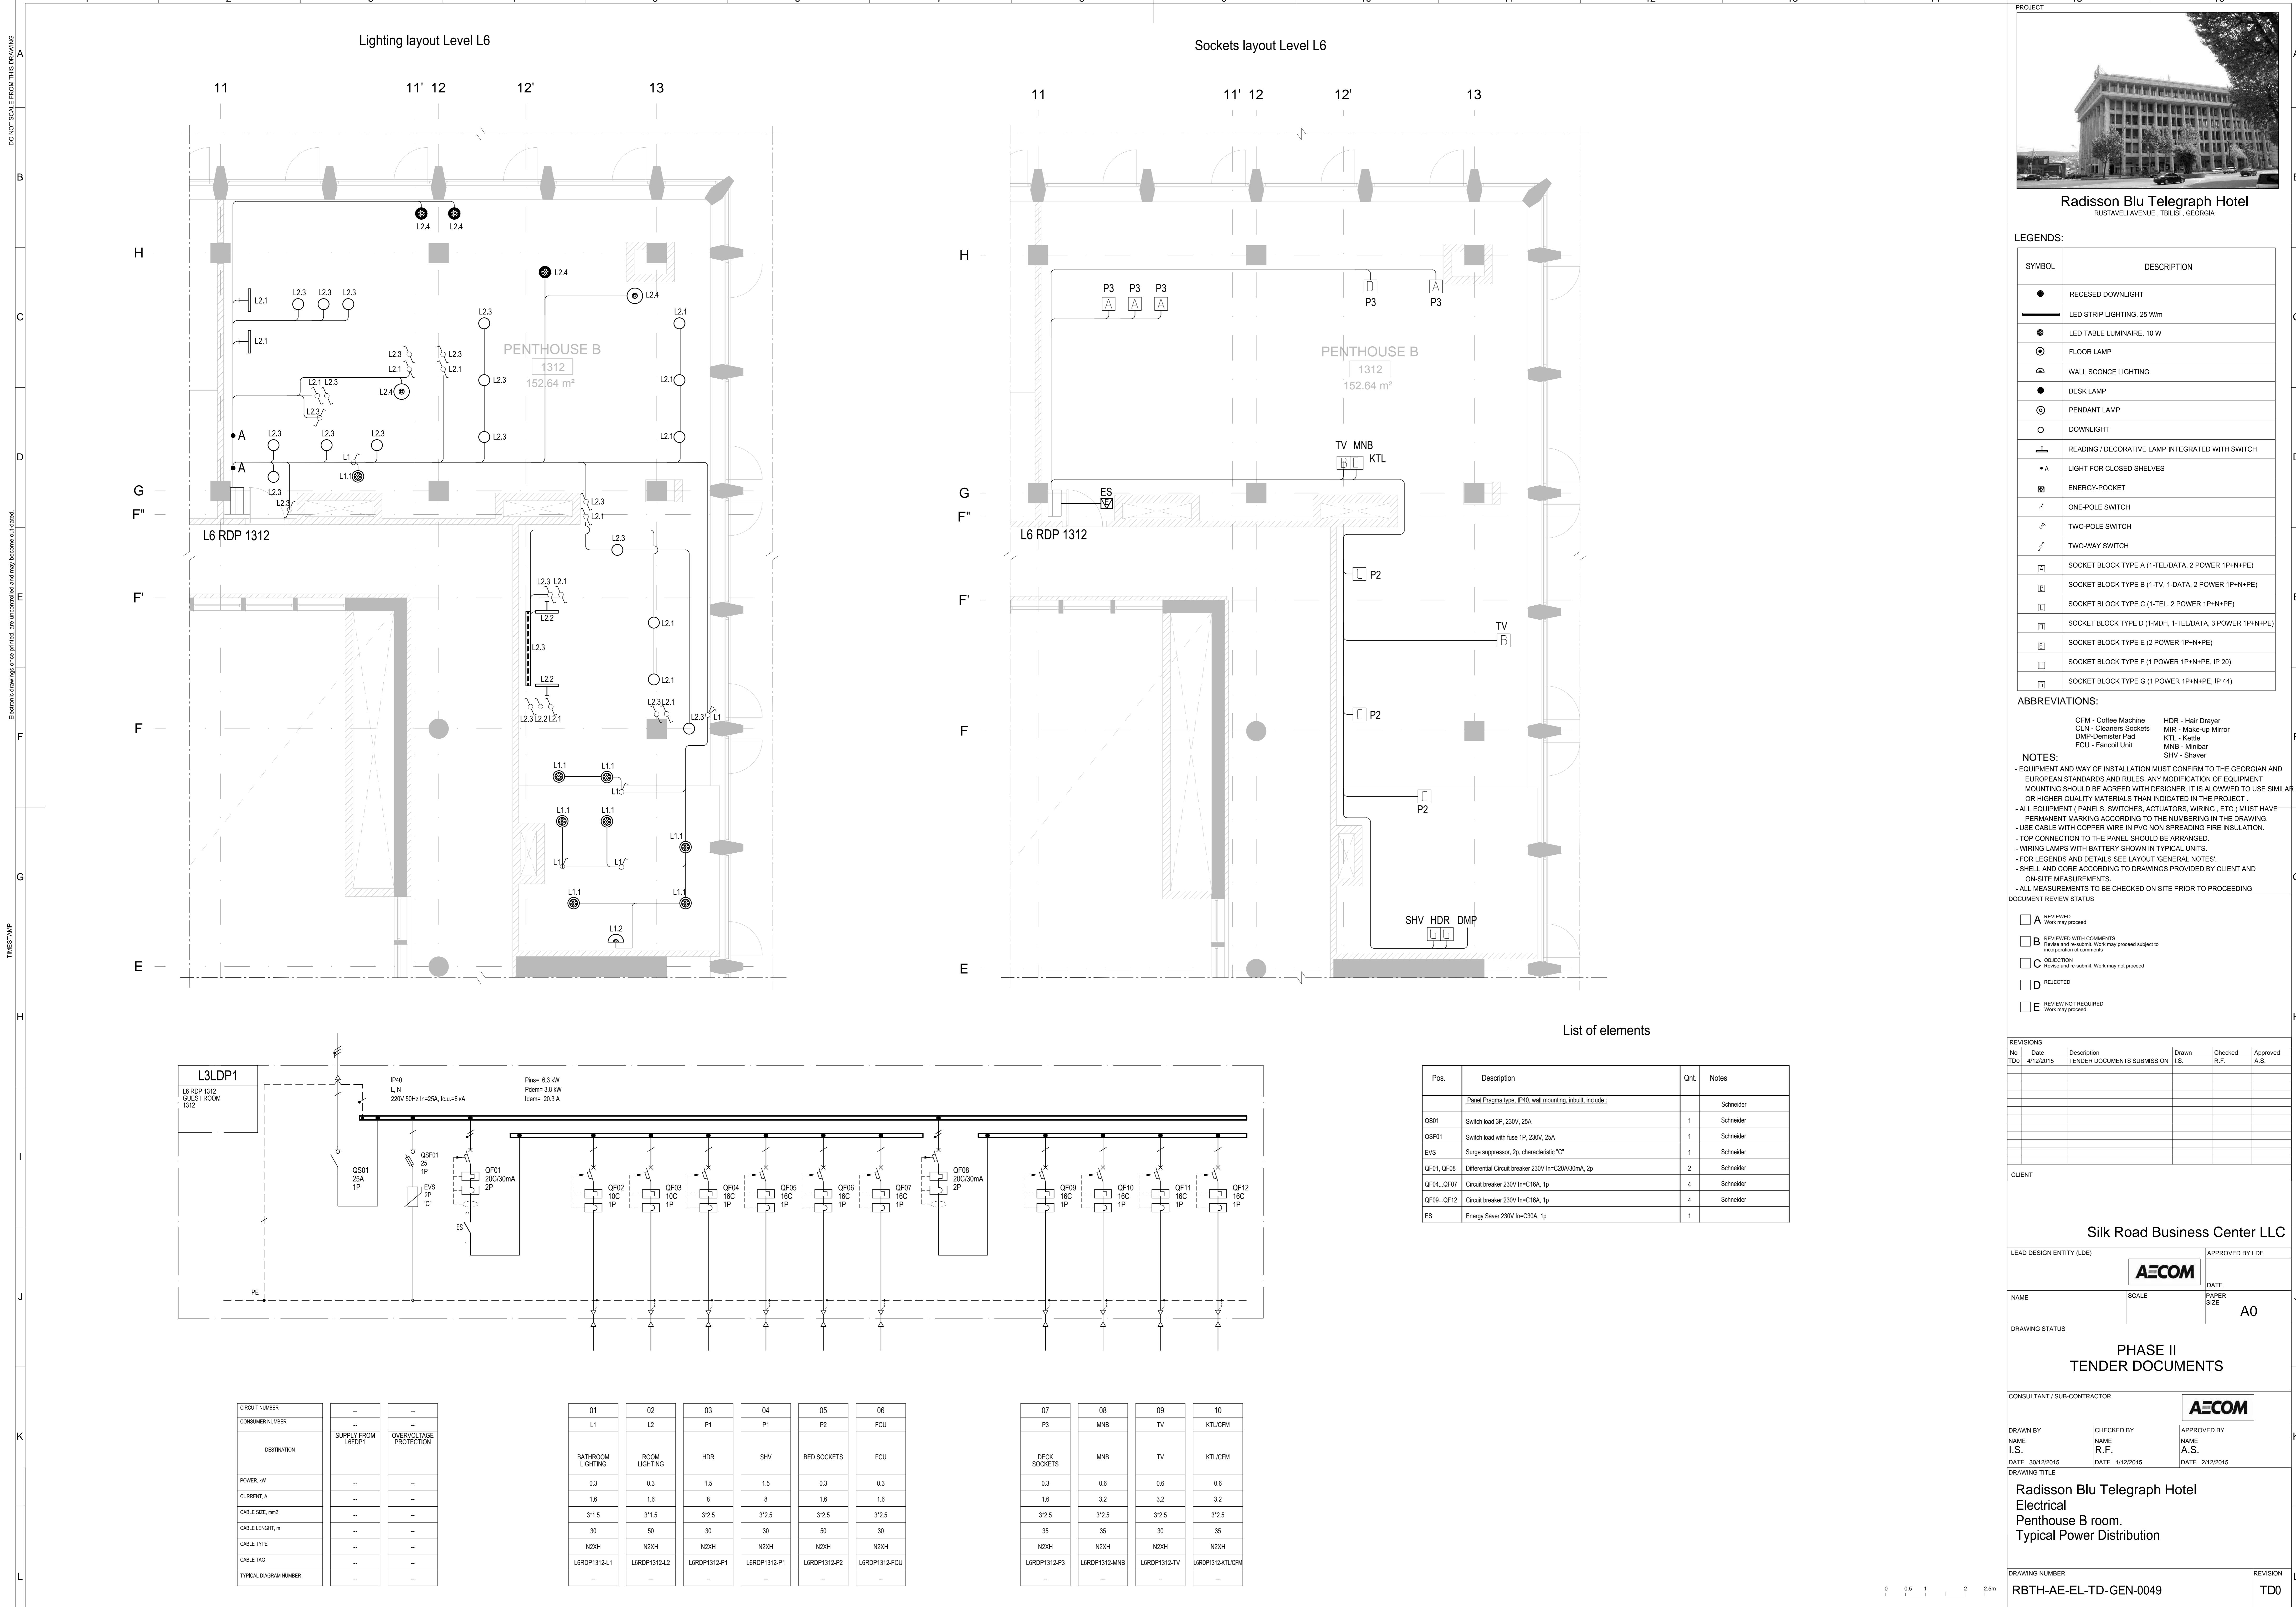

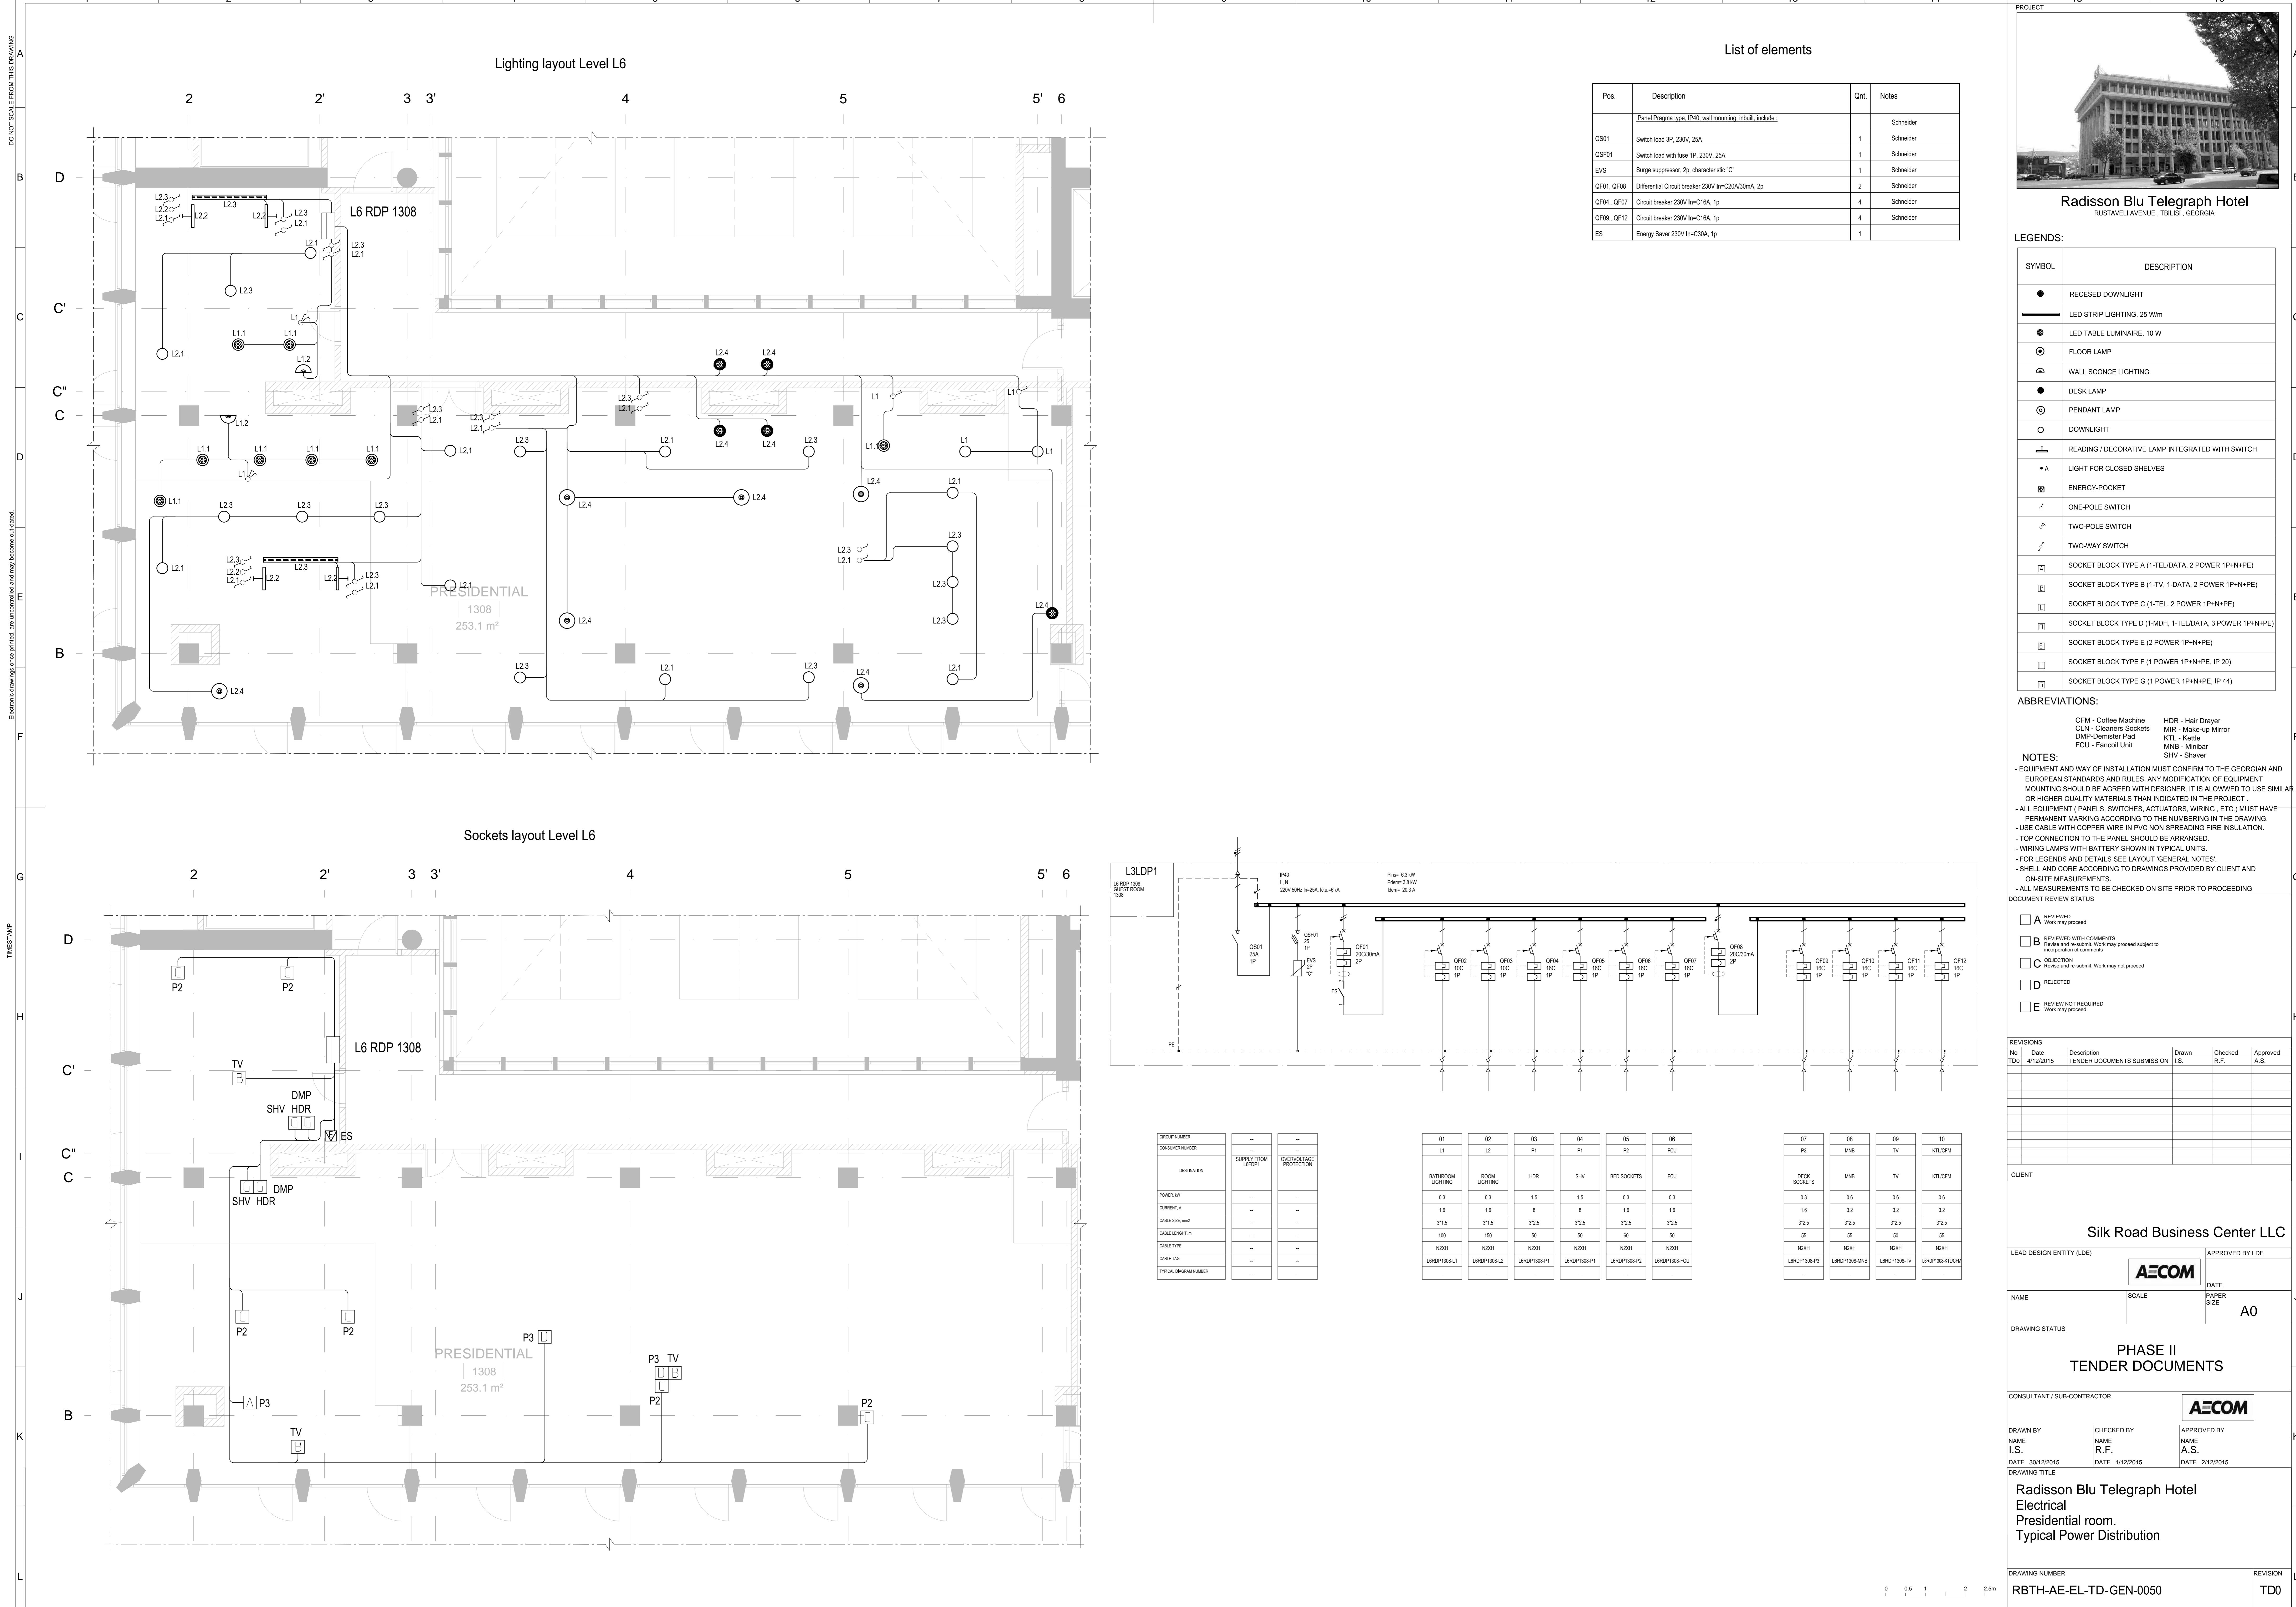

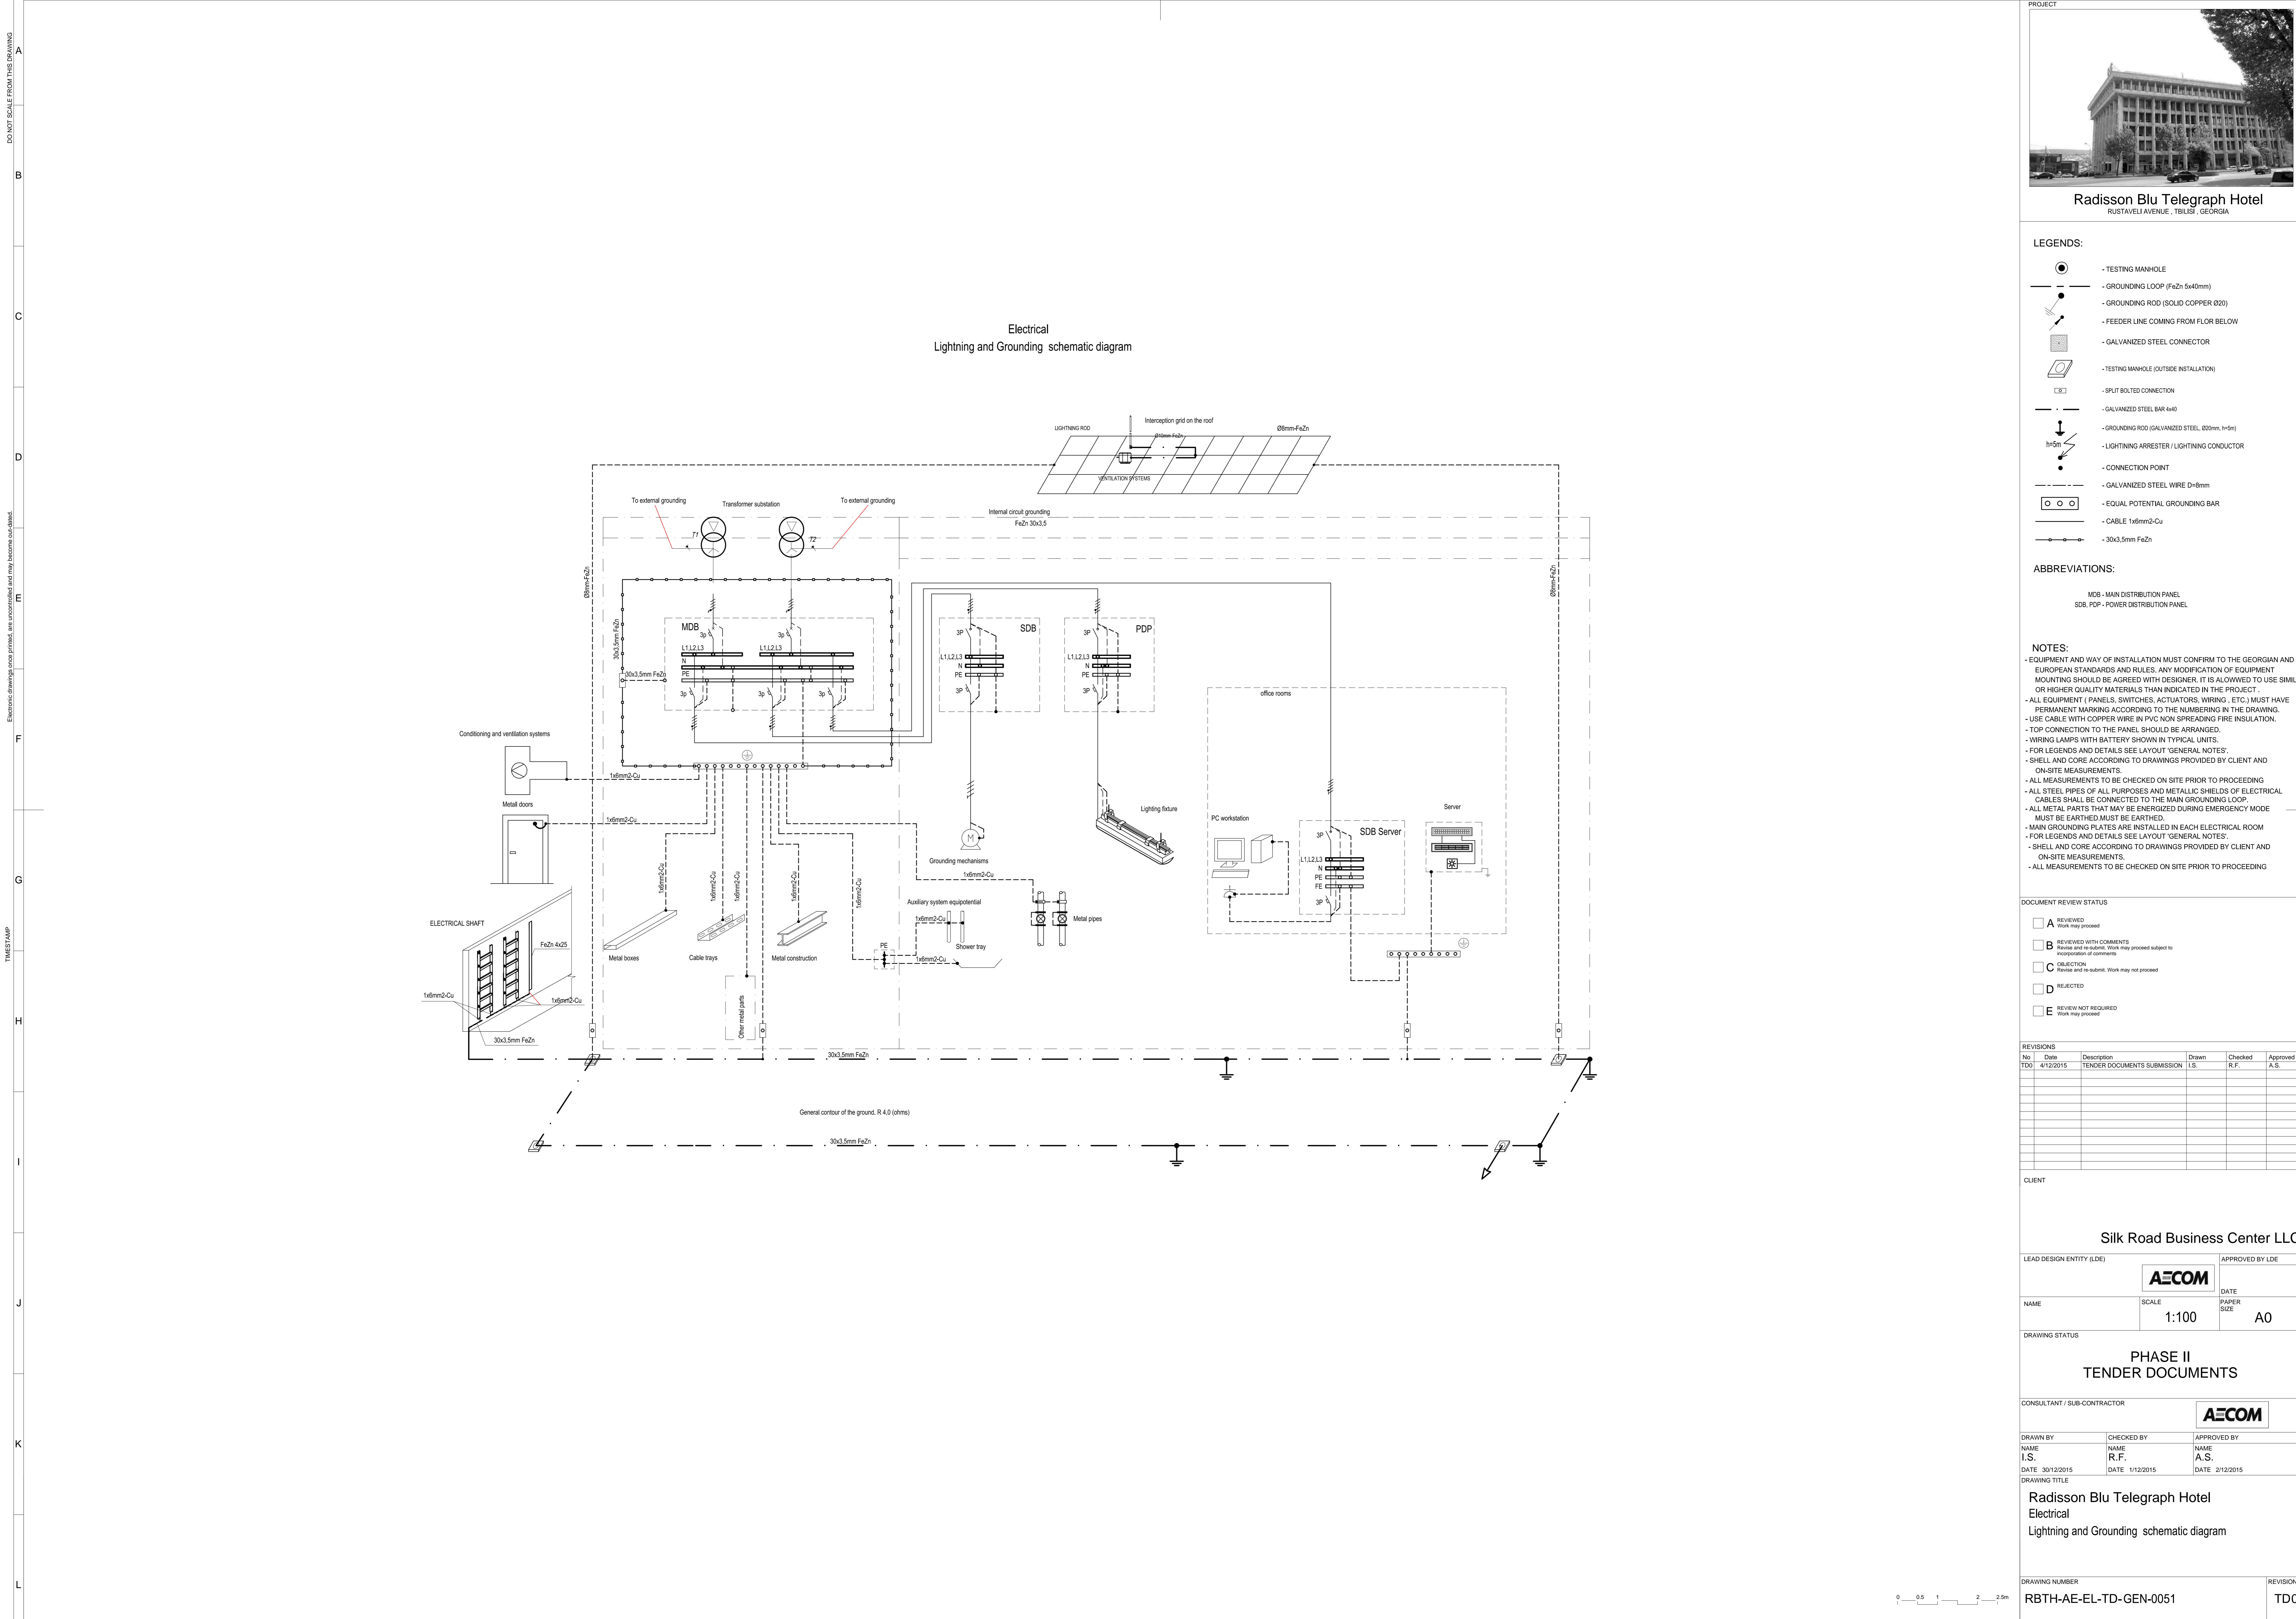

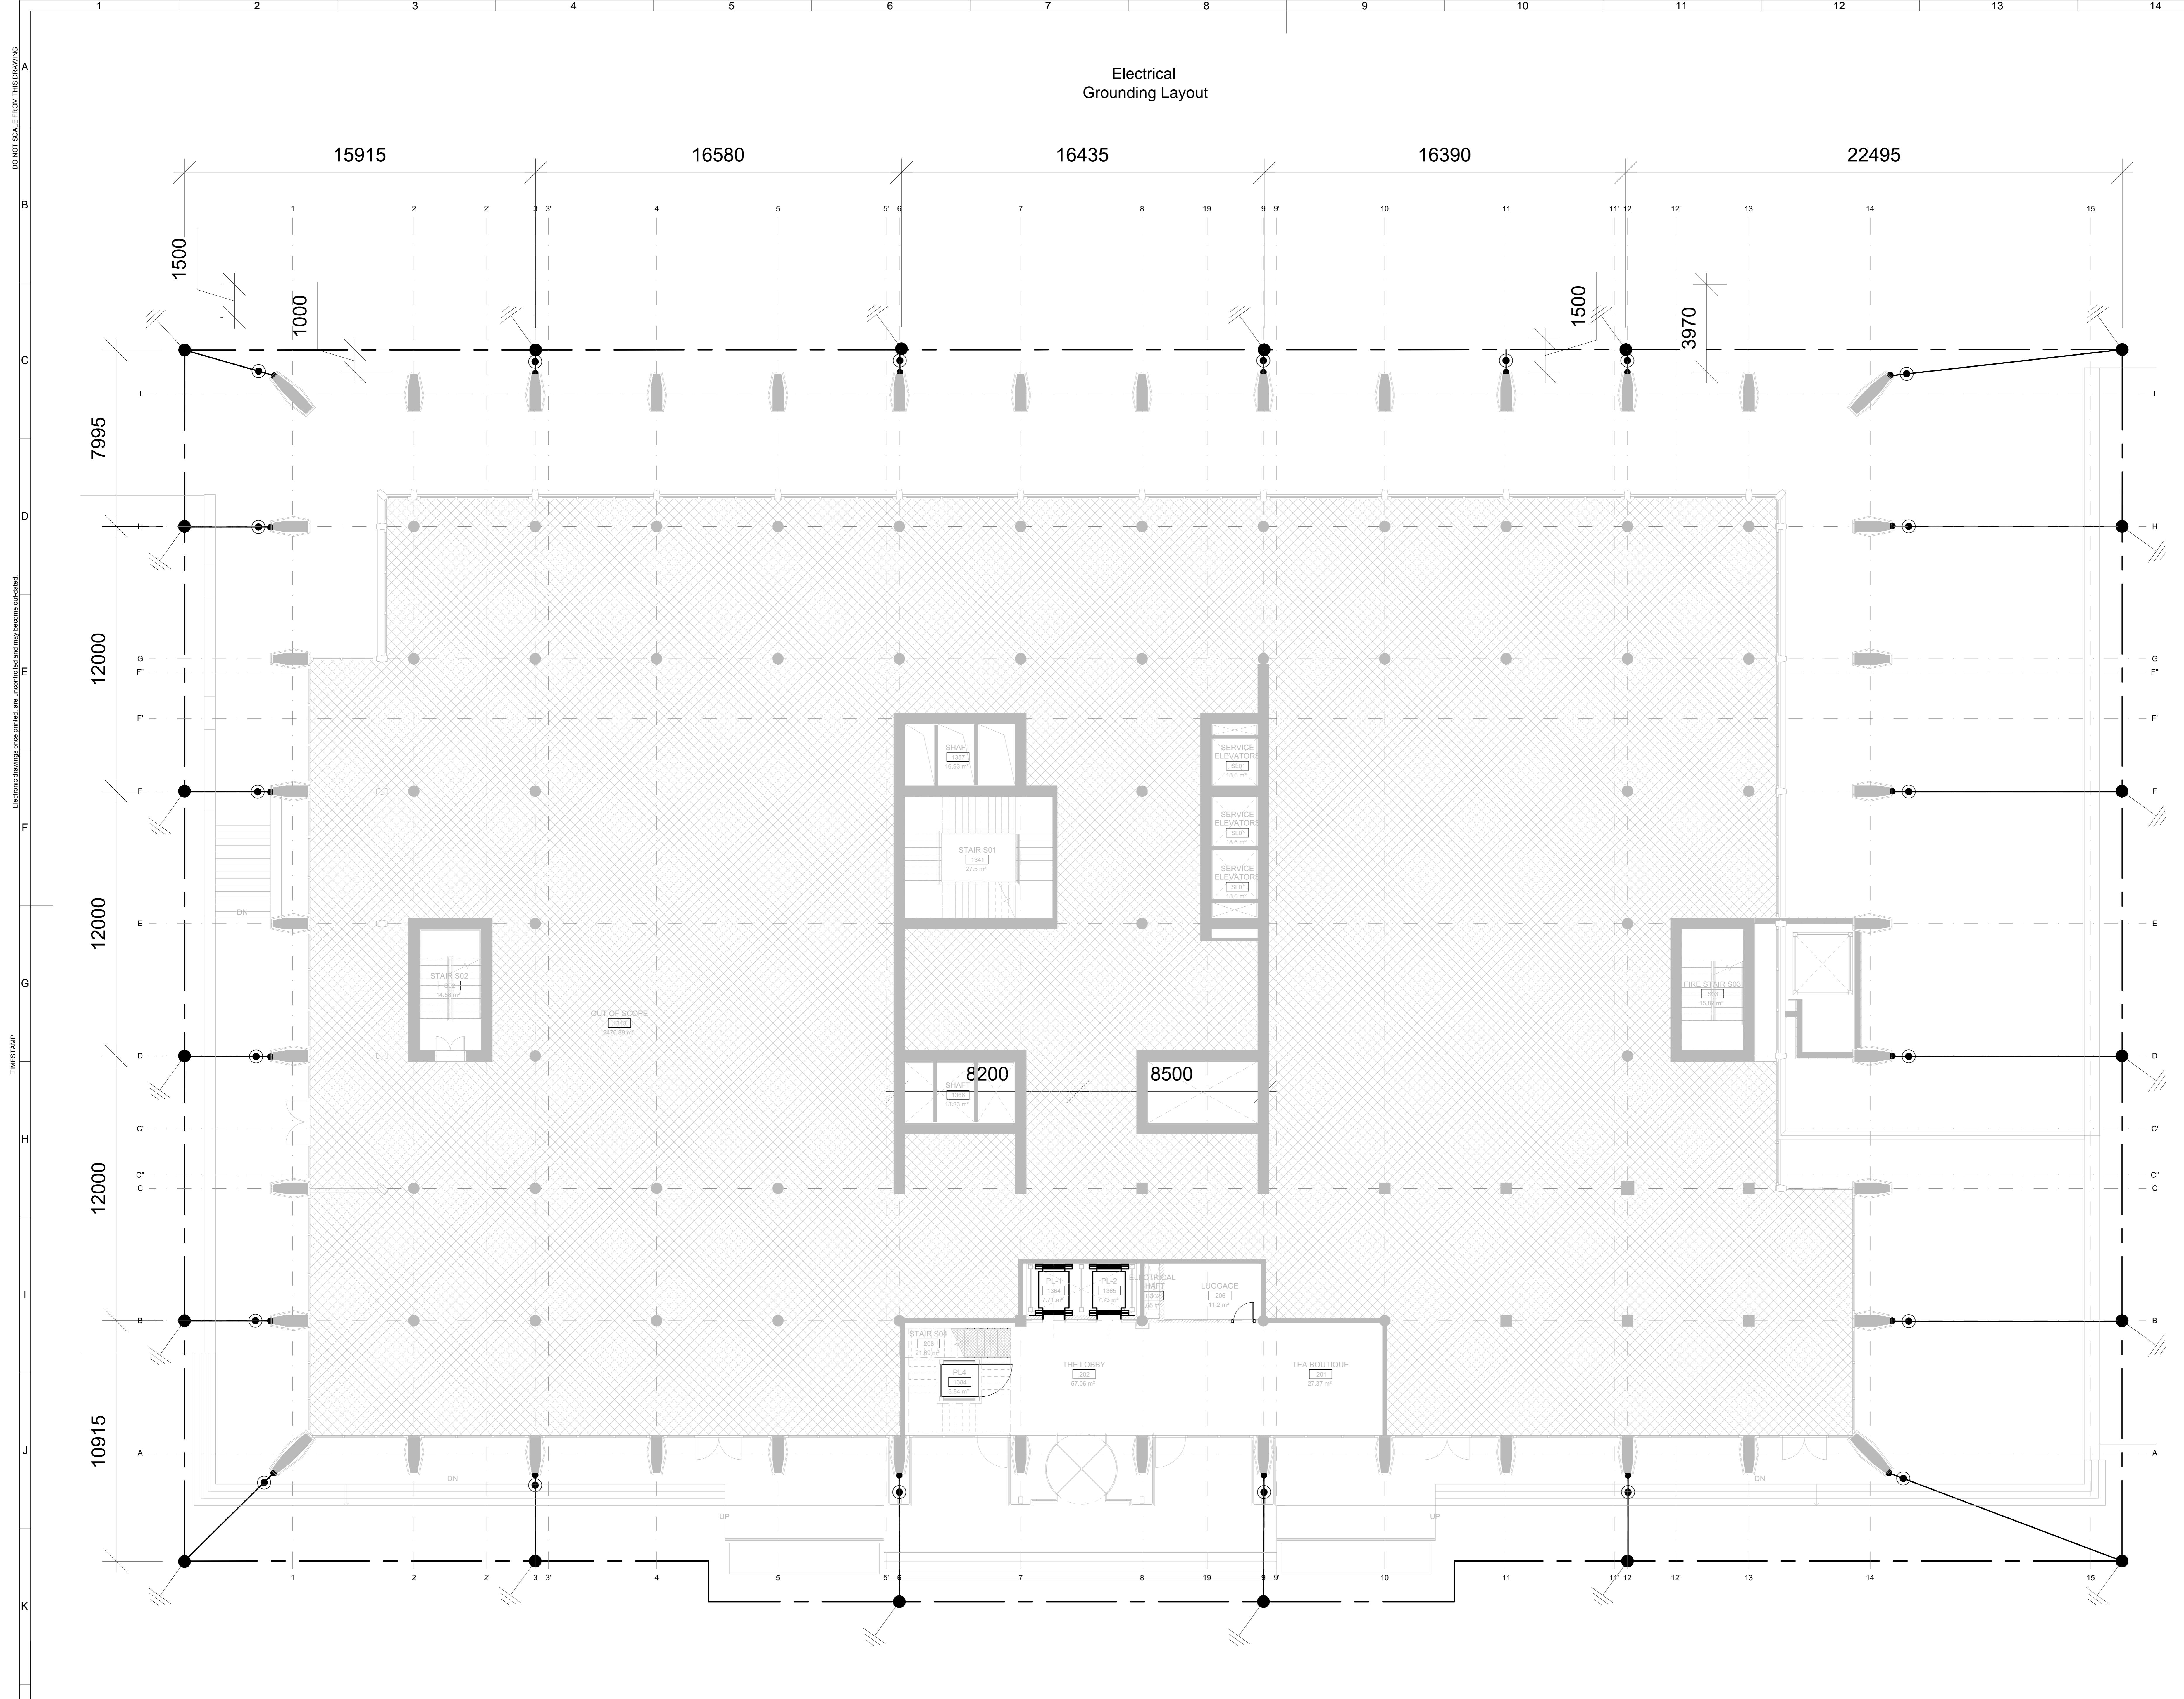

# Radisson Blu Telegraph Hotel

RUSTAVELI AVENUE , TBILISI , GEORGIA

## LEGENDS:

- TESTING MANHOLE
  - GROUNDING LOOP (FeZn 5x40mm)
  - GROUNDING ROD (SOLID COPPER Ø20)
  - FEEDER LINE COMING FROM FLOR BELOW
  - GALVANIZED STEEL CONNECTOR
  - TESTING MANHOLE (OUTSIDE INSTALLATION)
  - SPLIT BOLTED CONNECTION
  - GALVANIZED STEEL BAR 4x40
  - GROUNDING ROD (GALVANIZED STEEL, Ø20mm, h=5m)
  - LIGHTNING ARRESTER / LIGHTNING CONDUCTOR
  - CONNECTION POINT
  - GALVANIZED STEEL WIRE D=8mm
  - EQUAL POTENTIAL GROUNDING BAR
  - CABLE 1x6mm<sup>2</sup>-Cu
  - 30x3,5mm FeZn

## ABBREVIATIONS:

MDB - MAIN DISTRIBUTION PANEL  
SDB, PDP - POWER DISTRIBUTION PANEL

OTES:  
STEEL PIPES

- FILES OF ALL PURPOSES AND METALLIC SHELLS OF ELECTRICAL  
SHALL BE CONNECTED TO THE BUILDING GROUNDING LOOP AT THE POINT  
CE TO THE BUILDING.

NDING SYSTEM CONNECTIONS SHALL BE MADE BY EXOTHERMIC  
, CLIPPING, BOLTING OR ANOTHER APPROVED METHOD.

ONAL CONNECTIONS IN GROUND IT IS NECESSARY TO USE PLASTIC  
ON PROTECTION STRIP.

NDING SYSTEM CONNECTIONS SHALL BE EASILY ACCESSIBLE FOR  
ON AND MAINTENANCE.

RUCTION AND PARTS OF FIXED EQUIPMENT THAT ARE LIKELY TO  
ENERGIZED DURING ABNORMAL CONDITION SHALL BE BONDED AND  
ED.

ONS BETWEEN EQUIPMENT AND GROUNDING CONDUCTORS SHALL BE  
LUGS ATTACHED TO EQUIPMENT BY MEANS OF BOLTS. ELEMENTS OF  
NT WHICH ARE NOT DESIGNED FOR GROUNDING COULD NOT BE USED.

NDING CABLES IN LOCATIONS WHERE SUBJECT TO MECHANICAL  
SHALL BE PROTECTED BY RIGID METALLIC CONDUIT.  
ON.

PPER CONNECTORS ARE BOLTED TO STEEL SURFACES OF EQUIPMENT  
OR ENCLOSURES, THE CONTACT SURFACES SHALL BE PERMANENTLY  
EFORE ASSEMBLY AND SECURED WITH WASHERS AND NUTS.

-TO-ALUMINIUM AND COPPER-TO-GALVANIZED CONNECTIONS SHALL  
MATERIALS TO PREVENT GALVANIC CORROSION.

THE LIST AND THE LIGHTING PROTECTION LAYOUT.

OWN HAS TO BE PERFORMED UNDER THE COLUMN VENEERING.  
NDS AND DETAILS SEE LAYOUT 'TYPICAL DETAILS'.

CORE ACCORDING TO DRAWINGS PROVIDED BY CLIENT AND  
MEASUREMENTS.

IREMENTS TO BE CHECKED ON SITE PRIOR TO PROCEEDING

## MENT REVIEW STATUS

- /IEWED  
Work may proceed
  - /IEWED WITH COMMENTS  
rise and re-submit. Work may proceed subject to  
orporation of comments
  - JECTION  
rise and re-submit. Work may not proceed
  - JECTED
  - /IEW NOT REQUIRED

Silk Road Business Center LLC

ENTITY (LDE)

**ALCOM** DATE  
SCALE PAPER

1:100 SIZE A0

# PHASE II TENDER DOCUMENTS

ULTANT / SUB-CONTRACTOR

NAME R.F.	NAME A.S.
DATE 1/12/2015	DATE 2/12/2015

### **Blattomat**


# adisson Blu Telegraph Hotel electrical


ical  
nding Layout

BER | REV

**TH-AE-EL-TD-GEN-0052** TD0

15 | Page


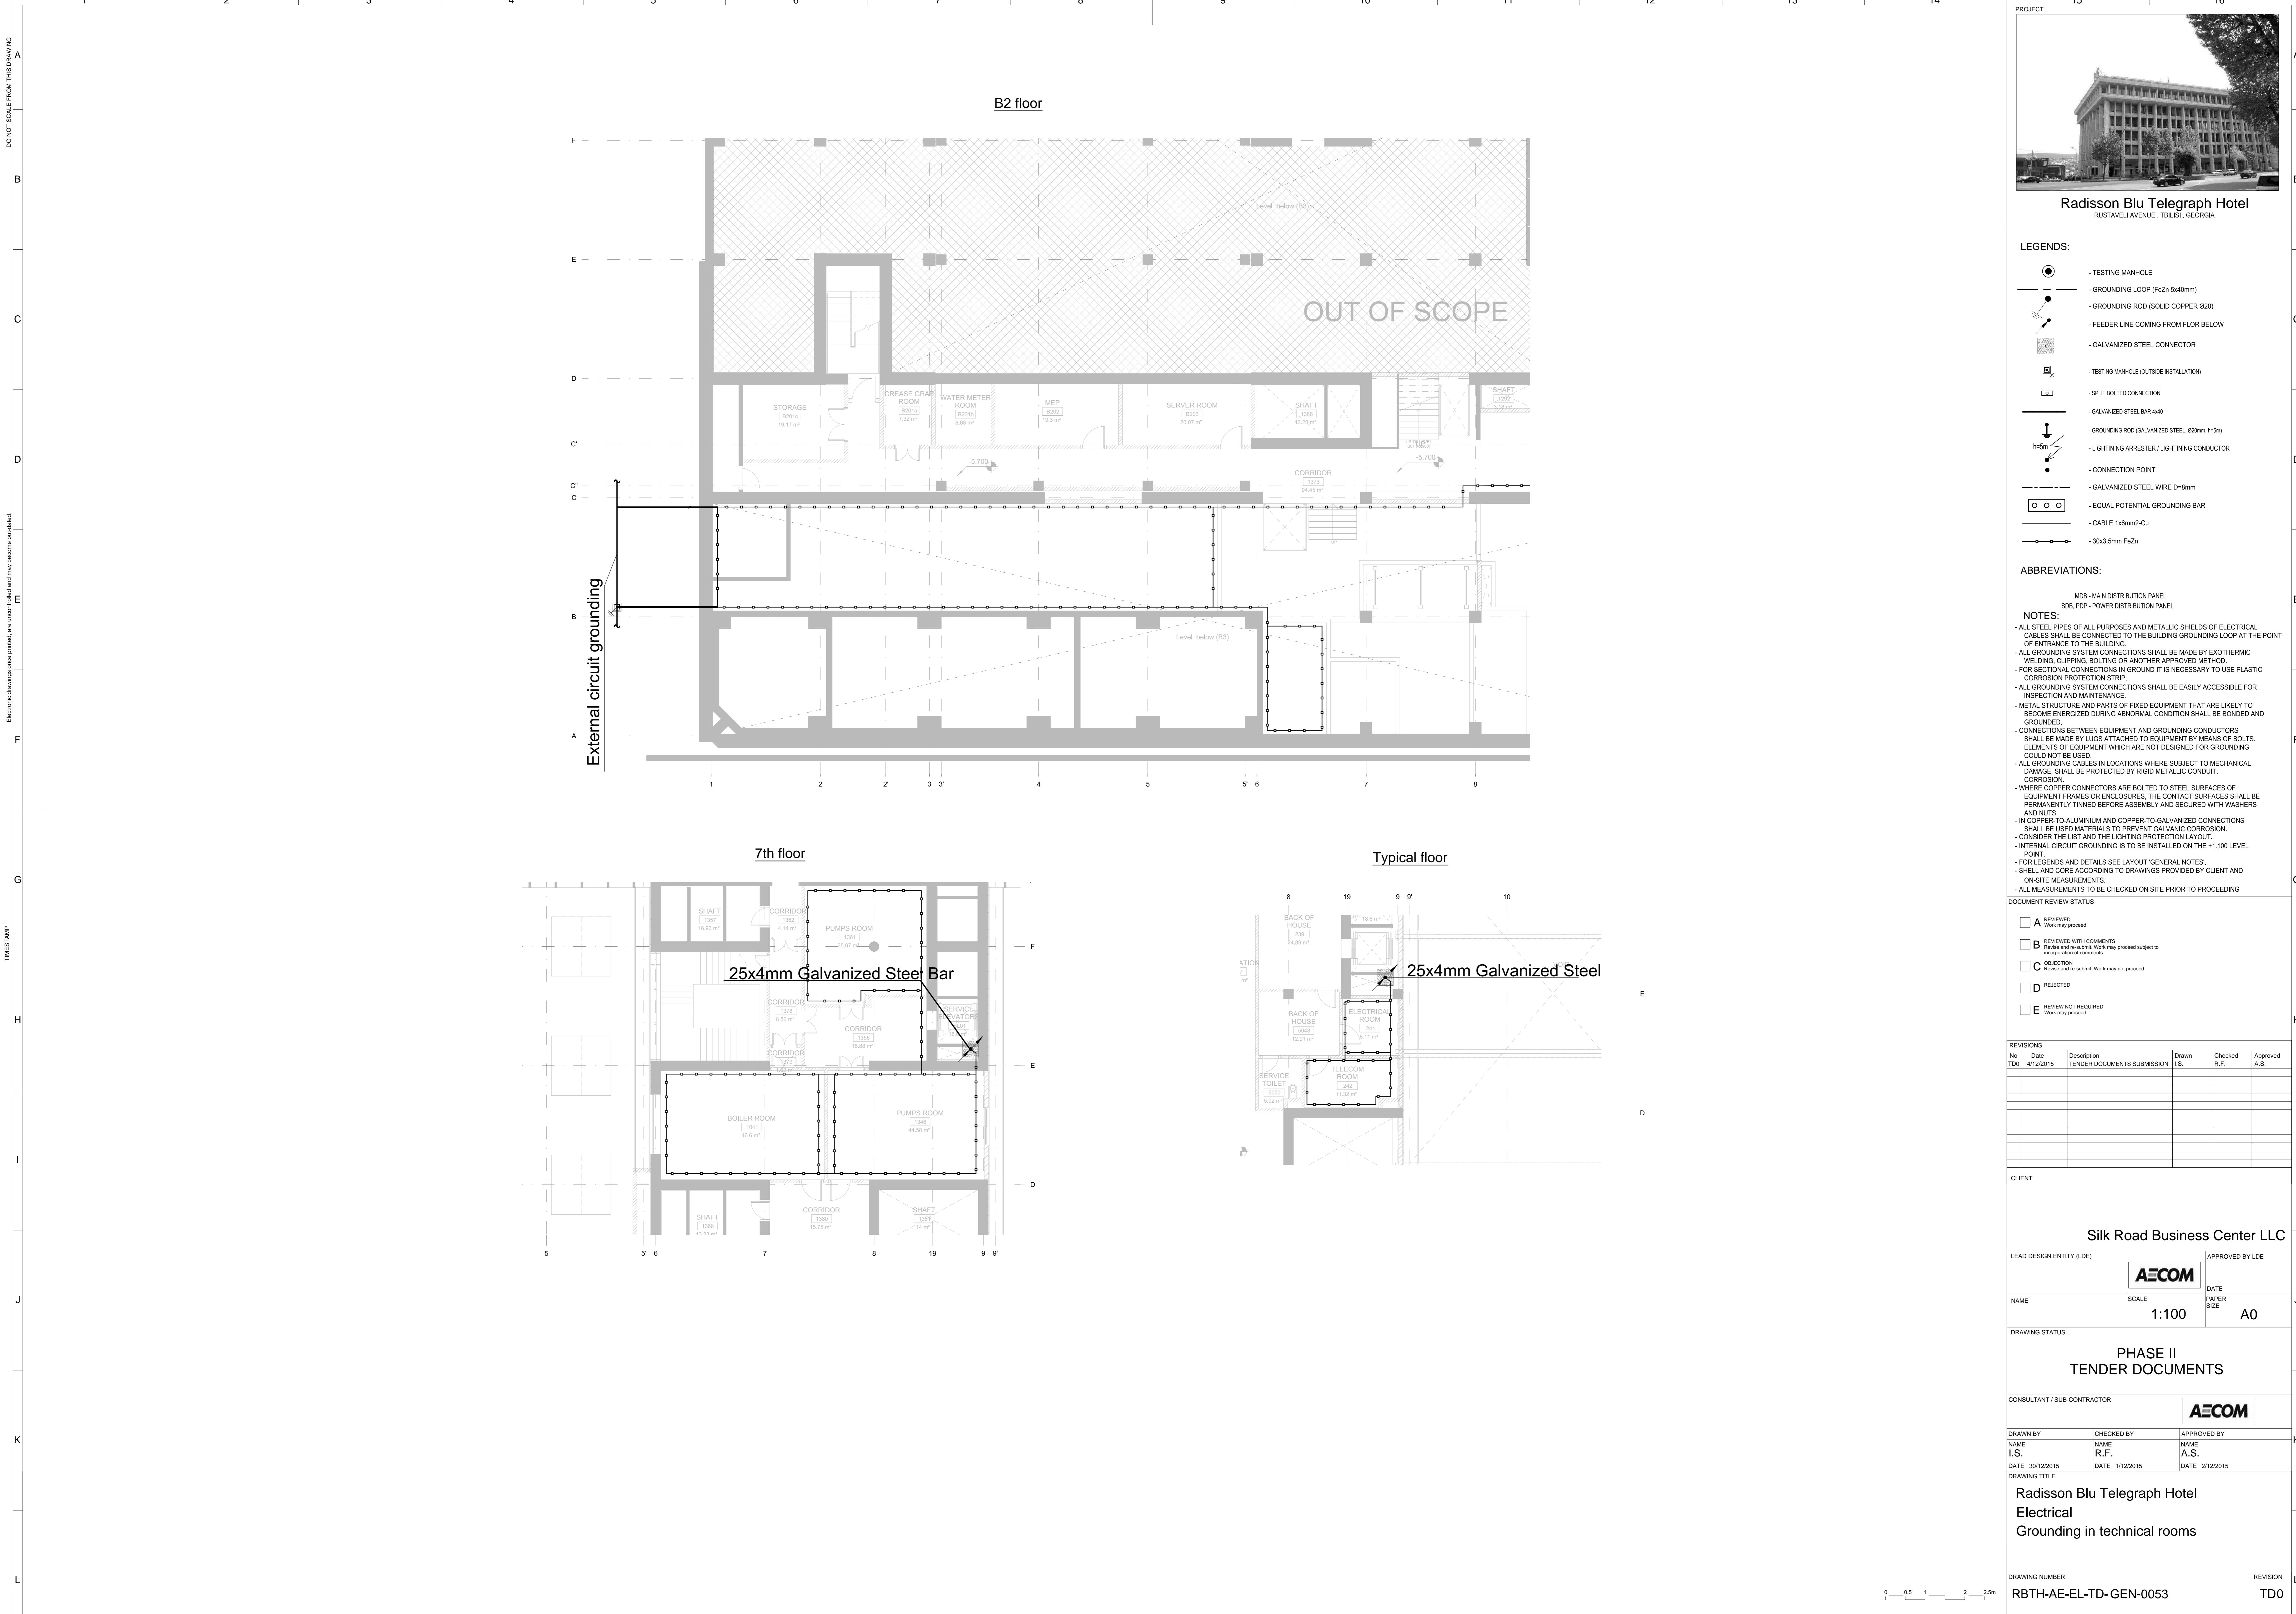


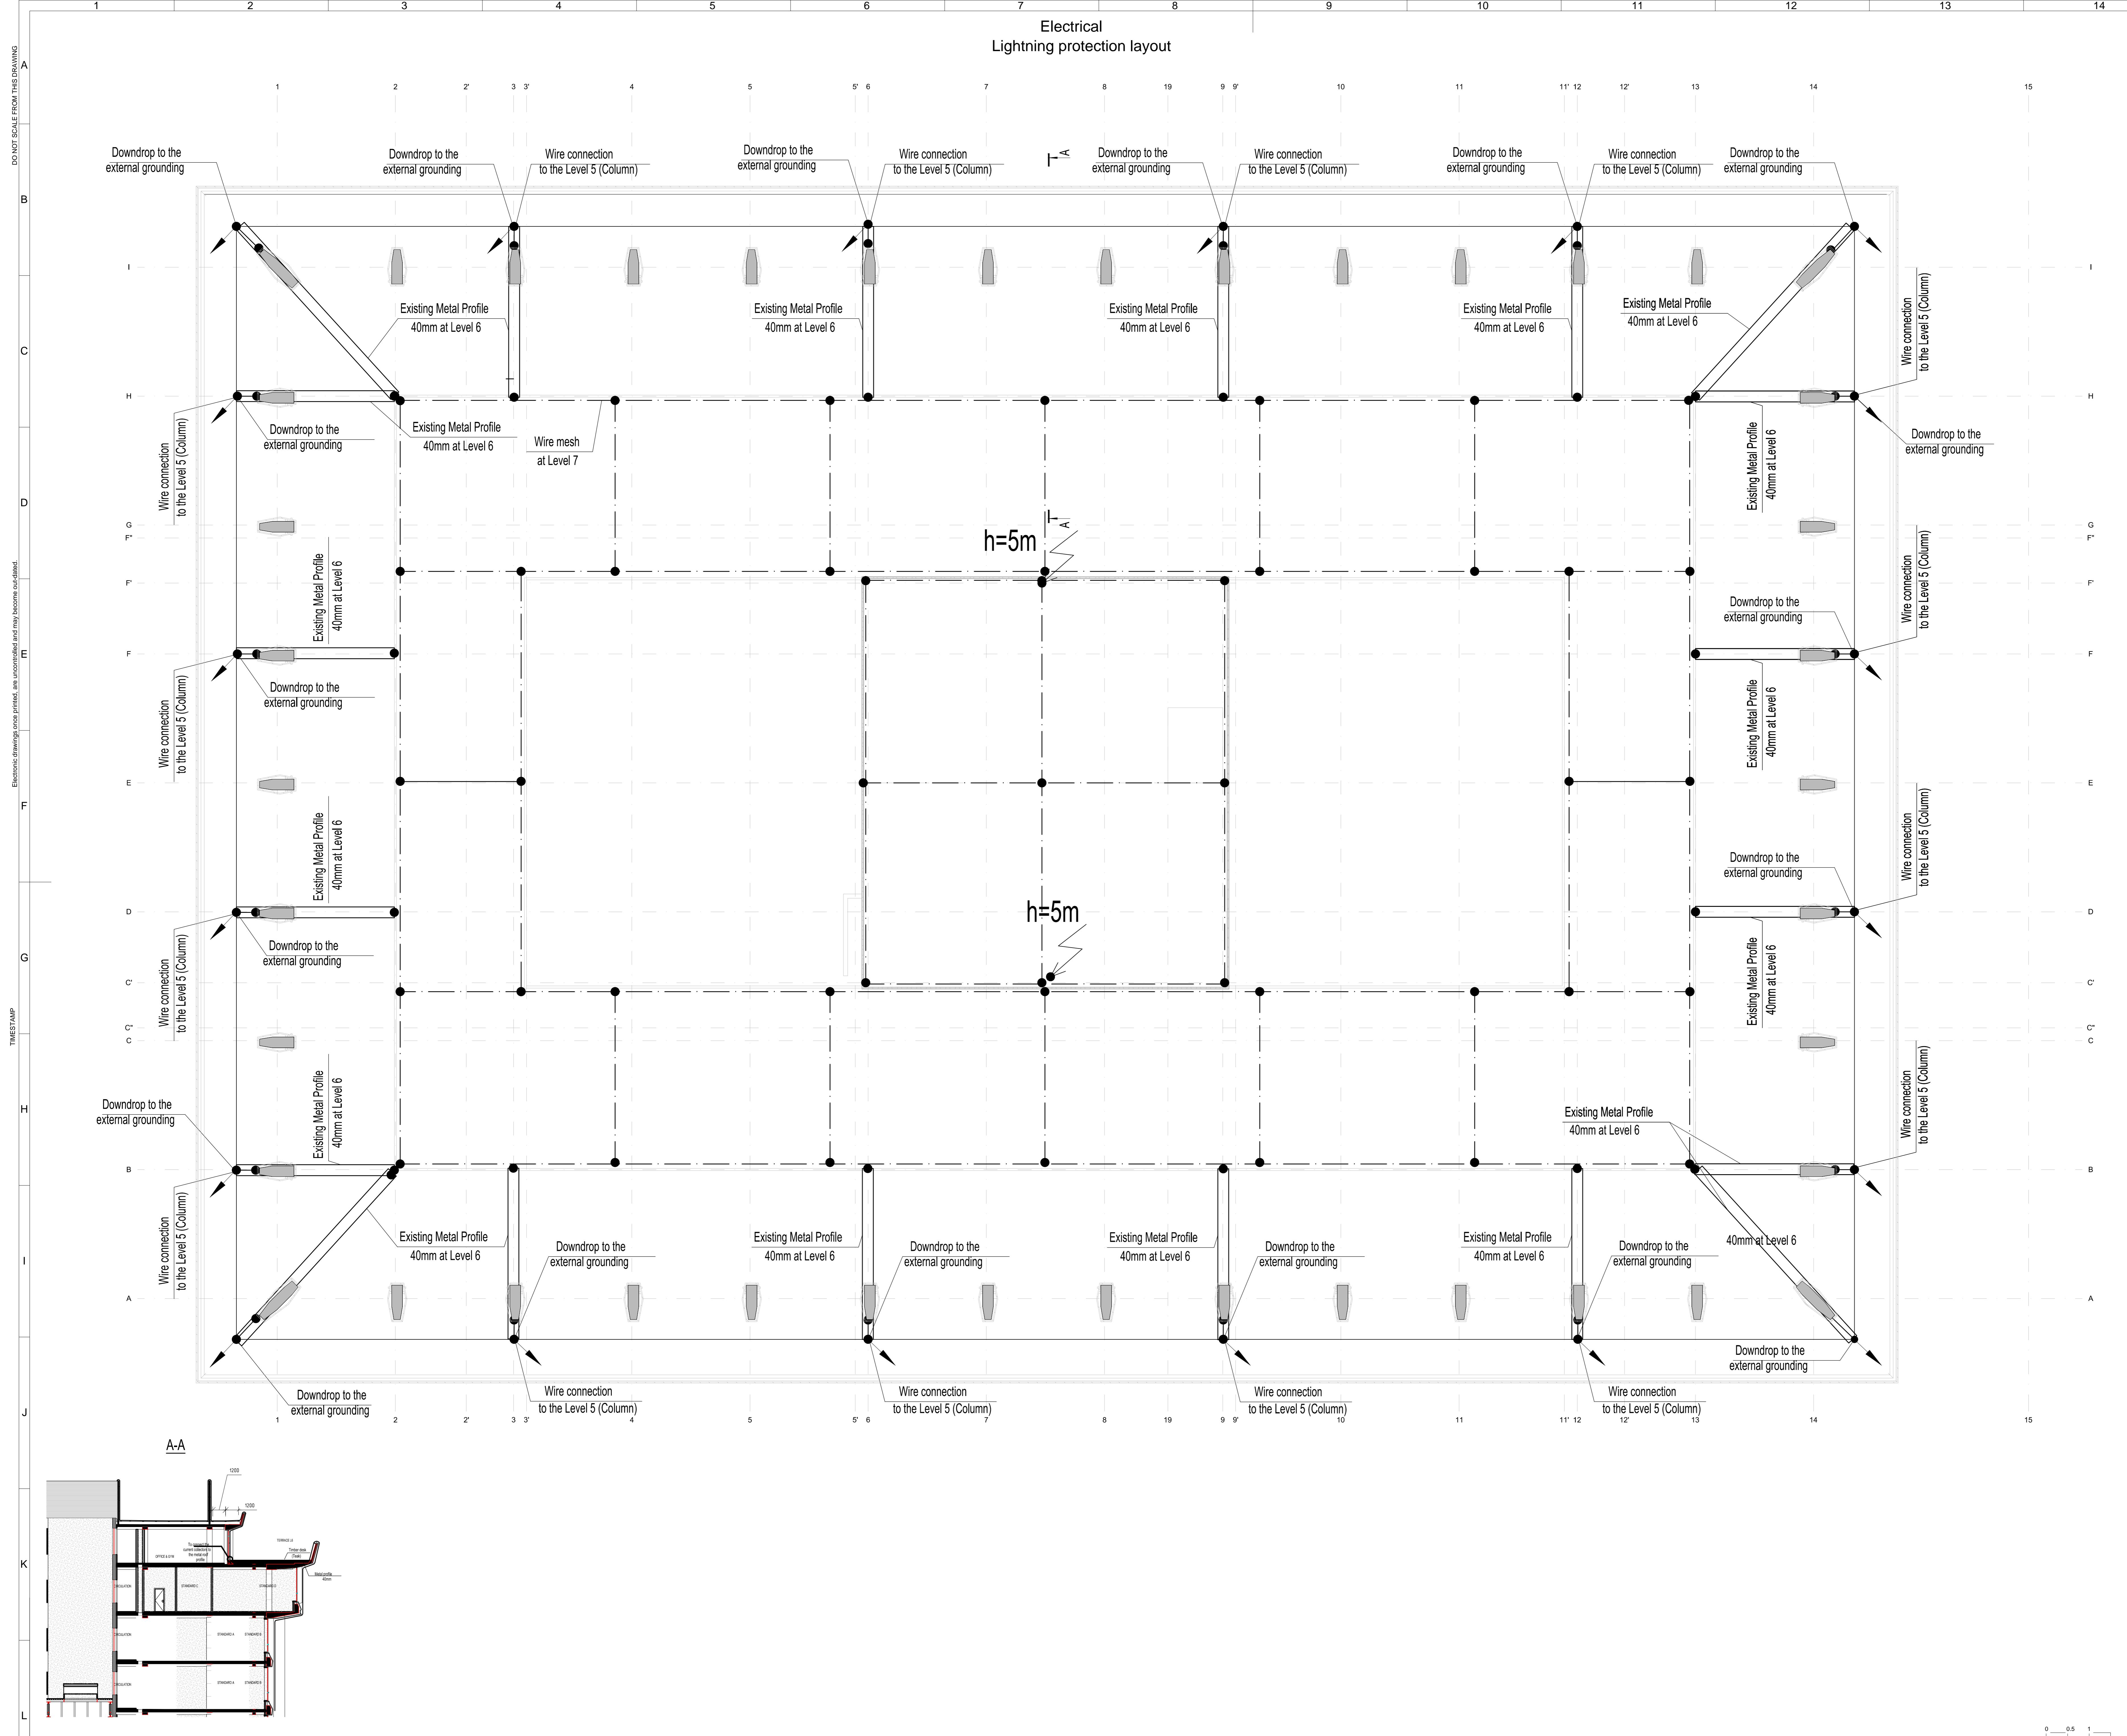

# Radisson Blu Telegraph Hotel

RUSTAVELI AVENUE , TBILISI , GEORGIA

## LEGENDS:

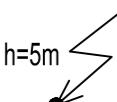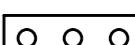- TESTING MANHOLE
  - GROUNDING LOOP (FeZn 5x40mm)
  - GROUNDING ROD (SOLID COPPER Ø20)
  - FEEDER LINE COMING FROM FLOR BELOW
  - GALVANIZED STEEL CONNECTOR
  - TESTING MANHOLE (OUTSIDE INSTALLATION)
  - SPLIT BOLTED CONNECTION
  - GALVANIZED STEEL BAR 4x40
  - GROUNDING ROD (GALVANIZED STEEL, Ø20mm, h=5m)
  - MDB - MAIN DISTRIBUTION PANEL
  - SDB, PDP - POWER DISTRIBUTION PANEL
  -  - LIGHTINING ARRESTER / LIGHTINING CONDUCTOR
  -  - CONNECTION POINT
  - GALVANIZED STEEL WIRE D=8mm
  -  - EQUAL POTENTIAL GROUNDING BAR

**NOTES:**

- ALL STEEL PIPES OF ALL PURPOSES AND METALLIC SHIELDS OF ELECTRICAL CABLES SHALL BE CONNECTED TO THE BUILDING GROUNDING LOOP AT THE POINT OF ENTRANCE TO THE BUILDING.
- ALL GROUNDING SYSTEM CONNECTIONS SHALL BE MADE BY EXOTHERMIC WELDING, CLIPPING, BOLTING OR ANOTHER APPROVED METHOD.
- FOR SECTIONAL CONNECTIONS IN GROUND IT IS NECESSARY TO USE PLASTIC CORROSION PROTECTION STRIP.
- ALL GROUNDING SYSTEM CONNECTIONS SHALL BE EASILY ACCESSIBLE FOR INSPECTION AND MAINTENANCE.
- METAL STRUCTURE AND PARTS OF FIXED EQUIPMENT THAT ARE LIKELY TO BECOME ENERGIZED DURING ABNORMAL CONDITION SHALL BE BONDED AND GROUNDED.
- CONNECTIONS BETWEEN EQUIPMENT AND GROUNDING CONDUCTORS SHALL BE MADE BY LUGS ATTACHED TO EQUIPMENT BY MEANS OF BOLTS. ELEMENTS OF EQUIPMENT WHICH ARE NOT DESIGNED FOR GROUNDING COULD NOT BE USED.
- ALL GROUNDING CABLES IN LOCATIONS WHERE SUBJECT TO MECHANICAL DAMAGE, SHALL BE PROTECTED BY RIGID METALLIC CONDUIT.
- WHERE COPPER CONNECTORS ARE BOLTED TO STEEL SURFACES OF EQUIPMENT FRAMES OR ENCLOSURES, THE CONTACT SURFACES SHALL BE PERMANENTLY TINNED BEFORE ASSEMBLY AND SECURED WITH WASHERS AND NUTS.
- IN COPPER-TO-ALUMINIUM AND COPPER-TO-GALVANIZED CONNECTIONS SHALL BE USED MATERIALS TO PREVENT GALVANIC CORROSION.
- CONSIDER THE LIST AND THE GROUNDING.
- THIS SHEET IS TO BE VIEWED ALONG WITH LIGHTNING PROTECTION LAYOUT
- FOR LEGENDS AND DETAILS SEE LAYOUT 'GENERAL NOTES'.
- SHELL AND CORE ACCORDING TO DRAWINGS PROVIDED BY CLIENT AND ON-SITE MEASUREMENTS.
- ALL MEASUREMENTS TO BE CHECKED ON SITE PRIOR TO PROCEEDING

**DOCUMENT REVIEW STATUS**

- A** REVIEWED  
Work may proceed
  - B** REVIEWED WITH COMMENTS  
Revise and re-submit. Work may proceed subject to incorporation of comments
  - C** OBJECTION  
Revise and re-submit. Work may not proceed
  - D** REJECTED
  - E** REVIEW NOT REQUIRED  
Work may proceed

## REVISIONS

Silk Road Business Center LLC

LEAD DESIGN ENTITY (LDE) | APPROVED BY LDE

AECOM

**DATE**

NAME \_\_\_\_\_ SCALE \_\_\_\_\_ PAPER SIZE \_\_\_\_\_  
1:100 A0

DRAWING STATUS

PHASE II

## PHASE II TENDER DOCUMENTS

## PENDEKAN

CONSULTANT / SUB-CONTRACTOR

**AECOM**

DRAWN BY	CHECKED BY	APPROVED BY
NAME	NAME	NAME

I.S.	R.F.	A.S.
DATE_ 20/12/2015	DATE_ 1/12/2015	DATE_ 2/12/2015

DATE 30/12/2015	DATE 1/12/2015	DATE 2/12/2015
DRAWING TITLE		

Radisson Blu Telegraph Hotel

## Electrical

## Lightning protection layout

DRAWING NUMBER: \_\_\_\_\_ DIVISION: \_\_\_\_\_

**DRAWING NUMBER** BRTA AE EL TD GEN 0054 **REVISION** TD0

KBTH-AE-EL-1D-GEN-0054 1D0

15 16

